ATM Queuing Study

Site Under Study Santa Rita & Old Santa Rita

Pleasanton, CA

Intended Use Drive Up ATM

Primary ATM Contact Cameryn Erickson

Cameryn.Erickson@Chase.com

650-244-9364



Overview


- Purpose of Study
 - Understand the average queue length and wait times experienced by Chase customers at stand-alone drive-up ATMs
 - Using advanced queuing simulation, to project the expected queue length and stacking requirement for Santa Rita & Old Santa Rita, and to demonstrate that there will not be an adverse impact to traffic flow in the parking lot




- Methodology
 - A study of 118 stand-alone, drive-up ATMs accounting for 4.8mm annual transactions majority are in shopping centers and retail environments
 - ATMs split into 6 tiers:

	Transactions
Tier	per Month
1	less than 2,000
2	2,000 to 2,999
3	3,000 to 3,999
4	4,000 to 4,999
5	5,000 to 6,999
6	7,000+

Determine the peak hour as basis for maximum queue experienced

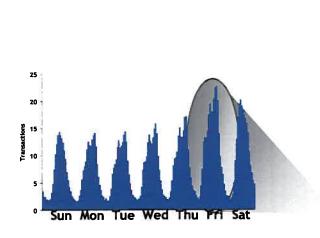

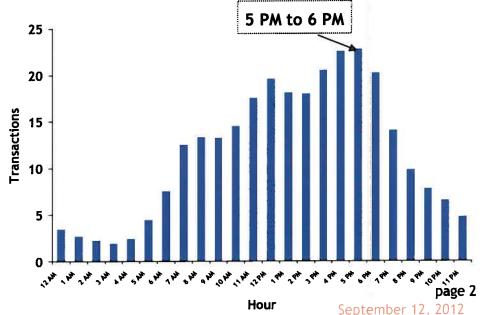

CHASE 🗘

DECISION ANALYTICS

Queuing Simulation

- Uses peak hour in each tier for the interarrival times (Friday, 5 p.m.)
- Service times based on time-in-motion studies of Chase ATM transactions actual experience is 45 seconds; conservatively assume 1 minute
- Does not assume that transactions are evenly distributed, but are random events, which is a more accurate reflection of stacking requirements
- Simulation Model to determines:

Expected queue length

Maximum queue length

Expected time in queue

Expected time in system

ATM utilization

Probability of various queue lengths

■ Model Validity

Simulates historical transactions from 3 pm to 5 pm as a "warm-up". Then simulates the peak hour from 5 pm to 6 pm

■ Model Inputs >>

	Transactions	Peak Arrivals	Interarrival	Service
Tier	per Month	Per Hr	Time	Time
1	less than 2,000	7.89	7.61 min	1 min
2	2,000 to 2,999	10.93	5.49 min	1 min
3	3,000 to 3,999	14.91	4.03 min	1 min
4	4,000 to 4,999	19.64	3.05 min	1 min
5	5,000 to 6,999	23.43	2.56 min	1 min
6	7,000+	32.03	1.87 min	1 min



DECISION ANALYTICS

Simulation Results and Recommendation

■The table below displays the overall results:

Tier	Avg Q Length (Cars)	Max Q Length (Cars)*	Avg Time in Queue (min)	Avg Time in System (min)	ATM Utilization
1	0.02	2	0.11	1.15	13%
2	0.04	4	0.17	1.16 ∈	18%
3	0.07	5	0.25	1 25	24%
4	0.14	6	0.40	1.41	33%
5	0.26	10	0.59	1.56	38%
6	0.63	10	1.11	2.10	53%

■ The table below displays the probability of observing a certain # of cars in queue by tier.

- The ATM at Santa Rita & Old Santa Rita is projected to perform approximately 4,500 monthly transactions, which places it in Tier 4.
- The maximum queue that could result is 7 cars, although with a statistical probability of 0.01%, it is highly unlikely.
- Stacking capability of more than 3 cars is not needed, as the probability is under .5%.
- Recommendation is stacking capability of 3 cars at Santa Rita & Old Santa Rita.

					Cars in	Queue				
Tier	1	2	3	4	5	6	7	8	9	10
1	1.50%	0.20%	0.03%	0.00%	0.00%	0.00%	0.00%	0.00%	0.00%	0.00%
2	2.72%	0.49%	0.09%	0.02%	0.00%	0.00%	0.00%	0.00%	0.00%	0.00%
3	4 64%	1 15%	0.29%	0.07%	0.02%	0.00%	0.00%	0.00%	0.00%	0.00%
4	7.21%	2.36%	0.77%	0.25%	0.08%	0.03%	0.01%	0.00%	0.00%	0.00%
5	9.29%	3.63%	1.42%	0.55%	0.22%	0.08%	0.03%	0.01%	0.01%	0.00%
6	13.29%	7.09%	3.79%	2.02%	1.08%	0.58%	0.31%	0.16%	0.09%	0.05%



P12-1716 DESIGN REVIEW P 13-0007 SIGN DESIGN REVIEW **EXHIBIT B**



Received January 4, 2013 PLANNING COMMISSION FEBRUARY 13, 2013



DIEBOLD engineering has taken sound level measurements on our audio products associated with our VATs (Vacuum Air Tube Systems); VAT 21, VAT 23, VAT 40 and VAT 30/Easy-air 10 systems. These pneumatic tube systems are equipped with DIEBOLD 816TM Audio Systems.

In order to simulate a worst case configuration, all lane volume controls were set to the maximum levels and the person talking into the microphone stayed within one inch of the microphone. Normally, the lane volume potentiometers are adjusted on a per site basis to allow for normal ambient noise levels. Normal procedure also calls for the person speaking to be within three inches of the microphone.

DB	Distance from Customer Unit (Feet)
75 dB	3
72 dB	10
64 dB	20
61 dB	30
57 dB	40
55 dB	50
53 dB	60
53 dB	70

Please note that these are maximum values and the 816 Audio System is completely adjustable down to zero output. Also, these measurements were taken with no vehicle present, which will block a significant portion of the audio. Normal site conditions require less than maximum levels of output. The system is adjustable to local conditions. Once adjustments are made for the customer terminal (outside), they cannot be changed from outside of the building. In addition, changes made inside the building require a technician to remove a latched panel and make any adjustments for the outside terminal with a tool. The operator makes the inside operator terminal volume adjustments to his/her preference using the volume control.

For your convenience, the following table is included:

DB level	Description
0 dB	Threshold of Hearing
10 dB	Rustle of Leaves
20 dB	Quiet Studio or Auditorium
30 dB	Quiet Office
60 dB	Conversation at 3 feet
70 dB	Conversation at 1 foot
80 dB	Orchestra Average Level
90 dB	Vanaxial Ventilating Fan
100 dB	Gas Powered Lawn Mower
110 dB	Rock Concert
120 dB	Jet Takeoff at 1,500 feet
130 – 1400 dB	Threshold of Physical Pain



FEATURES & SPECIFICATIONS

INTENDED USE --- Ideal for lighting shopping center or stadium parking lots.

CONSTRUCTION — Rugged, heavy-duty aluminum housing. Square continuously seam-welded for weather-tight integrity. EPDM closed-cell housing gasket. Extruded, aluminum hinged door frame. All exposed hardware is stainless steel.

Finish: Standard finish is dark bronze (DDB), polyester powder, with optional architectural colors available.

OPTICS — One-piece, hydroformed, anodized aluminum reflector. Four IES cutoff distributions available. Type II (roadway), Type III (asymmetric), Type IV (forward throw) and vertically lamped Type V (symmetric). Reflector hinges out for easy removal during installation/maintenance. R5 is vertically lamped; R2, R3 and R4 are horizontally lamped. Impact-resistant glass lens. Convex glass lens is standard on R5 distribution.

ELECTRICAL --- High pressure sodium ballasts are high-reactance, high power factor for 70-150W. Constant wattage autotransformer for 250W.

Metal halide 100–150W ballasts are high-reactance, high power factor and are standard with pulse-start ignitor technology, "SCWA" not required. Constant waitage autotransformer for 175M and 250M, Super CWA (pulse start ballast), 88% efficient and EISA legislation compliant, is required for 175-250M (SCWA option) for U.S. shipments only. CSA or INTL required for probe-start shipments ouside the U.S. Pulse-start ballast (SCWA) required for 200M.

Removable, unitized power module and positive locking disconnect plugs (primary and secondary).

Ballasts are 100% factory-tested.

Socket is mogul-base, medium base for 100M and 150M, porcelain socket with copper alloy, nickel-plated screw shell and center contact. UL listed 1500W-600V, 4KV pulse-rated.

INSTALLATION --- Extruded, 9" arm with integral splice compartment for pole or wall mounting. Optional mountings available.

LISTING — UL listed for wet locations, Listed and labeled to comply with Canadian standards (see Options).

Note: Specifications subject to change without notice.

ORDERINGINFORMATION

For shortest lead times, configure product using bolded options.

Notes

Туре


P12-1716 DESIGN REVIEW P13-0007 SIGN DESIGN REVIEW

EXHIBIT B

Received January 4, 2013

PLANNING COMMISSION FEBRUARY 13, 2013

Arm-Mounted Area Cutoff Lighting

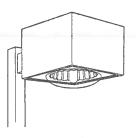


METAL HALIDE: 100-250W HIGH PRESSURE SODIUM: 70-250W

20' to 30' Mounting

Specifications EPA:: 1.8 ft2 (.17 m2) Square: 16-3/4 (42) Depth: 10-1/2 (26) Arm length: 9 (22) *Weight: 33 lbs (15 kg)

*Weight as configured in example below.

All dimensions are inches (centimeters) unless otherwise specified.

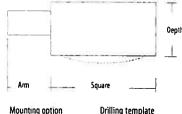

SPxx, RPxx, DA12P 5 WBxx, DA12WB 6 WWxx

Example: KVS1 250S R3 TB SP09 LPI

KVS1						
Series	Wattage	Distribution	Voltage	Ballast	Mounting	
KVS1	Metal halide 100M* 175M2 200M 150M 250M3 Ceramic metal halide* 100MHC 150MHC High pressure sodium* 705 100S 250S 150S 150S 150S 150S 150S 150S 150S 150S 150MHC 100M* 175MHC 175MHC	R2 IES Type II roadway R3 IES Type III asymmetric R4 IES Type IV forward throw R5 IES Type V symmetric	120 347 208 ³ 480 ⁵ 240 ⁵ TB ⁴ 277 23050HZ ⁷	(blank) Magnetic CWI Contant wattage isolated CONTANT WATTAGE isolated CONTANT WATTAGE ISOLATE SUPER CWA pulse-start ballast NOTE: For shipments to U.S. territories, SCWA must be specified to comply with EISA.	SP09 Square pole RP09 Round pole WB09 Wall bracket WW09 Wood pole or wall	Optional mounting DA12P Degree arm, pole DA12WB Degree arm, wall KMA Mast arm adapter ^a KTMB Twin mounting bar

Options	DESCRIPTION OF THE PERSON OF T	COLON STATES OF STATES	COLUMN TO SERVICE		Finish ¹³		The same of	DASHAGE KO	Lamp	
Shipped installed in fixture PER NEMA twist-lock receptacle only (no photocontrol) SF Single fuse (120, 277, 347V) n/a TB DF Double fuse (208, 240, 480V) n/a TB QRS Quartz restrike system ⁹ EC Emergency circuit ⁶	HS CSA INTL REGC1 MED	House side shield (R3, R4) Listed and labeled to comply with Canadian standards Available for probe-start shipping outside the U.S. California Title 20, effective 1/1/10 Medium base socket ¹⁰	Shippe PE1 PE3 PE4 PE7 SC VG	ed separately ¹¹ NEMA twist-lock PE (120, 208, 240V) NEMA twist-lock PE (347V) NEMA twist-lock PE (480V) NEMA twist-lock PE (277V) Shorting cap for PER option Vandal guard ¹²	(blank) DWH DBL DMB DNA DSS	Dark bronze White Black Medium bronze Natural aluminum Sandstone	DGC DTG DBR DSB CR	Charcoal gray Tennis green Bright red Steel blue Enhanced corrosion resistance	LPI L/LP	Lamp included Less lam

Accessories: Tenon Mounting Slipfitter ¹⁵ Number of fixtures.							
Tenon O.D.	One	Two@180°	Two@90°	Three@120°	Three@90°	Four@90°	
2-3/8" (6)	T20-190	T20-280	T20-290	T20-320	T20-390	T20-490	
2-7/8° (7.3)	T25-190	T25-280	125-290	T25-320	T25-390	T25-490	
4" (10.2)	T35-190	T35-280	T35-290	T35-320	T35-390	135-490	

Not available with SCWA.

Notes


- These wattages do not comply with California Title 20 regulations.
- These wattages require the REGC1 option to be chosen for shipments into California for Title 20 compliance. 250M REGC1
- is not available in 347V or 480V. Must order with LPL
- Must specify CWI for use in Canada:
- - Optional multi-tap ballast (120, 208, 240, 277V), (120, 14 Must be specified. 277, 347V in Canada).
- Consult factory for available wattages.

- For use with 6° minimum 2-3/8: 0.0. pipe
- Maximum allowable wattage lamp included
- For 705, 1005 and 1505 wattages only
- 11 May be ordered as an accessory.
- 12. Prefix with KVS1 when ordering as an accessory.
- 13 See-www.lithonia.com/archcolors for additional color options.
- 15 Order as a separate line Item RP09 or DA12P mounting arm must be ordered on the fixture.

KVS1-M-S

Coefficient of Utilization **Initial Footcandles**


KVS1 250S R5 Test No. 1190062002

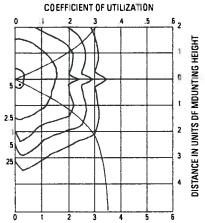

250W High Pressure Sodium lamp, 30000 rated lumens. Footcandle values based on 20' mounting height, Distribution R5, cutoff.

KVS1 250S R3


Test No. 1190061104

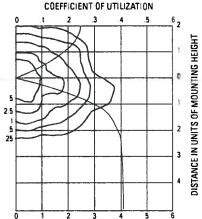

250W High Pressure Sodium lamp, 30000 rated lumens. Footcandle values based on 20' mounting height, Distribution R3, cutoff.


KVS1 250S R4

Test No. 1190081303

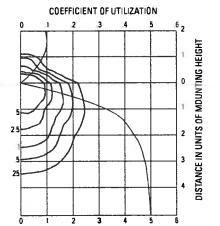


250W High Pressure Sodium lamp, 30000 rated lumens. Footcandle values based on 20' mounting height, Distribution R4, cutoff.

KVS1 250M R5 TEST NO: 1190061506P ISOILLUMINANCE PLOT (Footcandle)

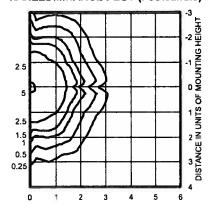


250W pulse start metal halide lamp, rated 23500 umens. Footcandle values based on 20' mounting height. Classification: Type IV, Short, Cutoff

KVS1 250M R3 TEST NO: 1190061403P **ISOILLUMINANCE PLOT (Footcandle)**

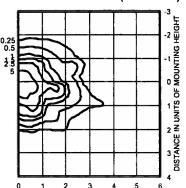

250W pulse start metal halide lamp, rated 22500 lumens. Footcandle values based on 20' Classification: Type I. Short, Semicutoff

KVS1 250M R4 TEST NO: 1190072601P **ISOILLUMINANCE PLOT (Footcandle)**

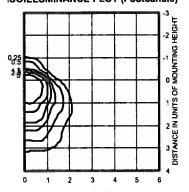

250W pulse start metal halide lamp, rated 22500 lumens. Footcandle values based on 20 mounting height Classification Unclassified (Type IV, Very Short), Cutoff

NOTES

- 1 Photometric data for other distributions can be accessed from the Lithonia Lighting website.)www.Lithonia.com)
- 2 For electrical characteristics, consult outdoor technical data specification sheets on www.Lithonia.com.
- Tested to current IES and NEMA standards under stabilized laboratory conditions Various operating factors can cause differences between laboratory and actual field measurements. Oimensions and specifications are based on the most current available data and are subject to change.

Mounting Height Correction Factor

(Multiply the fc level by the correction fector) 15 ft.= 1.78 25 ft.= 0.64 30 ft.= 0.44

Existing Mounting Height \(\frac{2}{2} = \text{Correction Factor} \) New Mounting Height



D-Series Size 1LED Flood Luminaire




Catalog Number	
Notes	
Туре	

d"series

Specifications

0.6 ft² EPA: (0.05 m) 3-1/8" Depth: 8-7/8" Width: (22 4 cm) 7-3/4" Height: (198 cm) **Overall** 12" Height (30.5 cm) 7.2 lbs Weight:

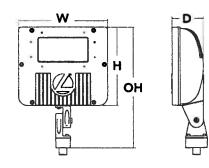

Introduction

The D-Series Size 1 Flood features precision optics to beautifully illuminate a variety of applications while its sleek, compact styling blends seamlessly with the environment.

The D-Series Flood reflector systems and cutting-edge chip-on-board LED technology produce low field-to-beam ratios for minimal spill light and incredible photometric performance. It's the ideal long-life replacement for 50 - 150W metal halide floods, with typical energy savings of 72% and expected service life of over 100,000 hours.

Ordering Information

EXAMPLE: DSXF1 LED 2 A530/40K MSP MVOLT THK DDBXD

DSXF1 LED

Series	Light Engines	Performance Package	Distribution	Voltage	Mounting		Options	Finish (req	uired)
DSXF1 LED	1 One COB engine 2 Two COB engines	530 mA options: A530/30K 3000K A530/40K 4000K A530/50K 5000K	MSP Narrow spot MSP Medium spot MFL Medium flood FL Flood WFL Wide flood WFR Wide flood, rectangular HMF Honzontal flood	MVOLT ¹ 120 ¹ 208 ¹ 240 ¹ 277 ¹	Shipped inc THK Shipped se DSXF1/2TS	Knuckle with 1/2° NPS threaded pipe	Shipped installed PE Photocontrol, bulton style ¹ SF Single fuse (120, 277V) ¹ Shipped separately ² UBV Upper/bottom visor (universal) FV Full visor VG Vandal guard	DDBXD DBLXD DNAXD DWHXD	Dark bronze Black Natural aluminum White

Stock configurations are offered for shorter lead times:

Standard Part Number	Stock Part Number
DSXF1 LED 1 A530/40K WFL MVOLT THK DDBXD	DSXF1 LED 1 40K
DSXF1 LED 1 A530/50K WFL MVOLT THK DDBXD	DSXF1 LED 1 50K
DSXF1 LED 2 AS30/40K WFL MVOLT THK DDBXD	DSXF1 LED 2 40K
DSXF1 LED 2 A530/50K WFL MVOLT THK DDBXD	DSXF1 LED 2 50K

Accessories

Ordered and shipped separately

DSXF t/2TS DDBXD U Slipfilter for 1 1/4" to 2-3/8" 00 tenons, males with 1/2" threaded knockie (specify finish)

FRWB DDBXDLI Radius wall bracket, 2-3/8"OD tenon (specify

FSPB OD BXD LI Steel square pole bracket, 2-3/8-00 innon

OD BXD LI Steel square pole bracket, 2-3/8" Ou (specify finish)

OSXF TUBY DOBXD U Upper/bottom wsor accessory (speul y finish)
OSXF TEY OOBXD U Full wsor accessory (specify finish)
OSXF TYG U Vandal quard accessory

For more mounting options, visit our Floodlighting Accessories pages.

NOTES

- MVOLT driver operates on any line voltage from 120-277V (50/60 Hz). Specify 120, 208, 240 or 277 options only when ordering with fusing (SF option) or photocontrol (PE).
- Also available as separate accessories, see Accessories information at left.
- 3 Photocontrol (PE) requires 120, 208, 240 or 277 voltage option.
- 4 Single fuse (SF) requires 120 or 277 voltage option



Performance Data

Lumen Output

Lumen values are from photometric tests performed in accordance with IESNA LM-79-08. Data is considered to be representative of the configurations shown, within the tolerances allowed by Lighting Facts. Actual performance may differ as a result of enduser environment and application. Contact factory for performance data on any configurations not shown here

Light	Drive Current	Performance	100000000000000000000000000000000000000	System	Dist.		eld igle		am gle	(40	40K 00K, 70 CR	1)	(50	50K 00 K, 67 C RI)
Engines	(mA)	Package	Watts	Type	Н	γ	Н	γ	Max Cd	Lumens	LPW	Max Cd	Lunens	LPVV	
				NSP	48	49	19	19	7300	1388	66	7277	1383	66	
			-	MJP	30	40	24	72	0740	כנכו	74	6719	1550	74	
		pl.		MFL	60	60	47	46	2806	1662	29	2797	1657	79	
1	530	A530/X	21W	FL	85	84	63	62	tB55	1807	86	1849	1802	86	
				WFL	106	106	71	72	1391	1900	90	1387	1894	90	
				WFR	107	88	85	64	1386	1943	93	1381	1937	92	
				HMF	100	62	80	13	1259	613	29	1255	611	29	
				NSP	48	49	19	19	13,803	2624	64	13,760	2616	64	
			41 W	MSP	50	48	24	23	12,744	2941	n	12,704	2932	72	
				MFL	60	60	47	46	5305	3143	77	5288	3133	76	
2	530	A530/K		FL	85	84	63	62	3507	3418	83	3496	3407	83	
				WFL	106	106	71	72	2630	3593	88	2622	3582	87	
				WFR	107	88	85	64	2620	3674	90	2612	3663	89	
					HMF	100	62	80	13	2381	1159	28	2374	1156	28

Lumen Ambient Temperature (LAT) Multipliers

Use these factors to determine relative luman output for average ambient temperatures from 0-40°C (32-104°F).

Amb	ient	Lunien Miritiplier		
0°C	32°F	t.05		
10°C	50°F	t 03		
20°C	68°F	1.01		
25°C	77°F	1.00		
30°C	86°F	0.99		
40°C	104°F	0.97		

Projected LED Lumen Maintenance

Data references the extrapolated performance projections for the DSXF1 LED 2 A530 platform in a 40°C amblent, based on 8400 hours of LED testing (tested per IESNA LM-80-08 and projected per IESNA TM-21-11).

To calculate LLF, use the lumen maintenance factor that corresponds to the delired number of operating hours below. For other lumen maintenance values, contact factory.

Operating Hours	0	25,000	50,000	100,000
Lumen Maintenance Factor	1.0	0.94	0.90	0.84


Electrical Load

			Current (A)					
Light Engines	Drive Current m ^a)	System Watt	120	208	240	277	347	480
1	530	21W	0.19	0.11	0,10	0.08		20
2	530	41W	0.38	0.22	0.19	0.16	- 00	*

Photometric Diagrams

To see complete photometric reports or download .les files for this product, visit Lithonia Lighting's D-Series Flood Size 1 homepage.

Isocandela plots for the DSXF1 LED 2 A530/40K

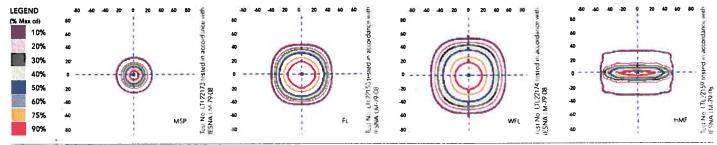

FEATURES & SPECIFICATIONS

INTENDED USE

The sleek design of the D-Series Size 1 Flood reflects the embedded high performance LED technology. It is ideal for landscape, signage and accent lighting in many commercial and residential applications.

CONSTRUCTION

Die cast aluminum housing has integral heat sink fins to optimize thermal management through conductive and convective cooling. The LED driver is mounted in direct contact with the casting to promote low operating temperature and long life. Housing is completely sealed against moisture and environmental contaminants (IP65). Low EPA (IO.6 ft? for optimized wind loading.)

FINISH

Exterior parts are protected by a zinc-infused Super Durable TGIC thermoset powder coat finish that provides superior resistance to corrosion and weathering. A tightly controlled multi-stage process ensures a minimum 3 mils thickness for a finish that can withstand extreme climate changes without cracking or peeling.

OPTICS

A variety of precision-molded vacuum-metallized specular reflectors are engineered for superior field-to-beam ratios, uniformity and spacing. Light engines are available in 3000K (80 CRI min.), 4000K (70 CRI min.) or 5000K (67 CRI min.) configurations. Optional visors offer additional versatility.

ELECTRICAL

Light engine(s) consist of chip-on-board (COB) LEDs directly coupled to the housing to maximize heat dissipation and promote long life (100,000 hrs at 40°C, L84). Single-engine unit uses a Class 2 electronic driver; dual-engine unit uses a Class 1 electronic driver. Both drivers have a power factor >90%. THD <20%, and an expected life of 100,000 hours. Surge protection meets a minimum Category C Low for 120-277V operation (per ANSI/IEEE C62,41.2).

INSTALLATION

Integral adjustable knuckle with 1/2-14 NPS threaded pipe facilitates quick and easy installation to a variety of mounting accessories. This secure connection enables the Diseries Size 1 to withstand up to a 1.5 Givibration load rating per ANSI C136 31.

LISTING

CSA certified to U.S. and Canadian standards. Luminaire is IP65 rated. Rated for 40°C minimum ambient.

WARRANTY

Five year limited warranty. Full warranty terms located at www.acuitybrands.com/ CustomerResources/Terms_and_conditions.aspx.

Note: Specifications subject to change without notice











P12-1716 DESIGN REVIEW
P13-0007 SIGN DESIGN REVIEW

EXHIBIT B

Received January 4, 2013
PLANNING COMMISSION FEBRUARY 13, 2013

NEW BUILD



PERSPECTIVES

02/05/2013

Old Santa Rita & Santa Rita

PLEASANTON, CA 94588




CHASE


2





ROCKFACE FINISH BRICK VENEER RED SUNSET ROCKFACF ALLIMINUM PANEL MATCH MARTHEWS 19891 NICKEL ALUMINUM PANEL MAICH MARTHEWS 19801 NICKEL
BRICK VENEER RED SUNSET ROCKFACF ALLIMINUM PANEL MATCH MATTHEWS
BRICK VENEER RED SUNSET
ROCKFACE FINISH
CAST STONE VENEER
CEMENT PLASTER SAND TEXTURED PAINT TID MATCH SW 7036 ACCESSIBLE BEK
CEMENT PLASTER SAND TEXTURED PAINT TO MATCH SW 6108 LATTE
ROOFING SPANISH TILE LEAY

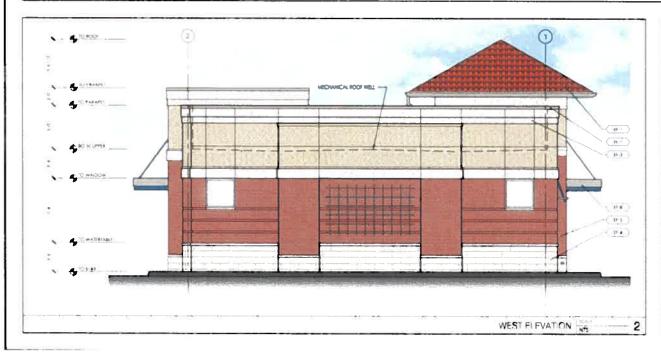

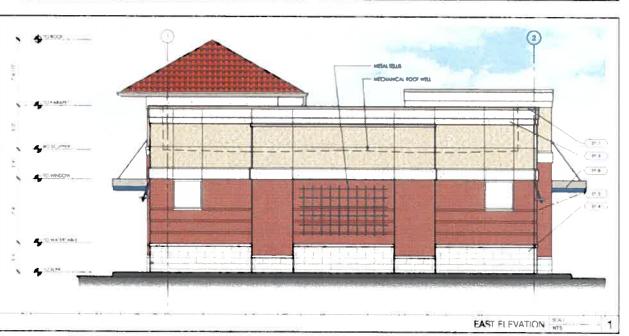



OLD SANTA RITA & SANTA RITA RETAIL BANKING CENTER 3506 SANTA RITA ROAD PLEASANTON. CA 94566


CALLISON

CALLISON ARCHITECTS, P. (
WWW.callison.com


SSUE		DISCRIPTION
	29/12/2012	PERMIT SUBMITTIAL
	2/ 0/20 7	DESIGN PERMITSUS
		-

Meliton /

2

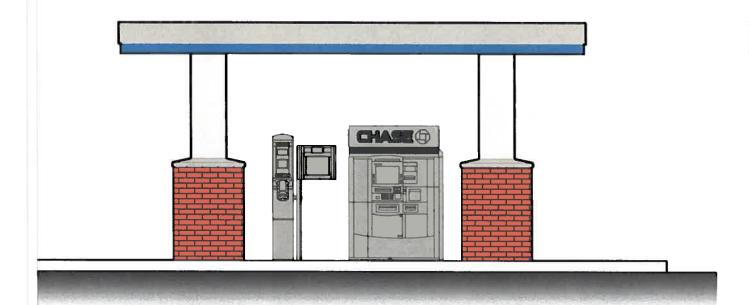



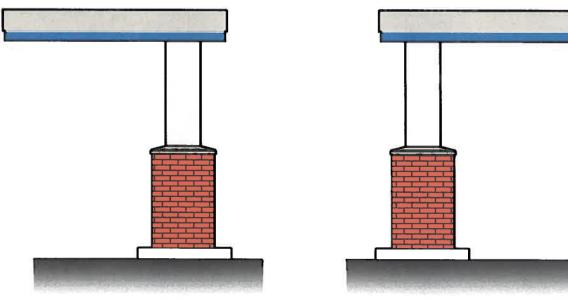

WEST & EAST ELEVATIONS

3506 Old Santa Rita Road

Pleasanton, CA 94588





CHASE •

OLD SANTA RITA ROAD & SANTA RITA 3431 SF Remote ATM Elevations

NEW BUILD

01/03/2013

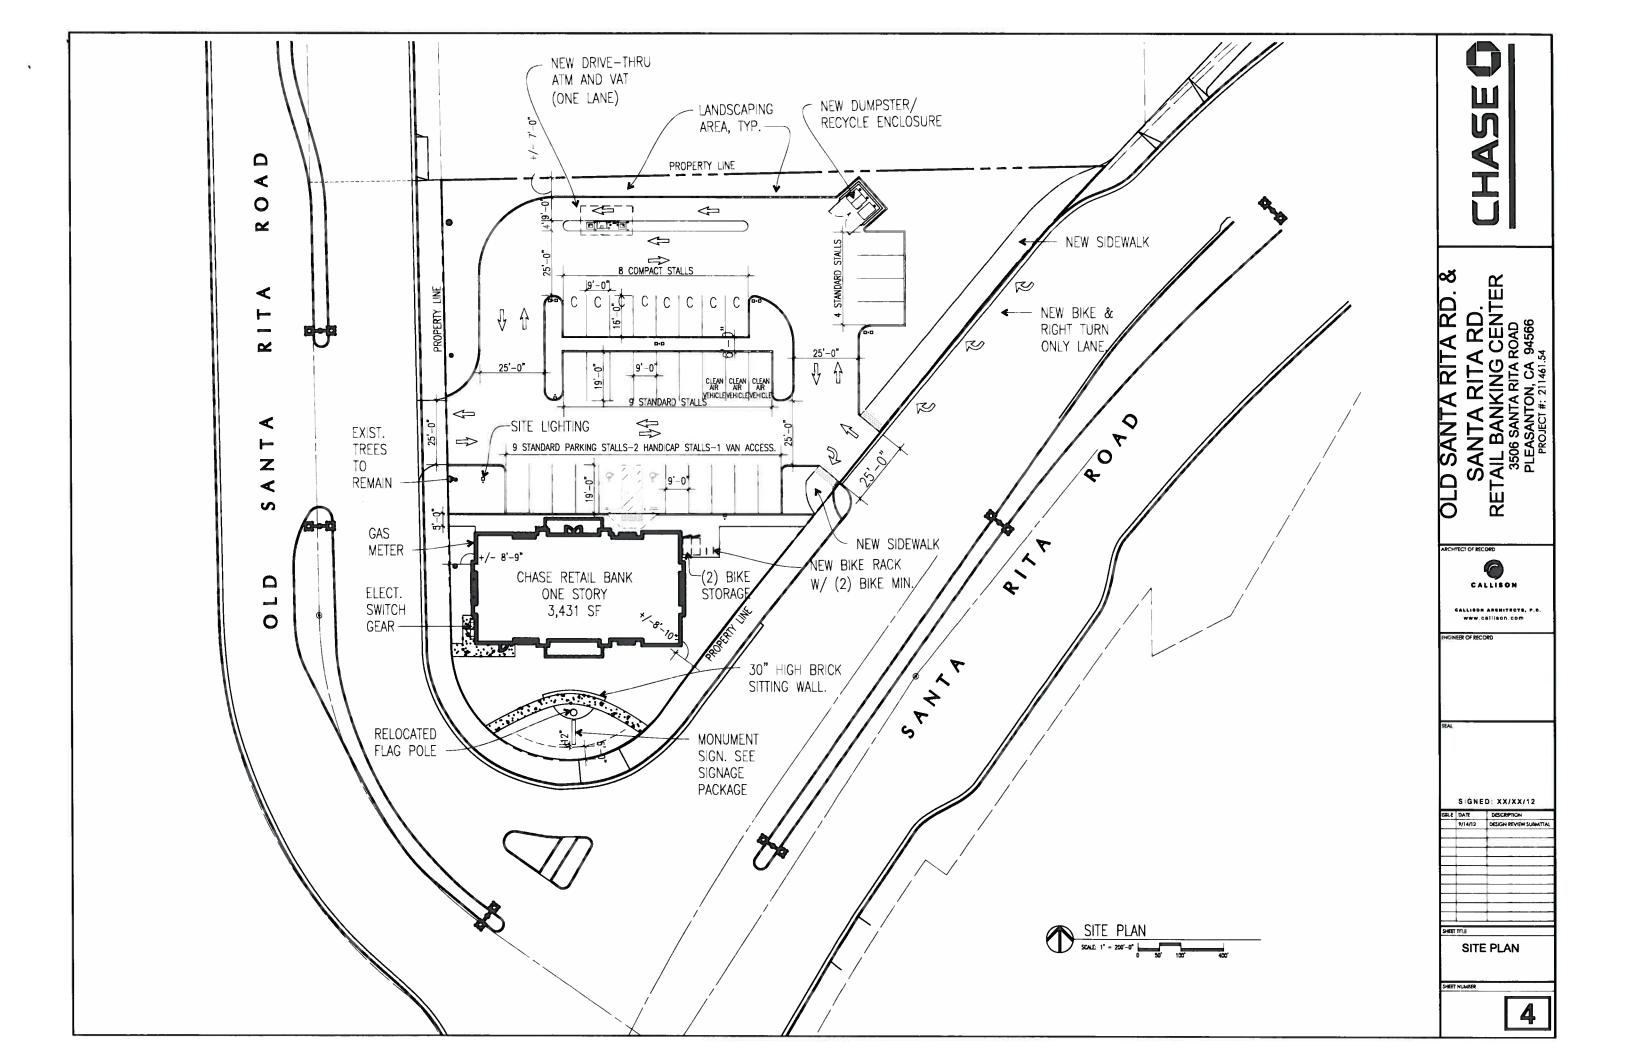

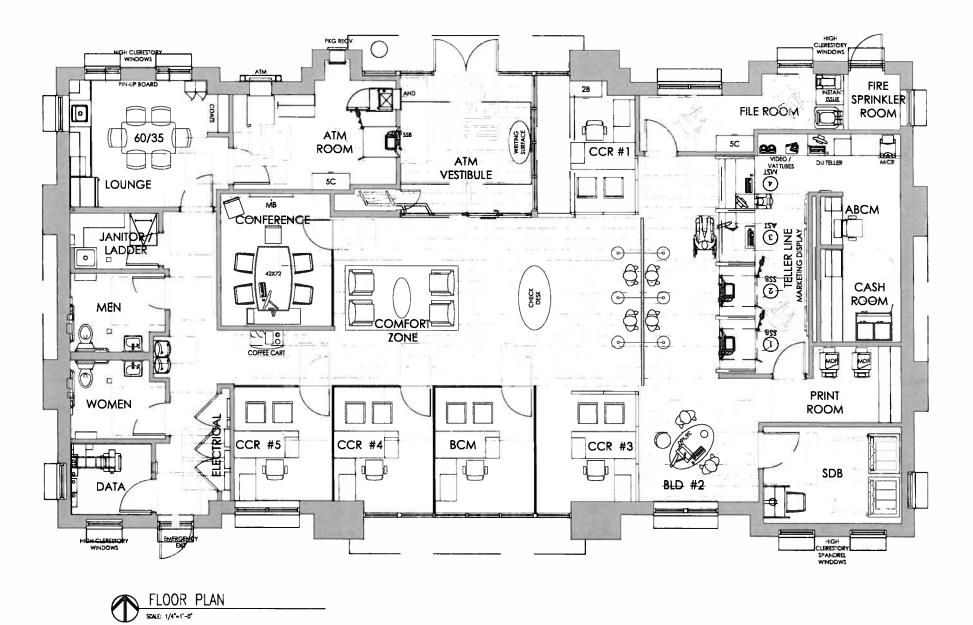

S GNED: XX/XX/12

SRED: XX/XX/12

SRED: DESCRIPTION


9/14/12 DESIGN REVIEW SURANT


OLD SANTA RITA RD. & SANTA RITA RD.
RETAIL BANKING CENTER
3506 SANTA RITA ROAD
PLEASANTON, CA 94566


Ŋ


5

FLOOR PLAN

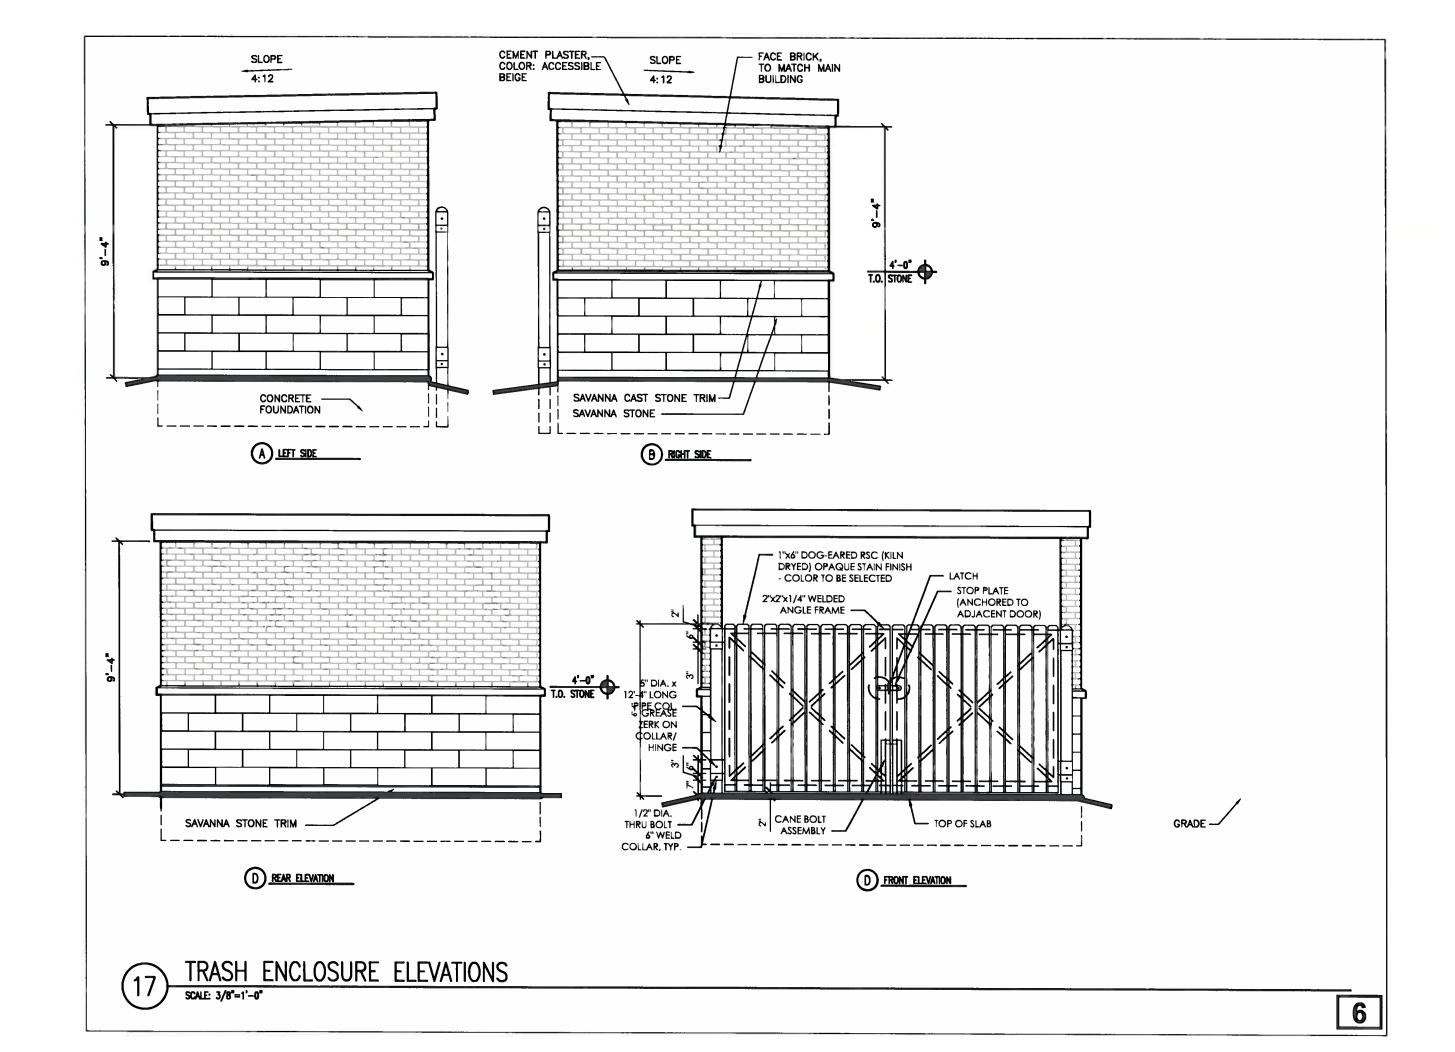

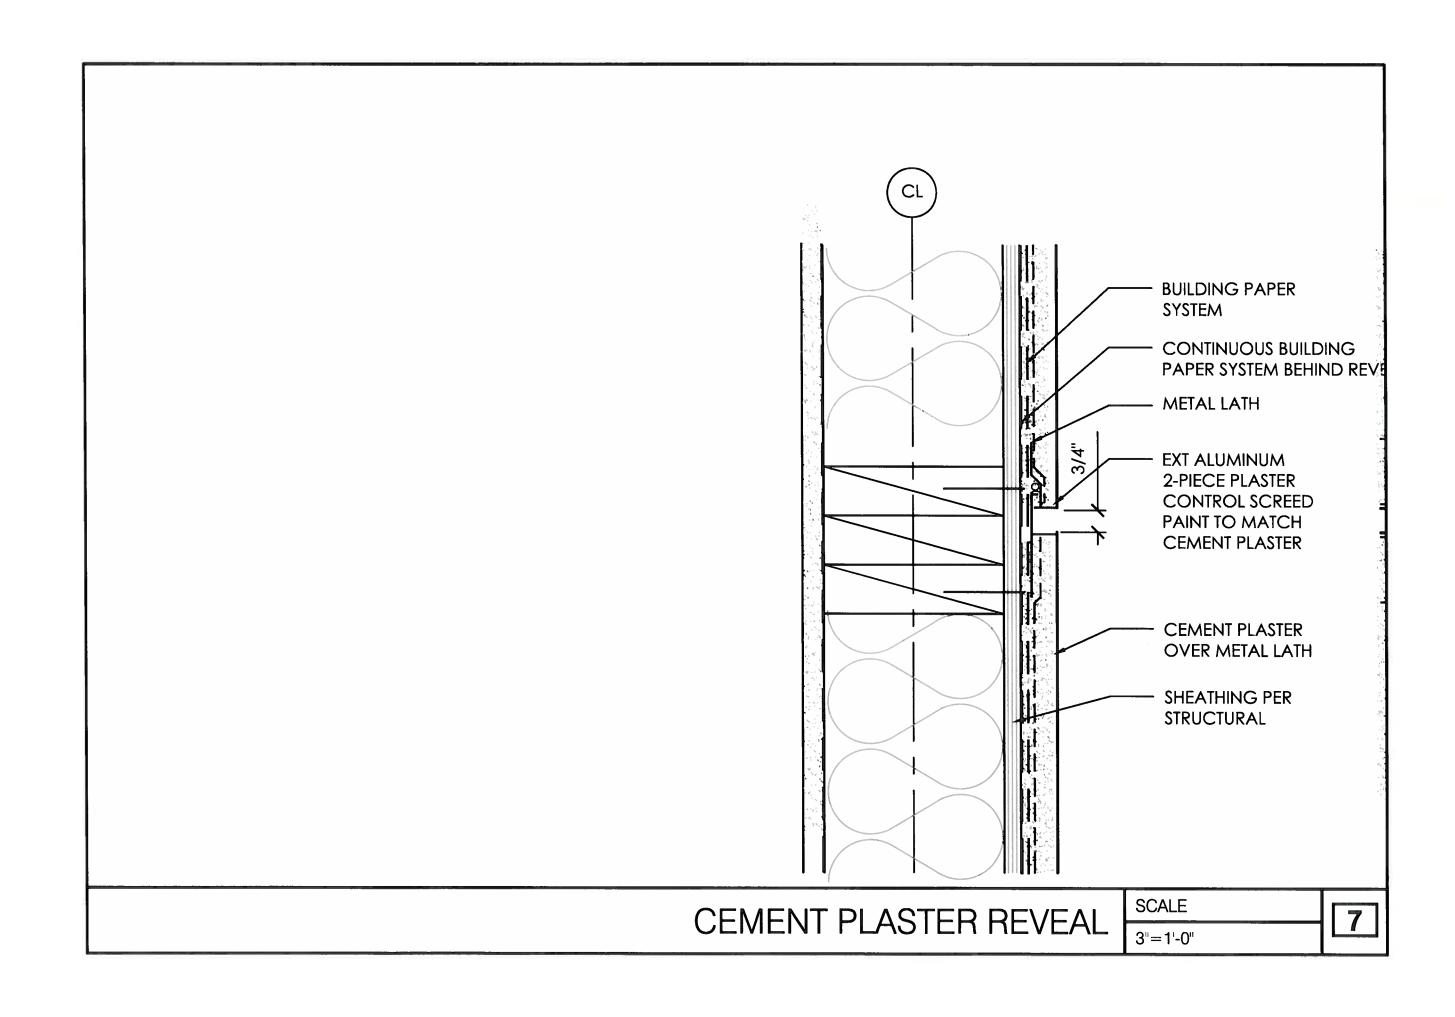

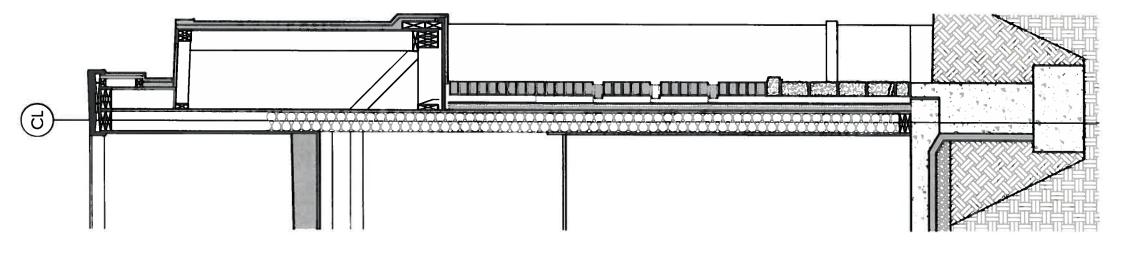

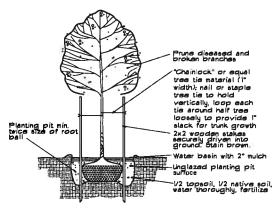



NOTES

Subgrades, including berms, to within I With foot provided by General Contractor unless otherwise noted. Subgrade shall be scarified or rototilled if conditions require. 8° depth 3-way topsoil or equal in all planting areas. 2° depth shredded cedar bark mulch in all planting beds. All plant material shall be healthy, full and conform to USA standard nursery stock, latest edition. Plant material or size or kind not available may be substituted only with approval of Landscape Architect or Owner. All mass plantings shall have triangular spacing. All tree pits shall be inspected to insure proper drainage. Positive drainage shall be maintained. Mound planting areas minimum 6°.

Landscape Contractor shall maintain site until final inspection and acceptance by Owner.

DECIDUOUS TREE PLANTING DETAIL

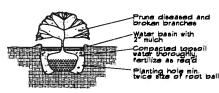

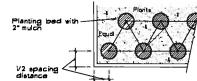


SHRUB PLANTING DETAIL

GROUND COVER SPACING DETAIL No Scale- Triangular Spacing

PLANT LIST

	5 MIBOL	DOTANICAL III COMMON	0.1 44 IDID	0		
5	STUDOL	BOTANICAL / COMMON (*YTITMAUC	SIZE	SPACING	CONDITION
/ \	·	Prunus cerasifera Thundercloud' Thundercloud Plum	/ 6	24° box	per plan	container
٧,		Pyrus calleryana 'Chanticlear' / Chanticleer Pear	8	24° box	per plan	container
	(X)	Calocedrue decurrens / Incense Cedar	3	24° box	per plan	container
	₩	Colsonsma 'Sunset Gold' / Sunset Gold Colsonsma	122	5 gallon	per plan	full
	•	Rosmarinus officinalis Ken Taylo Ken Taylor Rosemary	or* / 35	5 gallon	per plan	ប់ រា
	0	Viburnum tinus 'Spring Bouquet' Spring Bouquet Viburnum	/ 47	5 gallon	per plan	full
	Ø	Berberis thunbergli stropurpure Red Barberry	8/ 54	5 gallon	per plan	full
	0	Rhaphiolopis Enchantress / Indian Hawthorn	164	5 gallon	per plan	full
	•	Agapanthus Peter Pan / Lily not the Nile	133	l gallon	per plan	ា
	+	Campais radicans / Trumpet Vine	4	5 gallon	per plan	staked
		Gazania rigens / Gazania		I gallon	30° o.c.	full
	********	Carex barberae / Carex	28561	1 gallon	3 0° 0.c.	full
		Seasonal color	fill spcae	4°-1 gallon		
		Sodded Lawn - locally grown				

· Confirm all quantities

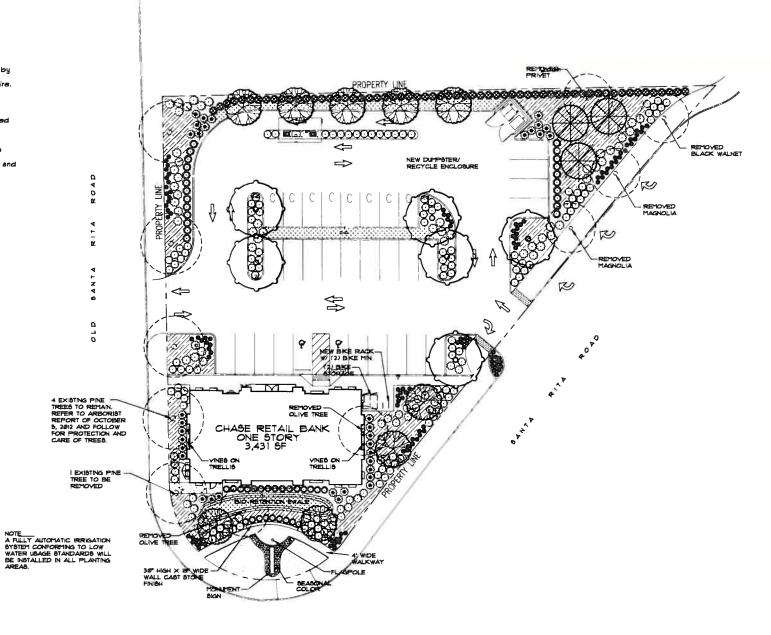





J. & C. ... A RD. JANKING CENTER 3506 SANTA RITA ROAD PLEASANTON, CA 94566 PROJECT #: 211461.54 SANTA RITA RETAIL BANKING (3506 SANTA RITA RO OLD

ARCHITECT OF RECORD

CALLISON CALLIBON ARCHITECTO, P.C. WWW.CEIIIEGN.COM

ENGINEER OF RECORD


MAIN STREET DESIGN
LANDSCAPE ARCHITECTURE
PORT PORT DUTY
MEMORING BUT



ISSUE	DATE	DESCRIPTION
	09/14/12	DESIGN REVIEW SUBMIT
	02/6/13	
\Box		
\Box		
L		L
SHEE	TITLE	
	REL MIN	APE PLAN

SHEET NUMBER

9

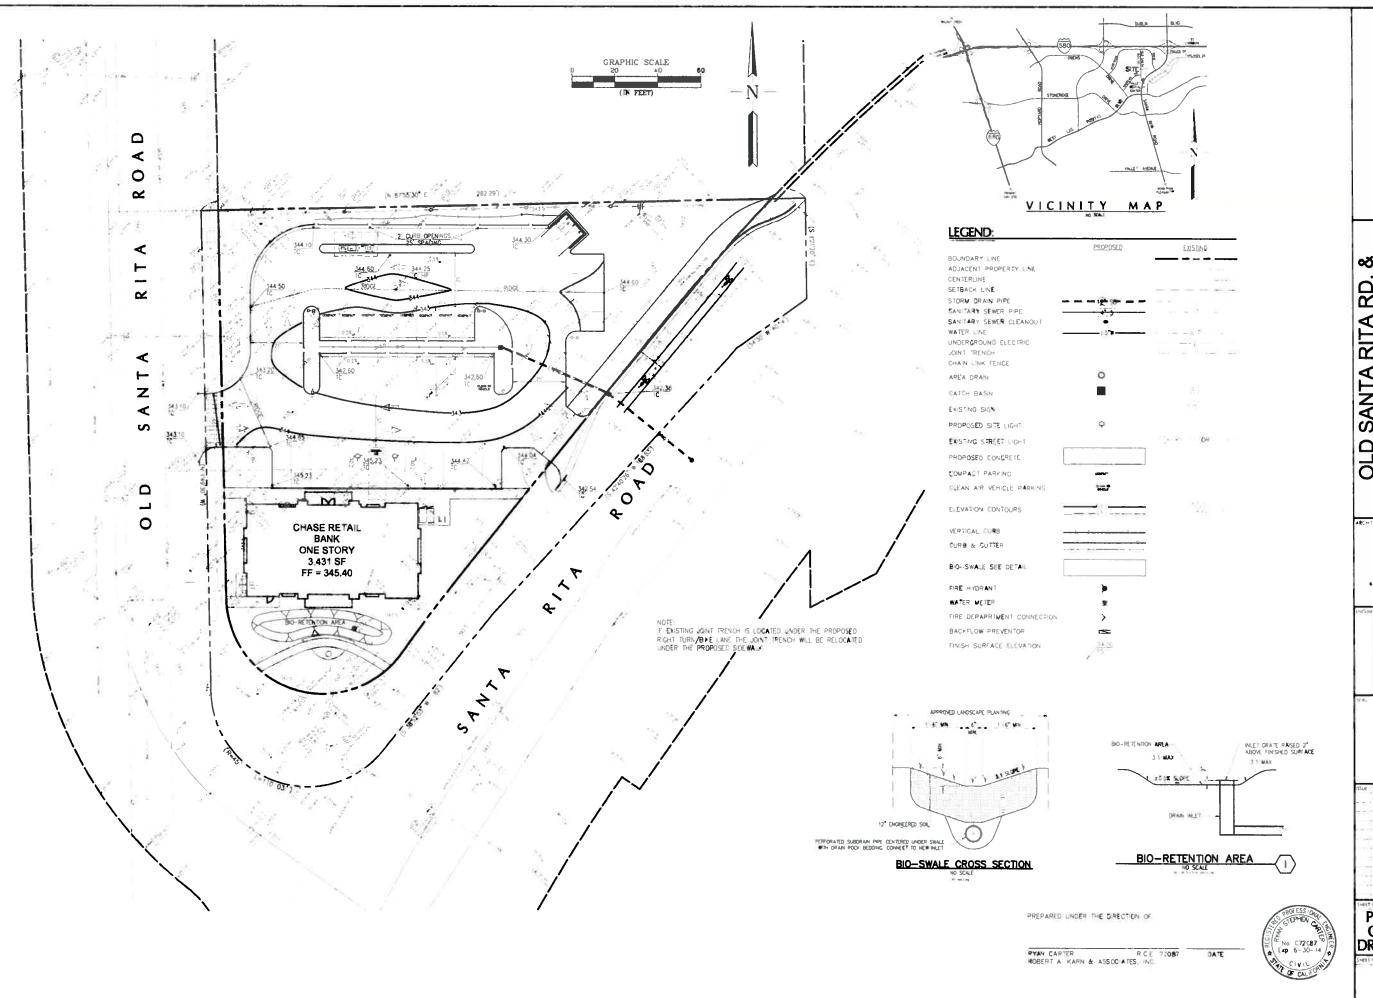




OLD SANTA RITA RD. & SANTA RITA RD. RETAIL BANKING CENTER 3506 SANTA RITA ROAD PLEASANTON, CA 94566 PROJECT #: 211461.54

CALLISON

ROBERT A. KARN & ASSOCIATES, Inc.

SIGNED XX/XX/12


PRELIMINARY GRADING & DRAINAGE PLAN

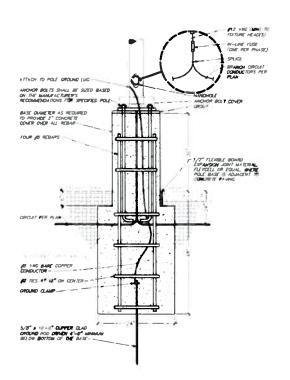


2 SITE LIGHTING POLE BASE DETAIL


(I entex	Later	Catalog Number	Descriptor	Lane	Lumene	Wetts	Mourang Hingel
	ti:	WIDELITE CASOBU TDB064H3	ARCHITECTURAL WALLPACK LED TOPE B WITH HERVIDIAL LED LIN TOPTICS AND CLEAR FLAT CLASS LEN	54 WHITE LEDS LUNES OUTPUT # 6 199 LWS	áligg	86.9	igra
ū	ä	LITHONIA RVS.1.15M RS	TYPE I BHORT NON- CUTOFF	BT 28 ME A HALIDE	1291	20	15
200	:Na	LITHONIA KV81 115W RS	TYPE & WEDSAM	B1 20 METAT HALIDE VERTILAL BASE-UP POSITION	4000	826	197
	(1841)	LSI-CROZ-6-LTD- TO-CW-UE WHT	50 EC AMBIENT ENHANCED SYNSME FRIC RECESSED CANOPY	FIFTY WHITE USED EMILING DODES LEDIT VERTICAL BASE UP POSITION	Adequate	80	•
	u#	LSI EPO FOLED- XX-CW 431. WHT	30 LED AMBIENT ENHANCED SY MMETRIC RECESSED CANOPY	THRETY FOUR WHITE DON'T (MITTING DICCE) LEDS: VERTICAL BASE -UP POSITION	AtmotAs	56	9
	12	BETALED CAN 227-PS-RM-03-C- UI-525 BXCR0A03C-U (528mA)	PETROLEUM SYMMETRIC RE ESSED CANOPY 525mA	THIRTY WHITE LIGHT EMITTING DIODES (LEDS) VERTICAL BASE -UP POSITION	Absolute	54 f	Ÿ.
	10	UITHONIA LIGHTING DSXF1 LED FV IAS30-40K NSP	LED FLOODUGHT FOXTURE FOR FLAD POLE	Н			COORDINATE

STATISTICS								
Description	Symbol	Avp	Man	Mn .	Ministra	AvgAlin		
Parting Area	+	6.3 k	25 8 %	09%	29.7 1	397		
Bout Day	+	3.2 %	5.3 fc	1116	■ E(E)	151		

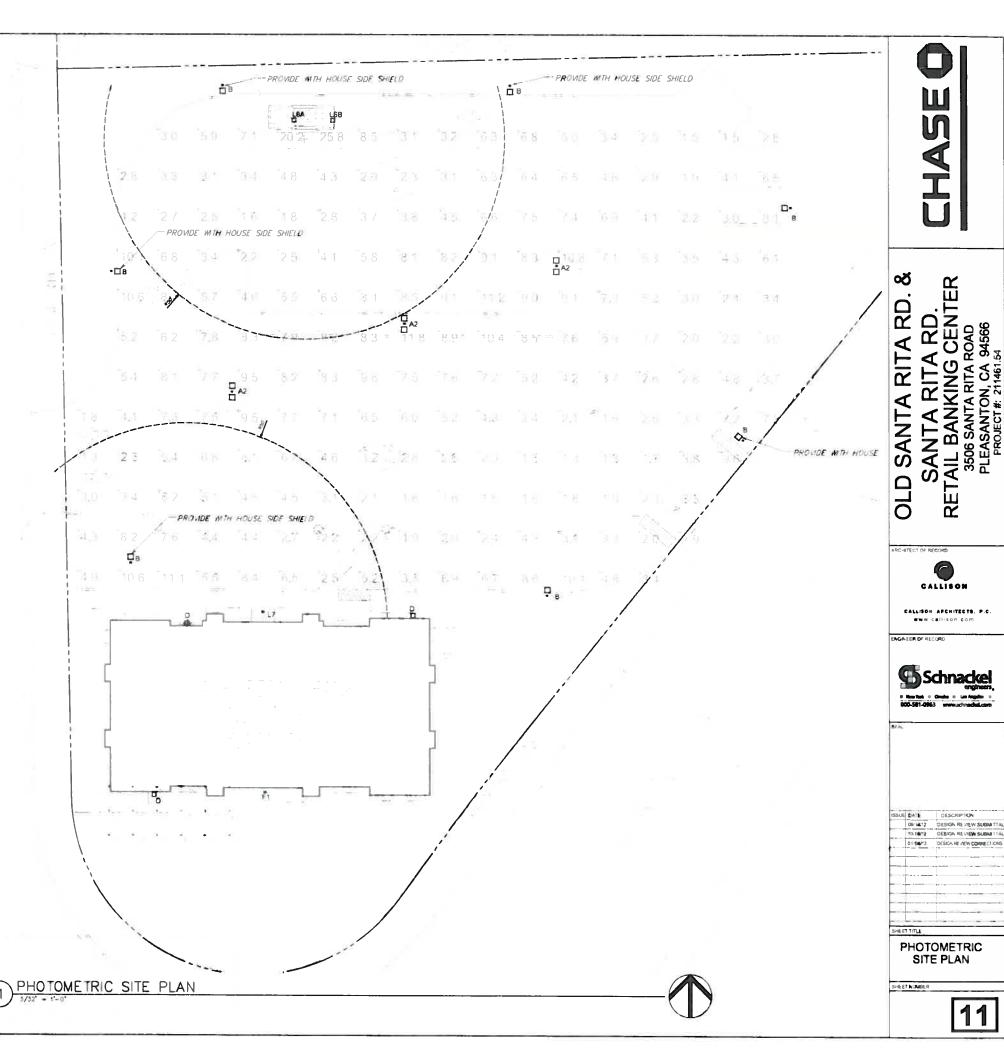

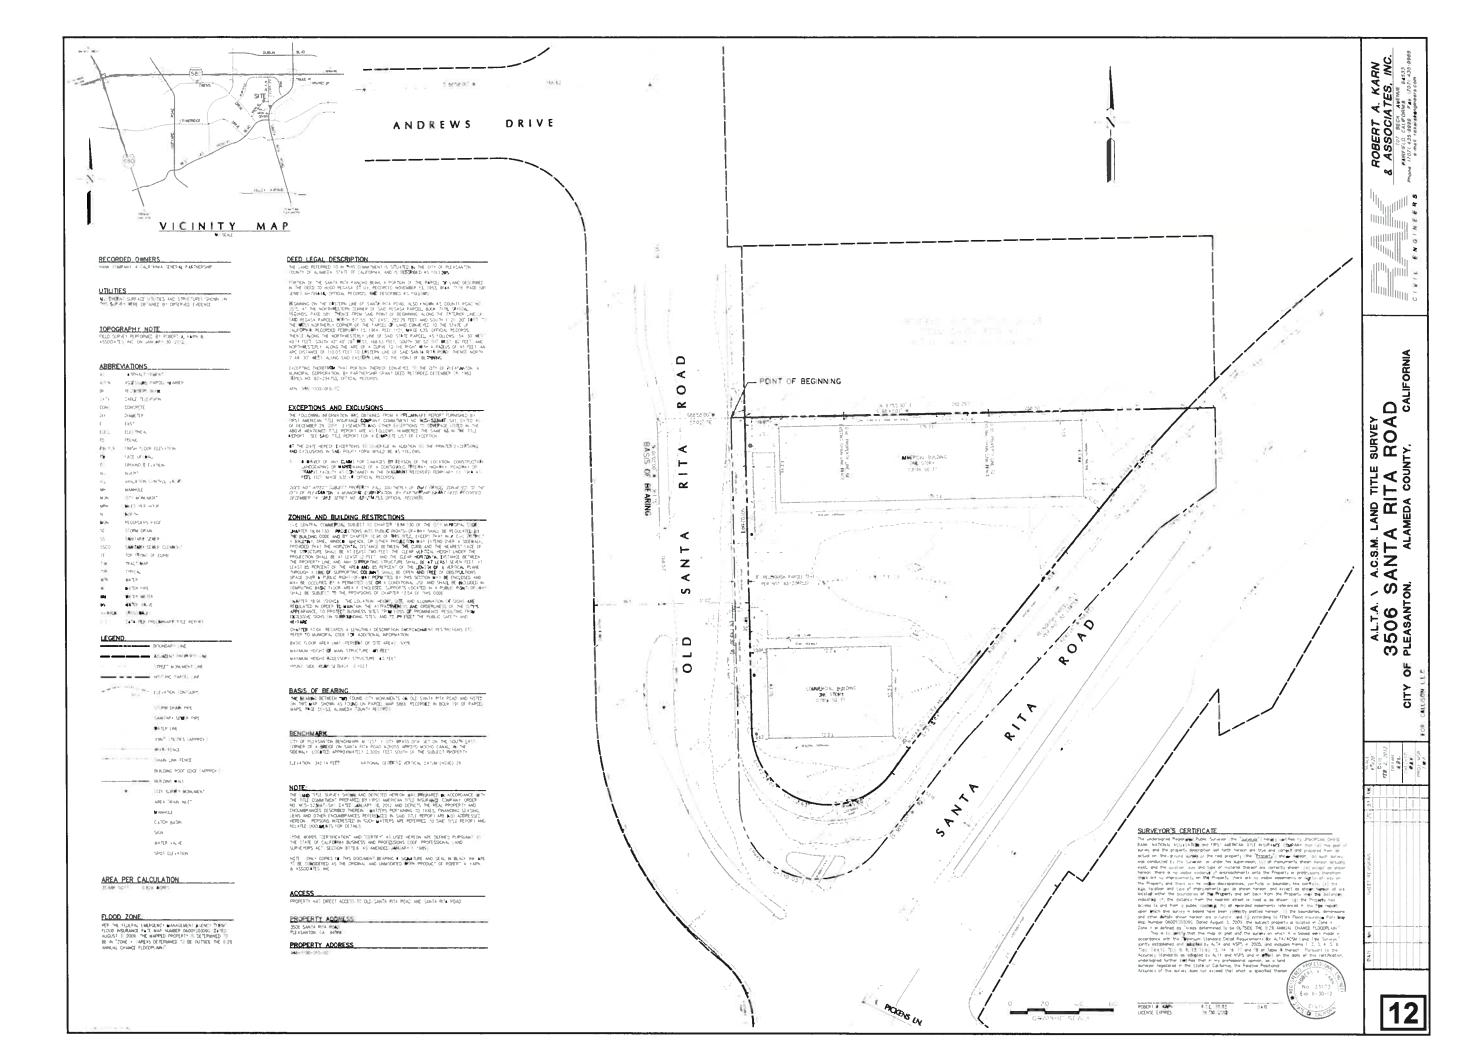

#32129 Old Santa Rita Rd and Santa Rita Rd Pleasanton, CA. 94566

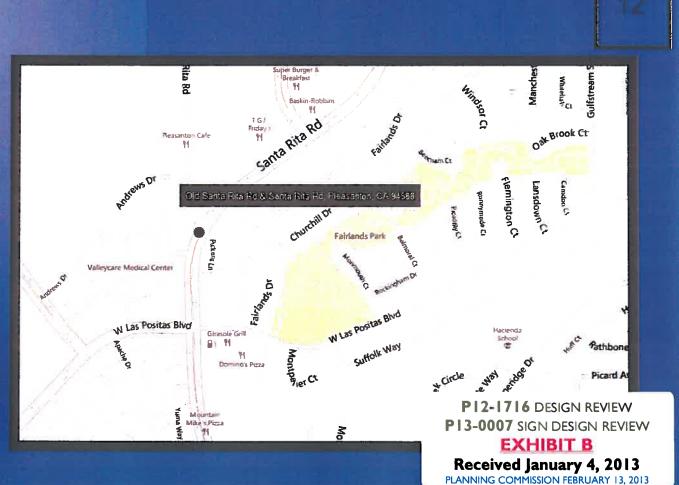



4444 Federal Blvd. San Diego CA 92102 Phone: (619) 527-6100 / Fax: (619) 527-6111 www.signtechUSA.com





JP Morgan Chase Bank #32129

Old Santa Rita Rd and Santa Rita Rd Pleasanton, CA. 94566

Initial Date: 09/21/12

Salesperson: Arthur Navarro

Coordinator: Lisa Brevard

Designer: kendra pickett

Scale: As noted

CUSTOMER APPROVAL

Customer Signature

COPY, COLORS & SIZES

Signtech does NOT provide primary electrical to sign location -**RESPONSIBILITY OF OTHERS!**

Customer Signature

This design is the exclusive property of Signtech and cannot be reproduced in whole or in part, without their prior written approval.

Drawing Number: 12-01179


Work Order Number: 54377

Page No. 1

SIGN LEGEND

			SIGN LEGEND					
Elevation	No.	Sign Type	Description	Sq.F				
	N1	CUSTOM M-25	Custom Internally Illuminated Monument Sign	25.0				
North	N2	CUSTOM LIF-WBO-24	24" White Channel Letters and Logo w/Opaque Returns	36.9				
South	N3	CUSTOM LIF-WBO-24	24" White Channel Letters and Logo w/Opaque Returns	36.9				
East	N4	NONE	REMOVED FROM SCOPE OF WORK					
West	N5	NONE	REMOVED FROM SCOPE OF WORK					
	N6	SUR-TTW-U	Universal ATM Surround					
	N7	AWN-WU-S-NI	Non-Illuminated Sunbrella Awning w/ no descriptor					
	N8	CUSTOM AWN-ATM-S-NI	II Custom Non-Illuminated ATM Sunbrella Awning w/ no descriptor					
	N9	AWN-WU-S-NI	AWN-WU-S-NI Non-Illuminated Sunbrella Awning w/ no descriptor					
	N10	AWN-WU-S-NI	Non-Illuminated Sunbrella Awning w/ no descriptor REMOVED FROM SCOPE OF WORK					
	N11	NONE						
	N12	TOP-FS-DU-N-LED	Narrow ATM Topper	-				
	N13	HB-U	Headache Bar	-				
	N14	TC-P-H-ADA	Pole Mounted Do Not Enter Sign (no Chase Branding)					
	N15	TC-P-ADA	Pole Mounted Handicap Sign					
	N16	TC-P-ADA-V	Pole Mounted Handicap Sign					
	N17	CUSTOM D-2	Non-Illuminated Directional Sign (No Chase Branding)					
	N18	CUSTOM D-2	Non-Illuminated Directional Sign (No Chase Branding)					
	N19	CPC-EWP-20.5-DF	CPC Entry Wall Plaque-Double-Faced					
	N20	COMING SOON	Temporary Coming Soon Sign					
100	N21	NONE	REMOVED FROM SCOPE OF WORK					
	N22	NONE	REMOVED FROM SCOPE OF WORK	-				
	N23	NONE	REMOVED FROM SCOPE OF WORK					
	N24	CUSTOM LNIC-OCT	Custom 12" Dimensional Logo at Drive-Up Canopy	157-7				
	N25		Custom 12" Dimensional Logo at Drive-Up Canopy					
			Total Proposed Co Et	00.0				

at Drive-Op Carlopy	
Total Proposed Sq Ft	98.8
Total Allowable Sq Ft	88.8
Difference	10.0

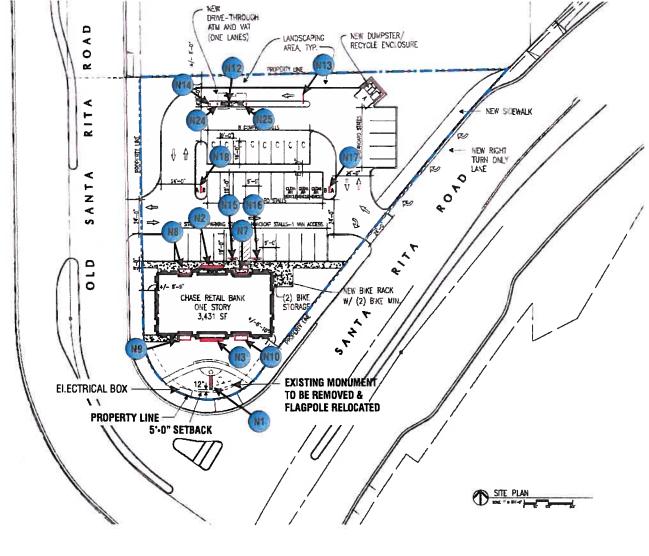









www.signtechUSA.com

JP Morgan Chase Bank #32129

Old Santa Rita Rd and Santa Rita Rd Pleasanton, CA. 94566

Initial Date: 09/21/12
Salesperson: Arthur Navarro
Coordinator: Lisa Brevard
Designer: kendra pickett

Scale: As noted

CUSTOMER APPROVAL

Customer Signature

COPY, COLORS & SIZES

Signtech does NOT provide primary electrical to sign location - RESPONSIBILITY OF OTHERS!

Customer Signature

Date

This design is the exclusive property of Signtech and cannot be reproduced in whole or in part, without their prior written approval.


Drawing Number: 12-01179

Work Order Number: 54377

Site Plan and Sign Legend

Page No. 2



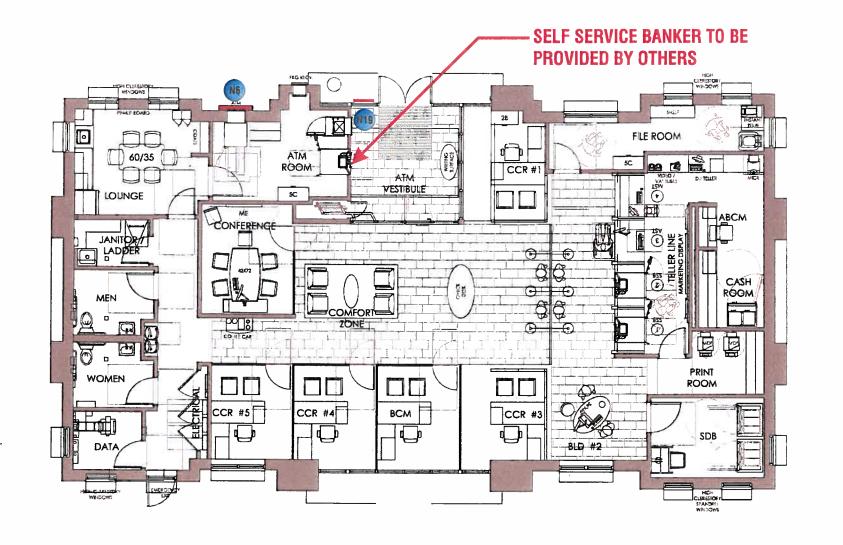

FLOOR PLAN SCALE: 3/32"=1'-0"







JP Morgan Chase Bank #32129

Old Santa Rita Rd and Santa Rita Rd Pleasanton, CA. 94566

Initial Date: 09/21/12

Salesperson: Arthur Navarro
Coordinator: Lisa Brevard

Designer: kendra pickett

Scale: As noted

CUSTOMER APPROVAL

Customer Signature

Date

COPY, COLORS & SIZES

Signtech does NOT provide primary electrical to sign location - RESPONSIBILITY OF OTHERS!

Customer Signature

Dai


This design is the exclusive property of Signtech and cannot be reproduced in whole or in part, without their prior written approval.

Drawing Number: 12-01179

Work Order Number: 54377


Page No. 3

SIGNAGE OVERVIEW

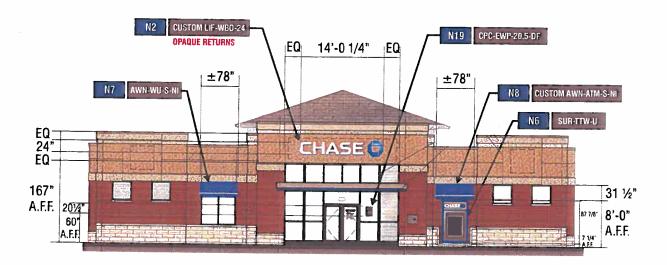


NORTH ELEVATION


SCALE: 1/16"=1'-0"

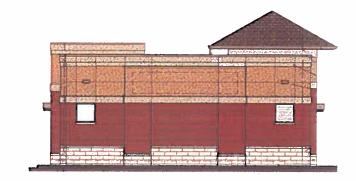

WEST ELEVATION

SCALE: 1/16"=1'-0"

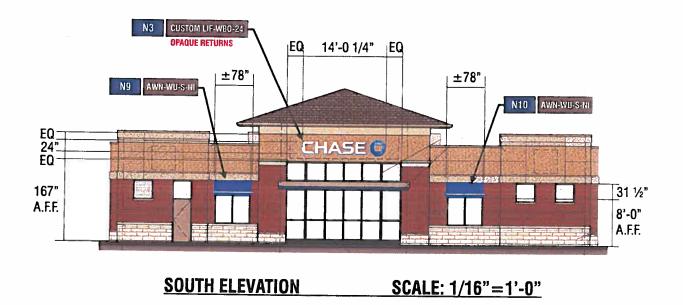

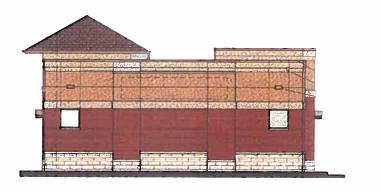

EAST ELEVATION

SCALE: 1/16"=1'-0"



4444 Federal Bivd. San Diego CA 92102 Phone: (619) 527-6100 / Fax: (619) 527-6111 www.signtechUSA.com







JP Morgan Chase Bank #32129

Old Santa Rita Rd and Santa Rita Rd Pleasanton, CA. 94566

Initial Date: __09/21/12

Salesperson: Arthur Navarro

Coordinator: Lisa Brevard

Designer: kendra pickett

Scale: As noted

CUSTOMER APPROVAL

Customer Signature

•

COPY, COLORS & SIZES

Signtech does NOT provide primary electrical to sign location - RESPONSIBILITY OF OTHERS!

Customer Signature

Date


This design is the exclusive property of Signtech and cannot be reproduced in whole or in part, without their prior written approval.

Drawing Number: 12-01179

Work Order Number: 54377

Page No. 4

SIGNAGE OVERVIEW

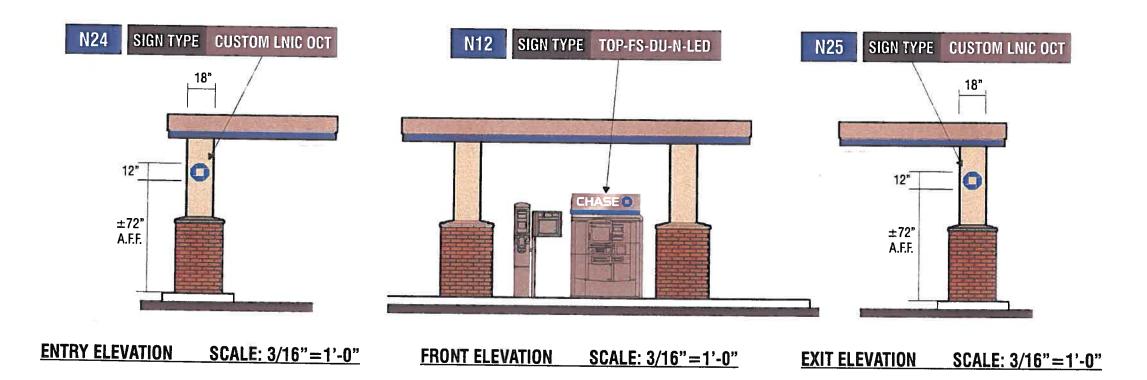



4444 Federal Blvd. San Diego CA 92102 Phone: (619) 527-6100 / Fax: (619) 527-6111 www.signtechUSA.com





JP Morgan Chase Bank #32129

Old Santa Rita Rd and Santa Rita Rd Pleasanton, CA. 94566

Initial Date: 09/21/12

Salesperson: Arthur Navarro

Coordinator: Lisa Brevard

Designer: kendra pickett

Scale: As noted

CUSTOMER APPROVAL

Customer Signature

Date

COPY, COLORS & SIZES

Signtech does NOT provide primary electrical to sign location -

RESPONSIBILITY OF OTHERS!

Customer Signature

Date


This design is the exclusive property of Signtech and cannot be reproduced in whole or in part, without their prior written approval.


Drawing Number: 12-01179

Work Order Number: 54377

Page No. 5

SIGNAGE OVERVIEW

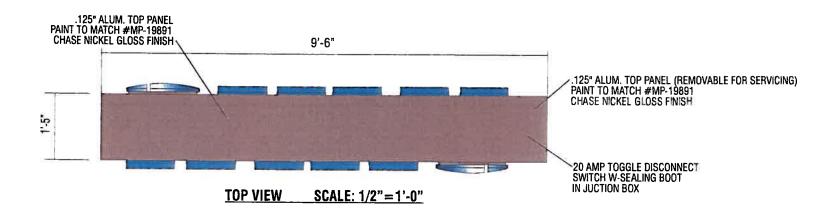

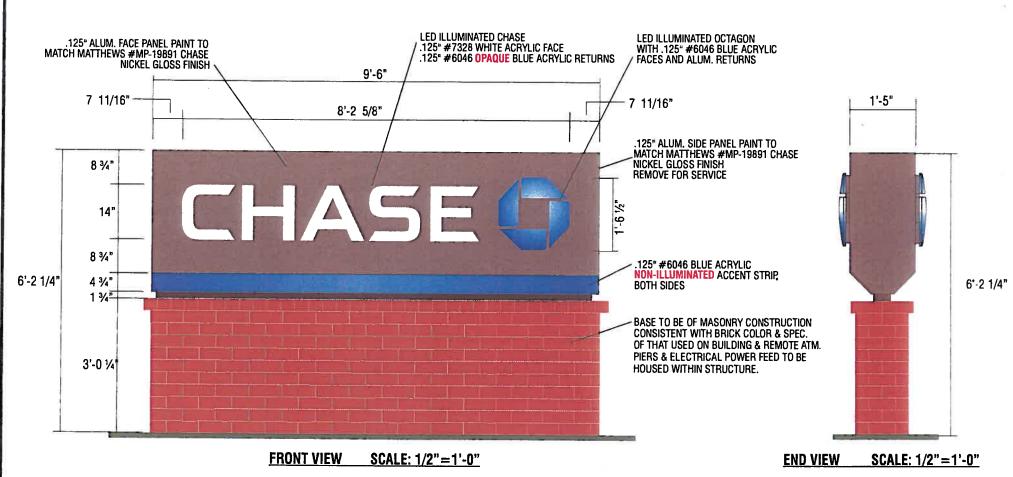

NOTES:

- 1. Design is based on 90 mph 3 sec gust design wind speed per IBC 2006. Exposure C.
- 2. Caisson & vertical foundations are based on a safe lateral soil bearing pressure minimum of 300 psf per foot of depth. Soil report was not fumished. Allowable bearing pressure should be verified prior to placement of concrete. Do not place foundation in fill.
- 3. Concrete shall be mixed to attain a minimum compressive strength of 3000 psi in 28 days.
- 4. Steel support members shall be free from defects and shall meet ASTM A500 grade B with a minimum yield strength of 46000 psi for tube. Steel plate and angle shall meet ASTM A36. Aluminum shapes be extruded from 6061-76 alloy. Aluminum sheet shall be 3003-H14 alloy. Aluminum plate shall be 5052-H34 alloy.
- 5. Structural bolts shall be zinc coated A325 unless otherwise noted. All other fasteners shall be stainless steel or otherwise coated to prevent corrosion.
- 6. Anchor bolts shall be cut from A36 round stock. Exposed surfaces shall be galvanized or coated to prevent corrosion.
- 7. All voids between column base plate and foundation surface shall be completely filled with high strength, non-shrink arout.
- 8. Welds shall be made with E70xx electrodes for steel and a 4000 series filler for aluminum by persons qualified in accordance with AWS standards within the past two years.
- 9. Steet reinforcing bars shall conform to ASTM 615 grade 60 with deformations in accordance with ASTM A-305. Welding of reinforcing bars is prohibited.
- 10. This design is profotypical and should not be used for site specific applications unless deemed suitable by a competent Professional Engineer.

ALL EXPOSED FASTENER HEADS SHALL BE PAINTED TO MATCH THE EXTERIOR CABINET FINISH



4444 Federal Blvd. San Diego CA 92102 Phone: (619) 527-6100 / Fax: (619) 527-6111 www.signtechUSA.com







JP Morgan Chase Bank #32129

Old Santa Rita Rd and Santa Rita Rd Pleasanton, CA. 94566

Initial Date: __09/21/12

Salesperson: Arthur Navarro Coordinator: Lisa Brevard

Designer: kendra pickett

Scale: As noted

CUSTOMER APPROVAL

Customer Signature

Date

Date

COPY, COLORS & SIZES

Signtech does NOT provide primary electrical to sign location -**RESPONSIBILITY OF OTHERS!**

Customer Signature

This design is the exclusive property of Signtech and cannot be reproduced in whole or in part, without their prior written approval.


Drawing Number: 12-01179

Work Order Number: 54377

Page No. 6 PERMIT - 1.04.13

SIGN TYPE CUSTOM M-25 CUSTOM ILLUMINATION & MASONRY BRICK BASE

MANUFACTURE AND INSTALL ONE (1) ILLUMINATED DOUBLE-FACED MONUMENT SIGN

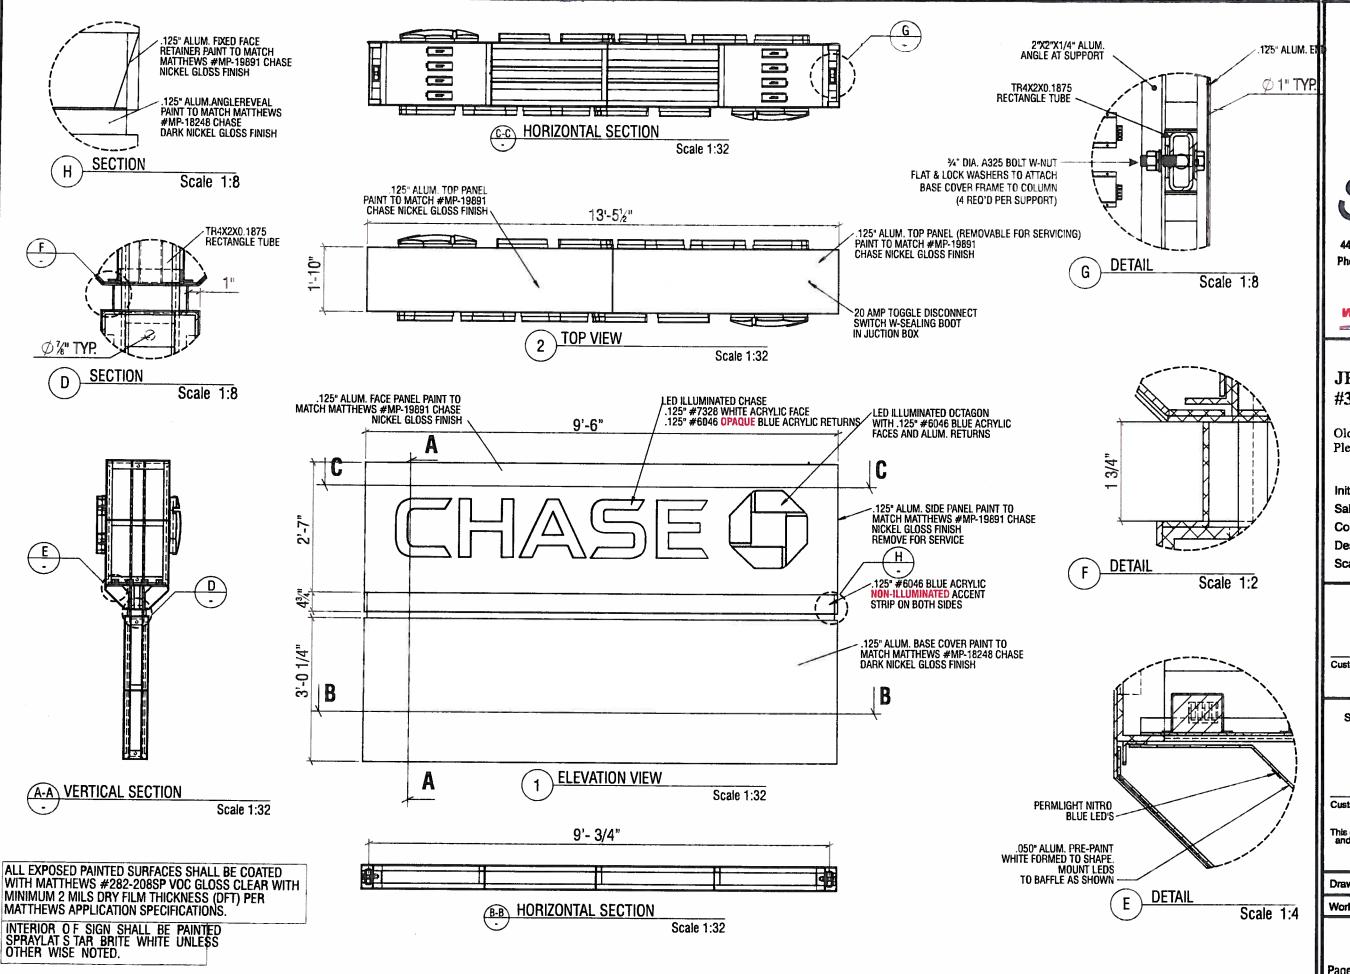



Signtech

4444 Federal Blvd. San Diego CA 92102 Phone: (619) 527-6100 / Fax: (619) 527-6111 www.signtechUSA.com







JP Morgan Chase Bank #32129

Old Santa Rita Rd and Santa Rita Rd Pleasanton, CA. 94566

Initial Date: 09/21/12
Salesperson: Arthur Navarro
Coordinator: Lisa Brevard

Designer: kendra pickett
Scale: As noted

CUSTOMER APPROVAL

Customer Signature

COPY, COLORS & SIZES

Signtech does NOT provide primary electrical to sign location - RESPONSIBILITY OF OTHERS!

Customer Signature

Dat


Date


This design is the exclusive property of Signtech and cannot be reproduced in whole or in part, without their prior written approval.

Drawing Number: 12-01179

Work Order Number: 54377

Page No. 7

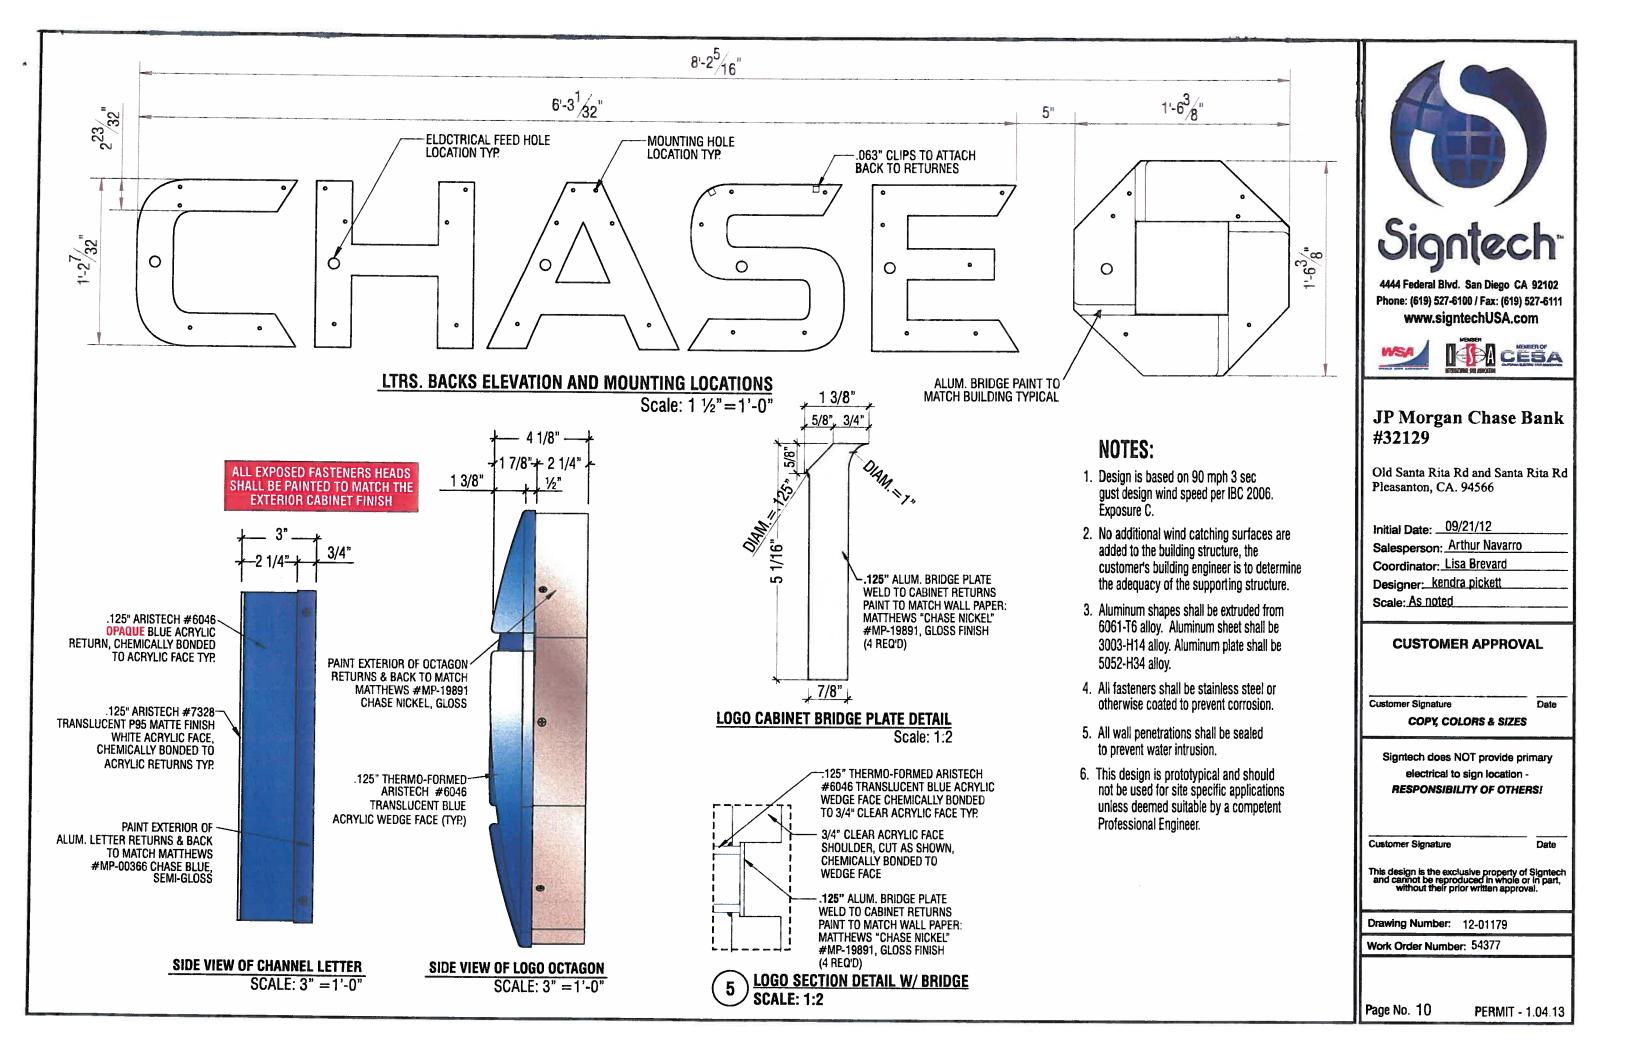

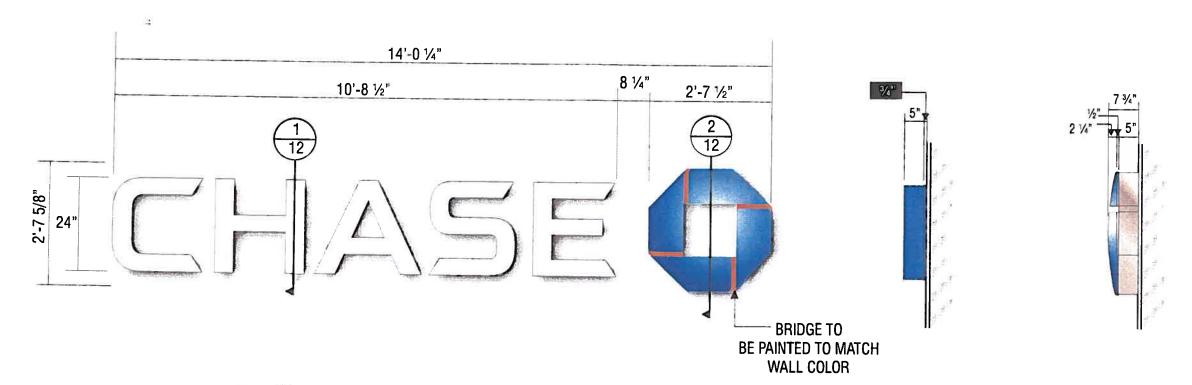

FRONT VIEW SCALE: 1/2"=1'-0"

ENDVIEW OF LETTER SCALE: 1/2"=1'-0"

ENDVIEW OF LOGO SCALE: 1/2"=1'-0"

N3

SIGN TYPE CUSTOM LIF-WB0-24

MANUFACTURE AND INSTALL TWO (2) INTERNALLY ILLUMINATED CUSTOM SETS OF CHANNEL LETTERS

LETTERS.

FACE: 177" ARISTECH #7328 P-95 WHITE PLEX (MATTE SIDE TO BE 1ST SURFACE) CHEM WELDED TO RETURNS RETURNS: 0.118" x 5" DEEP ARISTECH #6046 BLUE WITH OPAQUE BLOCK-OUT VINYL ON 2ND (INTERIOR) SURFACE.

BACKS: .080" ALUM BACK WITH 3/4" x .080" OUTSIDE ALUM RETURN AND 1/2" x 1/8" ALUM ANGLE CLIPS ON INTERIOR OF LETTER FOR FACE ATTACHMENT

PAINT: EXTERIOR PAINTED MATTHEWS MP-00366 CHASE BLUE SEMI-GLOSS FINISH (60-70 UNITS) AND INTERIOR PAINTED SPRAY-LAT STAR BRITE WHITE LIGHT ENHANCEMENT PAINT.

ILLUMINATION: 15MM DESIGNER 71 WHITE NEON & 60MA TRANSFORMERS AS REQUIRED FOR PROPER EVEN ILLUMINATION.

LOGO.

BACKS: .080" ALUM BACK WITH STACK WELDED 5" x .080" ALUM RETURNS.

LOGO CAN FACE: .080" ALUM BRIDGE ELEMENTS WELDED TO INSIDE & OUTSIDE RETURNS PLEX FACE: .118" THERMO FORMED ARISTECH #6046 BLUE LOGO ELEMENTS CHEM WELDED TO

3/4" CLEAR PLEX 2ND SURFACE FACES.

PAINT: EXTERIOR PAINT MATTHEWS "CHASE NICKEL" #MP-19891 GLOSS FINISH AND INTERIOR PAINTED

SPRAY-LAT STAR BRITE WHITE LIGHT ENHANCEMENT PAINT.

ILLUMINATION: 15MM DESIGNER 71 WHITE NEON & 60MA TRANSFORMERS AS REQUIRED FOR PROPER EVEN ILLUMINATION.

ELECTRICAL REQUIREMENTS FOR NEON ILLUMINATION

As required by standard #2161 . Signtech Electrical Advertising, Inc., exclusively uses secondary Ground fault-Interrupted (GFI)


Each Sign MUST have: - A dedicated branch circuit

- Three wires : Line, Ground, and Neutral. - Wire Size : Min 12 GA THHN Copper Wire.

NOTE: The gauge of the wire is dictated by the length of the run & amperage as per NEC Article 600.

- The ground wire must be continuous & go from the sign to the panelboard ground bus

 Voltage between ground and neutral should measure no more than 3 volts. - Power to the sign must be done by a licensed electrical contractor or licensed electrician.

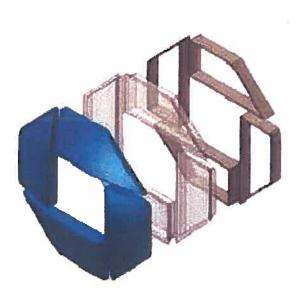

3D VIEW OF OCTAGON



Phone: (619) 527-6100 / Fax: (619) 527-6111 www.signtechUSA.com





JP Morgan Chase Bank #32129

Old Santa Rita Rd and Santa Rita Rd Pleasanton, CA. 94566

Initial Date: __09/21/12

Salesperson: Arthur Navarro

Coordinator: Lisa Brevard Designer: kendra pickett

Scale: As noted

CUSTOMER APPROVAL

Customer Signature

Date

COPY, COLORS & SIZES

Signtech does NOT provide primary electrical to sign location -**RESPONSIBILITY OF OTHERS!**


Customer Signature

This design is the exclusive property of Signtech and cannot be reproduced in whole or in part, without their prior written approval.

Drawing Number: 12-01179

Work Order Number: 54377

Page No. 11

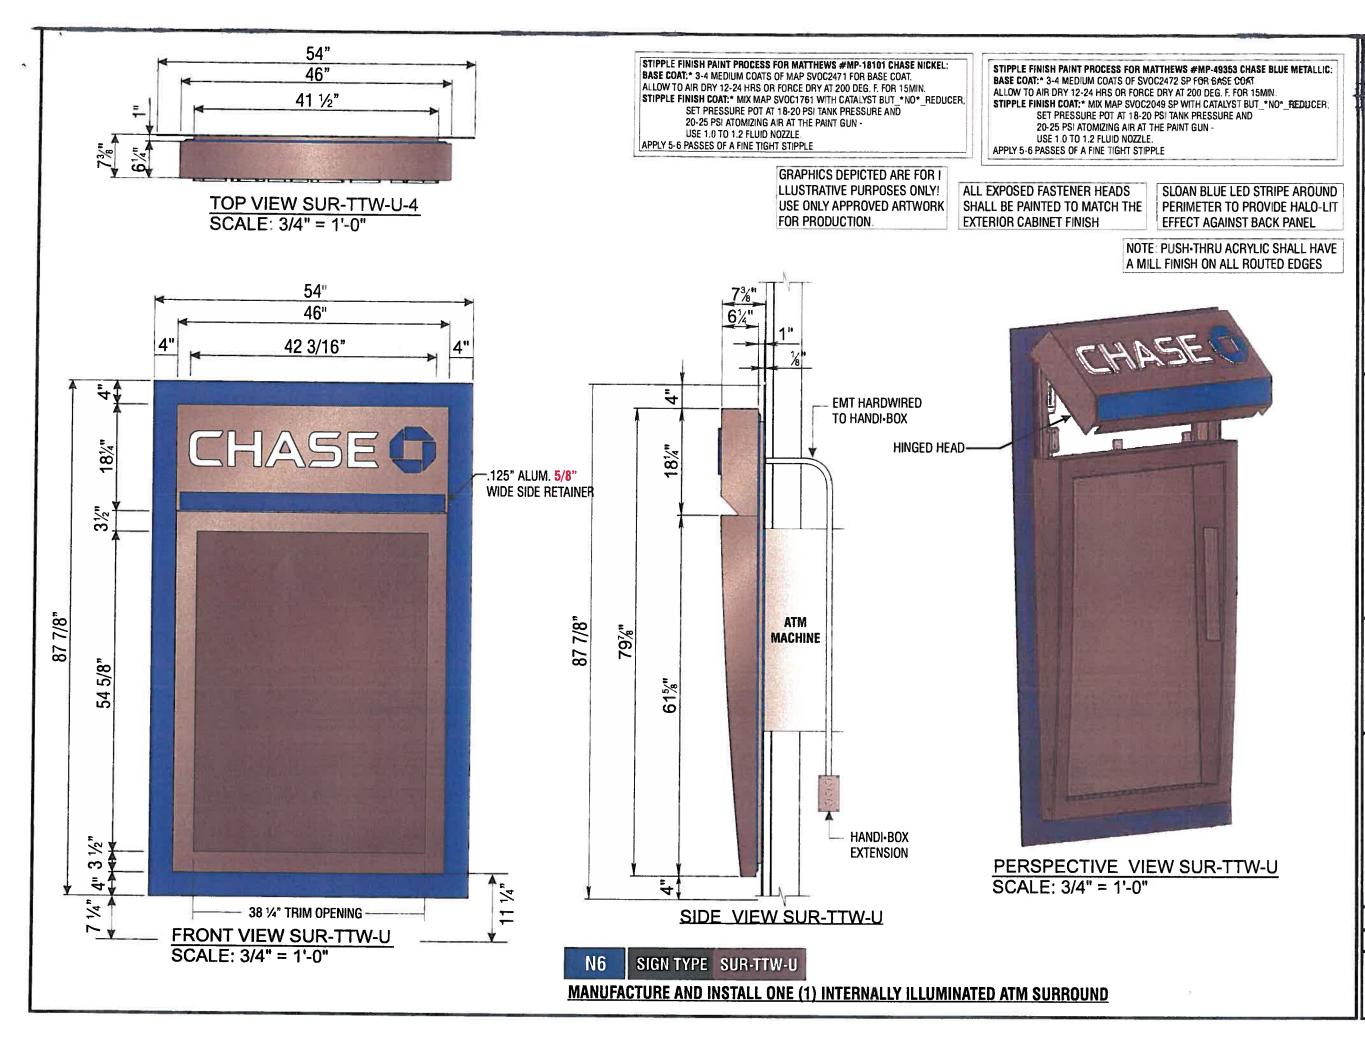



4444 Federal Blvd. San Diego CA 92102 Phone: (619) 527-6100 / Fax: (619) 527-6111 www.signtechUSA.com







JP Morgan Chase Bank #32129

Old Santa Rita Rd and Santa Rita Rd Pleasanton, CA. 94566

Initial Date: __09/21/12

Salesperson: Arthur Navarro

Coordinator: Lisa Brevard

Designer: kendra pickett

Scale: As noted

CUSTOMER APPROVAL

Customer Signature

COPY, COLORS & SIZES

Signtech does NOT provide primary electrical to sign location - RESPONSIBILITY OF OTHERS!

Customer Signature


Date


This design is the exclusive property of Signtech and cannot be reproduced in whole or in part, without their prior written approval.

Drawing Number: 12-01179

Work Order Number: 54377

Page No. 13

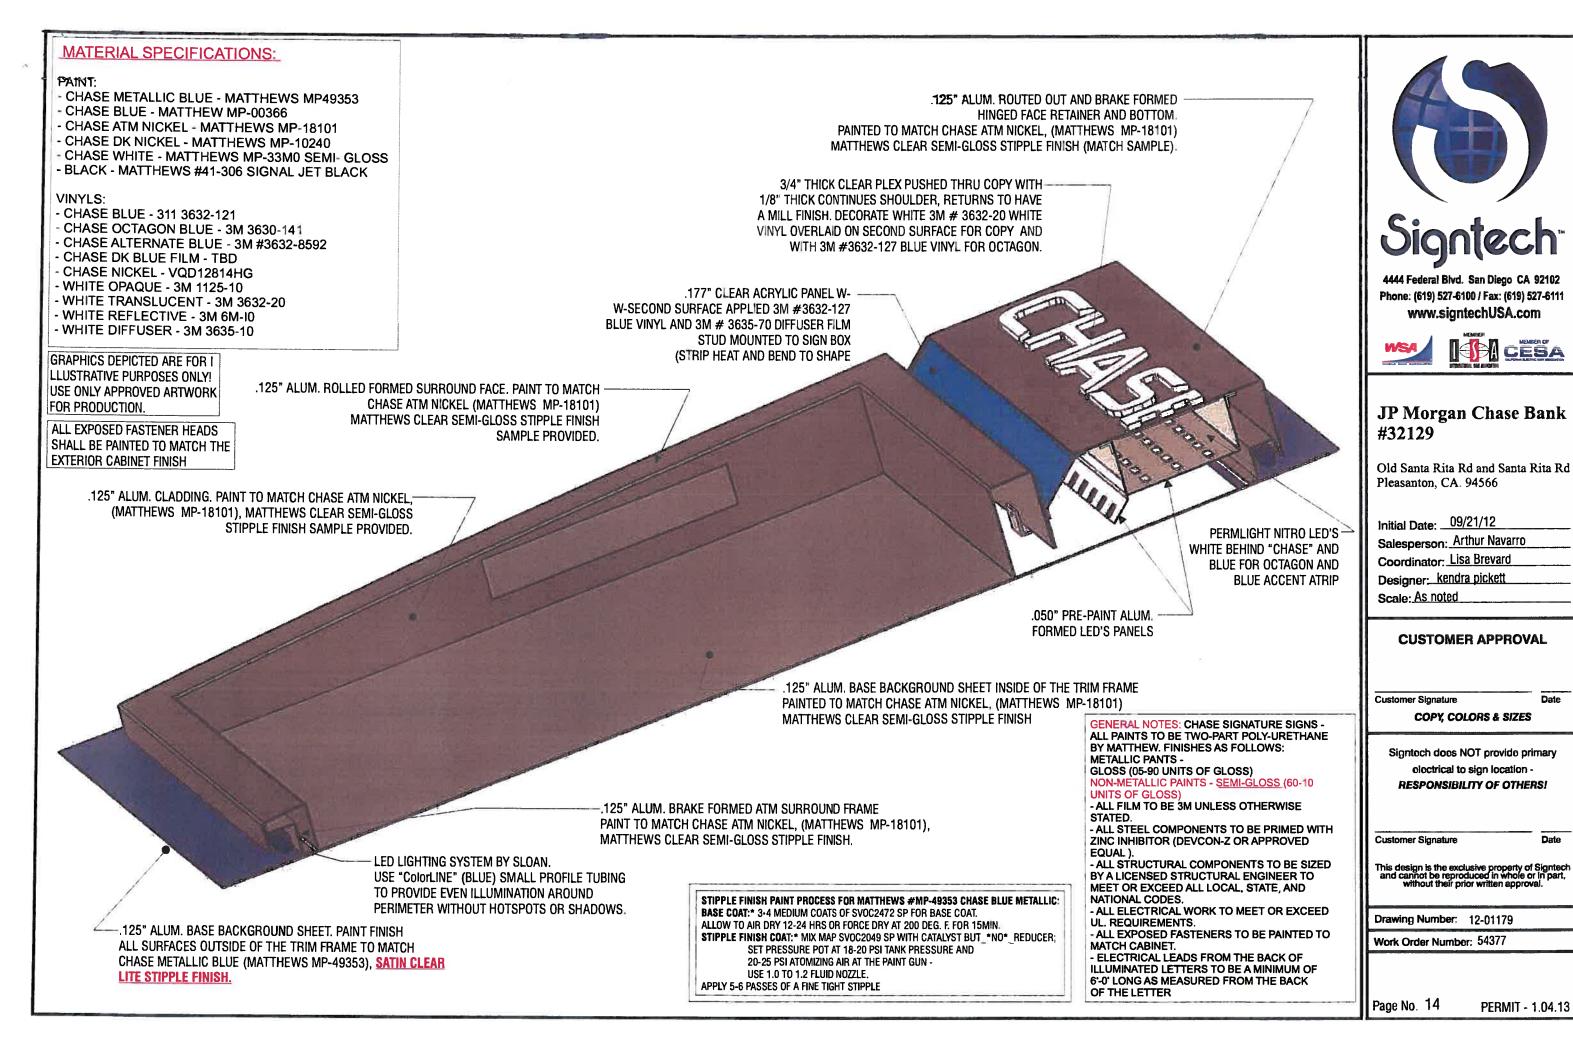

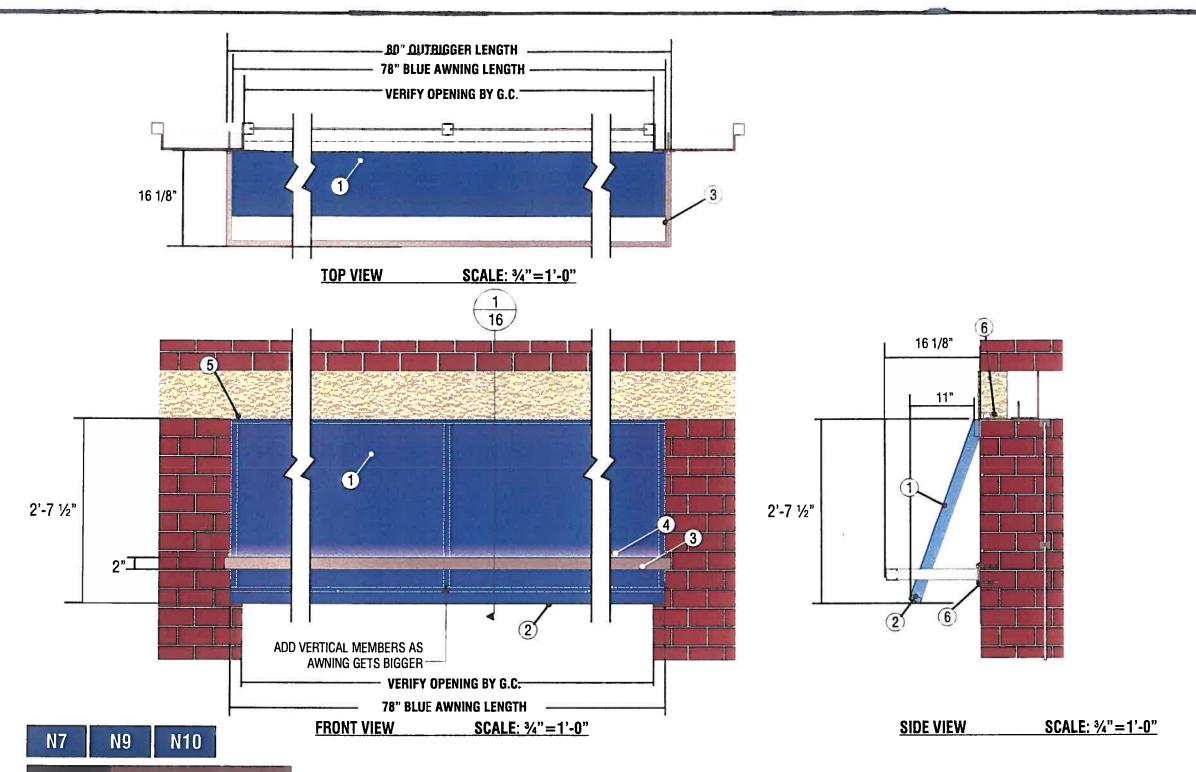

SIGN TYPE AWN-WU-S-WINDOW-NI

MANUFACTURE AND INSTALL THREE (3) NON-ILLUMINATED AWNING - NO DESCRIPTORS

- SKIN OUTSIDE SURFACE OF FRAME ONLY, PAINT FINISH ALL EXPOSED SURFACES MATTHEWS MP #49353 CHASE BLUE METALLIC GLOSS FINISH.
- 2. 1" x 2" x .125" ALUMINUM TUBE AWNING FRAME. FORM AS SHOWN. TUBE TO BE VERTICAL. MITER CUT, WELD AND GRIND SMOOTH AT CORNERS. PAINT FINISH ALL EXPOSED SURFACES CHASE MATTHEWS MP #49353 METALLIC BLUE GLOSS FINISH.
- 1. AWNING SKIN TO BE SUNBRELLA #300-03 REGATTA BLUE. 3. "OUTRIGGERS" TO BE 1" x 2" x .125" ALUMINUM TUBE. TUBE(S) TO BE VERTICAL, FORM AS SHOWN. WELD .25" ALUMINUM FLAT STOCK ON BUILDING SIDE ENDS FOR ATTACHMENT TO WINDOW JAMB. WELD OUTRIGGERS TO 2" x 2" x .125" ALUMINUM CHANNEL AT FRONT AS SHOWN. MITER CUT, WELD AND GRIND SMOOTH AT CORNERS. PAINT FINISH ALL EXPOSED SURFACES MATTHEWS MP #19891 CHASE NICKEL GLOSS FINISH.
- 4. AWNING TO BE ATTACHED TO WALL w/ 3/8" DIA. LAG BOLTS TO EXISTING 16" O.C. VERTICAL STUDS REQUIRED.



4444 Federal Blvd. San Diego CA 92102 Phone: (619) 527-6100 / Fax: (619) 527-6111 www.signtechUSA.com





JP Morgan Chase Bank #32129

Old Santa Rita Rd and Santa Rita Rd Pleasanton, CA. 94566

Initial Date: __09/21/12

Salesperson: Arthur Navarro

Coordinator: Lisa Brevard

Designer: kendra pickett

Scale: As noted

CUSTOMER APPROVAL

Customer Signature

COPY, COLORS & SIZES

Signtech does NOT provide primary electrical to sign location -**RESPONSIBILITY OF OTHERS!**

Customer Signature


This design is the exclusive property of Signtech and cannot be reproduced in whole or in part, without their prior written approval.


Drawing Number: 12-01179

Work Order Number: 54377

PERMIT - 1.04.13

Page No. 15

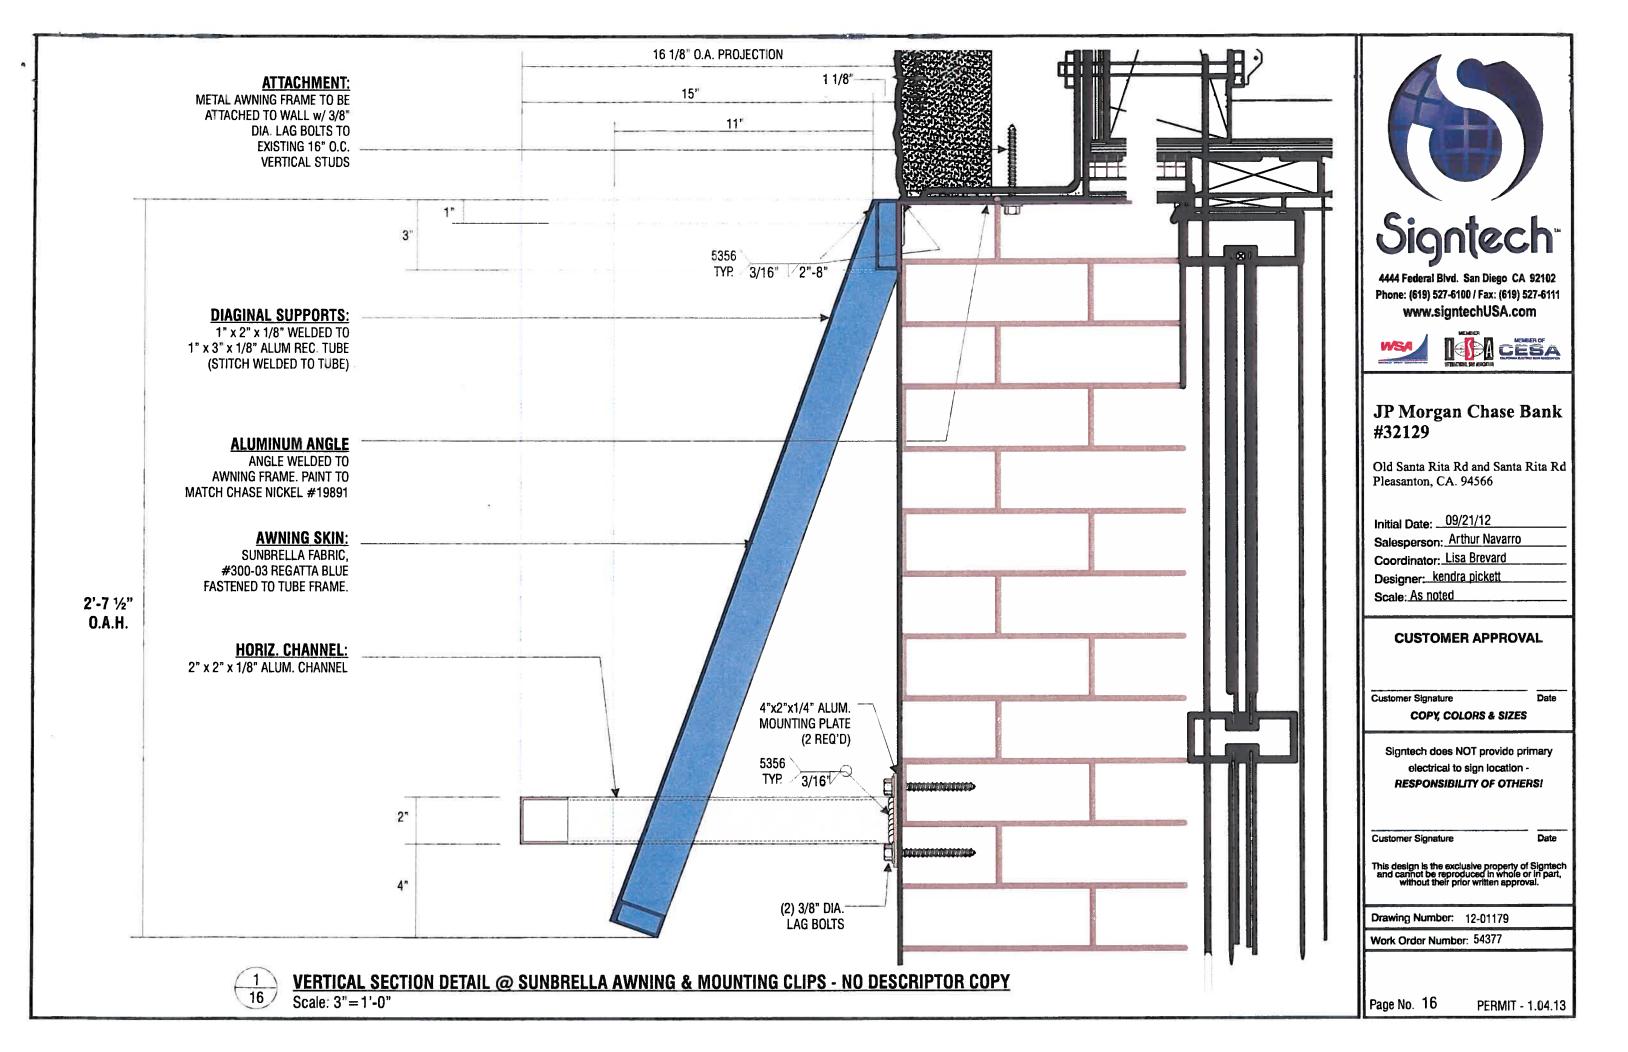

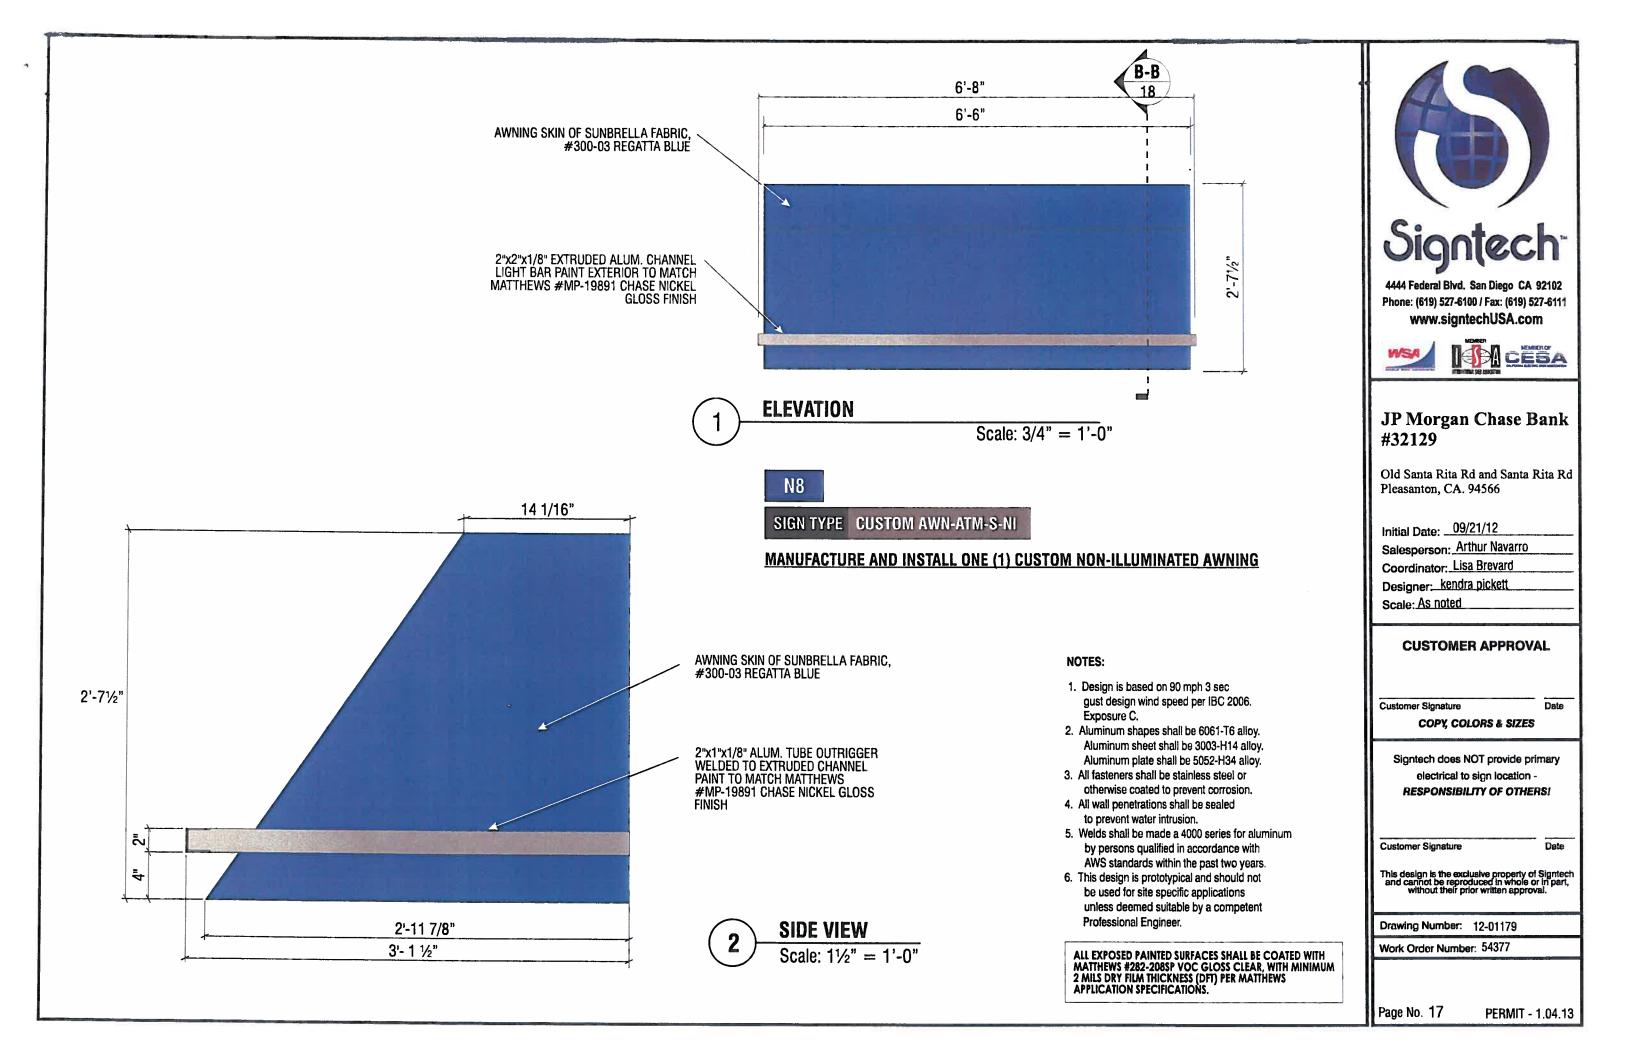


SIGN TYPE TOP-FS-DU-N-LED

NOTES:

- 1.-.125" ALUM. FORMED CABINET FACE, TOP, BOTTOM WITH ROUTED OUT COPY AND SYMBOL PAINT FINISH CHASE NICKEL (MATTHEWS MP-19891) GLOSS FINISH.
- 2.- .125" ALUM. HINGED ACCESS DOOR WITH ROUTED OUT COPY AND SYMBOL SECURE WITH 10-32 S.S. SCREWS AT SIDES PAINTED TO MATCH CHASE NICKEL. PAINT FINISH CHASE NICKEL (MATTHEWS MP-19891) GLOSS FINISH.
- 3.- 3/4" CLEAR STEP-ROUTED PUSH THRU ACRYLIC W/ 3M #3630-20 WHITE VINYL APPLIED FIRST SURFACE & 3M #3635-70 DIFFUSER FILM APPLIED SECOND SURFACE
- 4.- 3/4" CLEAR PUSH THRU ACRYLIC W/ 3M #3632-127 BLUE VINYL APPLIED SECOND SURFACE (TYP. FRONT & BACK)
- 5.- 3/4" CLEAR ACRYLIC PUSH-THRU OCTAGON WITH 3M VINYL #3632-127\PAPPLIED SECOND SURFACE (TYP. EACH SIDE)

- 6.- .063" FORMED ALUM. UPPER WIRECHASE WELDED TO TOPPER CABINET PAINT TO MATCH MATTHEWS #MP-19891 CHASE NICKEL GLOSS FINISH
 .063" FORMED ALUM. LOWER WIRECHASE(NOT SHOWN) 60" LONG SCREWED TO UPPER WIRECHASE & SECURED TO ATM MACHINE WITH 3M VHB TAPE PAINT TO MATCH MATTHEWS
 #MP-49353 CHASE METALLIC BLUE\P{\L*CUT TO LENGTH & INSTALL IN FIELD*}
- 7.- 2" ALUMINUM PIANO HINGE
- 8.- 3/16" CLEAR ACRYLIC WITH SECOND SURFACE APPLIED 3M #3632-127 INTENSE BLUE VINYL & 3M #3635-70 DIFFUSER FILM
- 9.- .125" ALUMINUM END PAINTED "CHASE NICKEL" MATTHEWS MP-19891, GLOSS FINISH
- 10.- 3/4" ALUMINUM SQUARE TUBE FACE FRAME ON BACK OF HINGED FACE PAINTED "CHASE NICKEL" MATTHEWS MP-19891, GLOSS FINISH. INSET FRAME 3/16" FROM EGDE ON SIDES & BOTTOM. TOP TO BE FLUSH WITH EDGE.

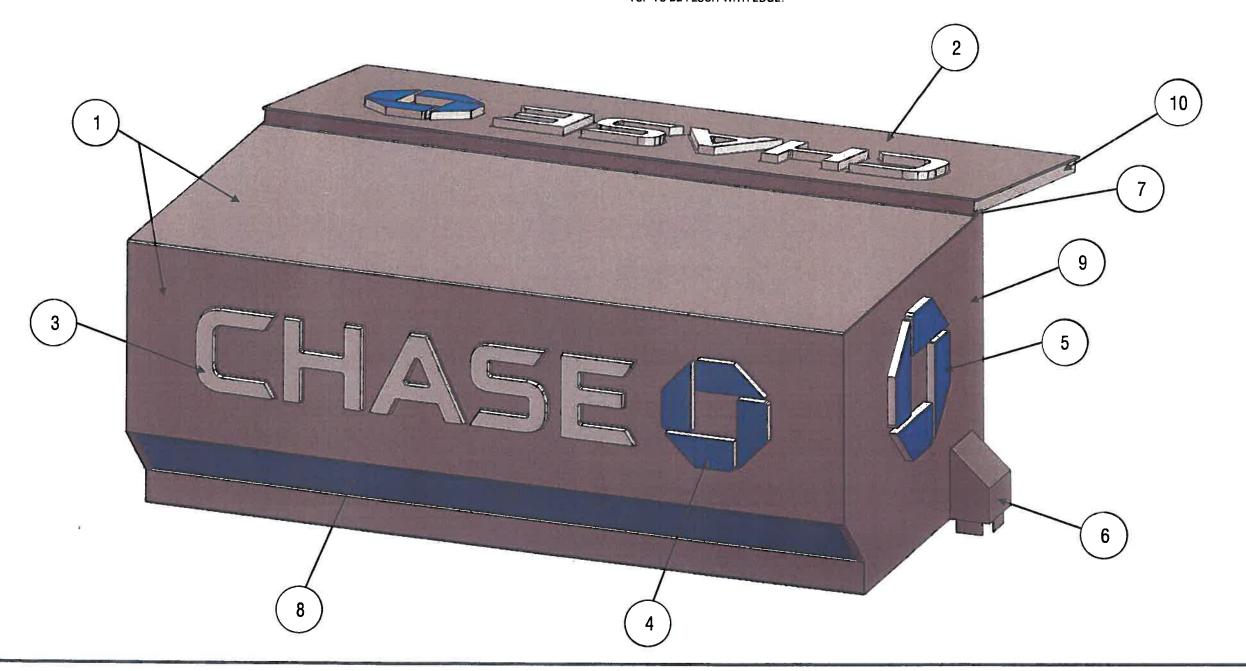



4444 Federal Blvd. San Diego CA 92102 Phone: (619) 527-6100 / Fax: (619) 527-6111 www.signtechUSA.com





JP Morgan Chase Bank #32129

Old Santa Rita Rd and Santa Rita Rd Pleasanton, CA. 94566

Initial Date: 09/21/12

Salesperson: Arthur Navarro

Coordinator: Lisa Brevard

Designer: kendra pickett

Scale: As noted

CUSTOMER APPROVAL

Customer Signature

COPY, COLORS & SIZES

Signtech does NOT provide primary electrical to sign location - RESPONSIBILITY OF OTHERS!

Customer Signature

De

This design is the exclusive property of Signtech and carnot be reproduced in whole or in part, without their prior written approval.

Drawing Number: 12-01179

Work Order Number: 54377

Page No. 20

SIGN TYPE TOP-FS-DU-N-LED



FRONT PERSPECTIVE VIEW

Scale: NTS



FRONT PERSPECTIVE VIEW W/ DOOR OPEN


3

Scale: NTS



BACK PERSPECTIVE VIEW

Scale: NTS

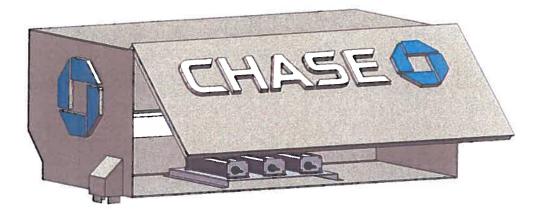

BACK PERSPECTIVE VIEW W/ DOOR OPEN

Scale: NTS



4444 Federal Blvd. San Diego CA 92102 Phone: (619) 527-6100 / Fax: (619) 527-6111 www.signtechUSA.com





JP Morgan Chase Bank #32129

Old Santa Rita Rd and Santa Rita Rd Pleasanton, CA. 94566

Initial Date: 09/21/12

Salesperson: Arthur Navarro

Coordinator: Lisa Brevard
Designer: kendra pickett

Scale: As noted

CUSTOMER APPROVAL

Customer Signature

COPY, COLORS & SIZES

Signtech does NOT provide primary electrical to sign location - RESPONSIBILITY OF OTHERS!

Customer Signature


D

This design is the exclusive property of Signtech and cannot be reproduced in whole or in part, without their prior written approval.

Drawing Number: 12-01179

Work Order Number: 54377

Page No. 21

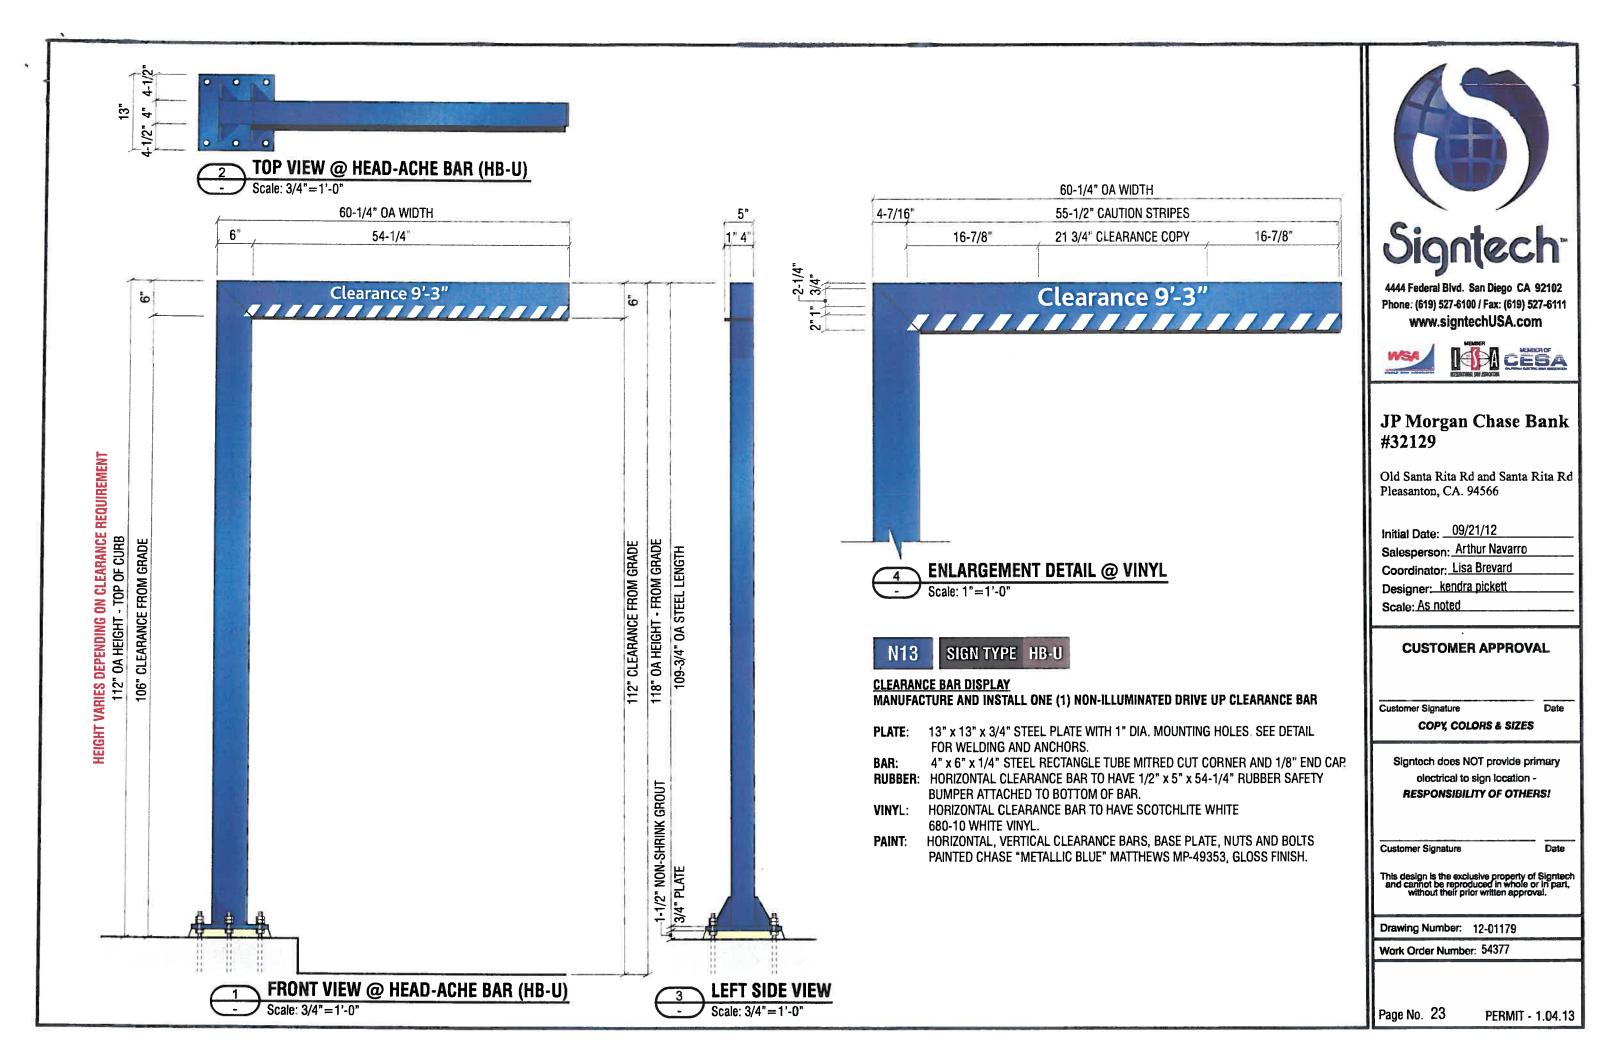

REGULATORY SIGN - DISABLED PARKING (CALIFORNIA & REQUIRED JURISDICTIONS) 1'- 3 3/8" .063" THICK ALUM, CAP PLATE 1'- 0 3/8" LORD GLUED AT THE TOP SIGN TYPE TC-P-ADA-CA MANUFACTURE AND INSTALL ONE (1) N-1 POLE MOUNTED PARKING SIGN 2' - 3 3/8" ADA SIGNAGE SPECIAL ORDERED 1. .125" BRAKE FORMED ALUMINUM SIGN FACE. PAINT FINISH ALL EXPOSED SURFACES DARK NICKEL MATTHEWS MP #18248, GLOSS FINISH (85-90 UNITS). FORM AS SHOWN. ONLY 2. SIGN FACE TO BE ORDERED BY "COMPLIANCE SIGNS" 800.578.1245 FACE TO BE LORDS GLUE TO .125" BRAKE FORM ALUM. SIGN FACE ADA SIGNAGE SPECIAL ORDERED MINIMUM 3. 3" X 3" X 1/4" X 12'-0" LONG EXTRUDED ALUM. TRIANGULAR POST W/ .063" THICK ALUM. CAP PLATE @ TOP. FINE \$250 PAINT FINISH ALL EXPOSED SURFACES TO MATCH MATTHEWS MP-00366 CHASE BLUE, SEMI-GLOSS FINISH (60-70 UNITS). SET SUPPORT INTO CONCRETE FOUNDATION. NO DIRECT EARTH BURIAL ALLOWED. FROM BOTTOM OF SIGN TO GRADE 0.A.H. FINE \$250 3" R99B ALL FASTENERS SHALL BE STAINLESS STEEL OR OTHERWISE **COATED TO PREVENT CORROSION** R99 (CA) #10-24 COUNTER SUNK 3" X 3" X 1/4" X 12'-0" LONG SCREW (3 REQ'D) EXTRUDED ALUM, TRIANGULAR POST .125" BREAKFORMED 12 1/4" ALUM, PANEL **INSIDE DIMENSION** .16 CU, YDS, OF CONC. REQ'D 2'-9" EMBEDIMENT 3" X 3" X 1/4" EXTRUDED **ALUMINUM VERT, SUPPORT** 12 3/8" (O.A) 3" 3'-3" 1'-3 3/8" ů, ALL EMBEDDED ALUM. SHALL TO BE COATED W/ **HORIZONTAL SECTION CARBOLINE BITUMASTIC** 1'-6" DIA. **FRONT VIEW** 50 COAL TAR OR EQUAL SCALE: 1"=1'-0" PRIOR TO INSTALLATION



4444 Federal Blvd. San Diego CA 92102 Phone: (619) 527-6100 / Fax: (619) 527-6111 www.signtechUSA.com





JP Morgan Chase Bank #32129

Old Santa Rita Rd and Santa Rita Rd Pleasanton, CA. 94566

Initial Date: 09/21/12

Salesperson: Arthur Navarro

Coordinator: Lisa Brevard

Designer: kendra pickett

Scale: As noted

CUSTOMER APPROVAL

Customer Signature

Date

COPY, COLORS & SIZES

Signtech does NOT provide primary electrical to sign location -

RESPONSIBILITY OF OTHERS!

Customer Signature

This design is the exclusive property of Signtech and cannot be reproduced in whole or in part, without their prior written approval.

Drawing Number: 12-01179

Work Order Number: 54377

Page No. 27

REGULATORY SIGN - DISABLED PARKING (CALIFORNIA & REQUIRED JURISDICTIONS) 1'-3 3/8" N16 .063" THICK ALUM, CAP PLATE 1'- 0 3/8" LORD GLUED AT THE TOP SIGN TYPE TC-P-ADA-CA-V MANUFACTURE AND INSTALL ONE (1) N-I POLE MOUNTED PARKING SIGN 9 3/8" ADA SIGNAGE SPECIAL ORDERED 1. .125" BRAKE FORMED ALUMINUM SIGN FACE. PAINT FINISH ALL EXPOSED SURFACES DARK NICKEL MATTHEWS MP #18248, GLOSS FINISH (85-90 UNITS). FORM AS SHOWN. 2. SIGN FACE TO BE ORDERED BY "COMPLIANCE SIGNS" 800.578.1245 ADA SIGNAGE FACE TO BE LORDS GLUE TO .125" BRAKE FORM ALUM. SIGN FACE SPECIAL ORDERED MINIMUM 3. 3" X 3" X 1/4" X 12'-0" LONG EXTRUDED ALUM. TRIANGULAR POST FINE \$250 W/ .063" THICK ALUM. CAP PLATE @ TOP. PAINT FINISH ALL EXPOSED SURFACES TO MATCH MATTHEWS MP-00366 CHASE BLUE, SEMI-GLOSS FINISH (60-70 UNITS). VAN ACCESSIBLE SET SUPPORT INTO CONCRETE FOUNDATION. NO DIRECT EARTH BURIAL ALLOWED. FROM BOTTOM OF SIGN TO GRADE. FINE \$250 R99B ALL FASTENERS SHALL BE STAINLESS STEEL OR OTHERWISE **COATED TO PREVENT CORROSION** VAN R99 (CA) #10-24 COUNTER SUNK 3" X 3" X 1/4" X 12'-0" LONG ACCESSIBLE 1/2" SCREW (3 REQ'D) EXTRUDED ALUM, TRIANGULAR POST R7-8B .125" BREAKFORMED 12 1/4" ALUM, PANEL **INSIDE DIMENSION** .16 CU. YDS, OF CONC. REQ'D 2'-9" EMBEDMENT 3" X 3" X 1/4" EXTRUDED **ALUMINUM VERT. SUPPORT** 12 3/8" (O.A) 3" 1'-3 3/8" • ALL EMBEDDED ALUM. SHALL TO BE COATED W/ HORIZONTAL SECTION CARBOLINE BITUMASTIC 1'-6" DIA. **50 COAL TAR OR EQUAL FRONT VIEW** PRIOR TO INSTALLATION SCALE: 1"=1'-0"



4444 Federal Blvd. San Diego CA 92102 Phone: (619) 527-6100 / Fax: (619) 527-6111 www.signtechUSA.com





JP Morgan Chase Bank #32129

Old Santa Rita Rd and Santa Rita Rd Pleasanton, CA. 94566

Initial Date: __09/21/12

Salesperson: Arthur Navarro

Coordinator: Lisa Brevard

Designer: kendra pickett

Scale: As noted

CUSTOMER APPROVAL

Customer Signature

COPY, COLORS & SIZES

Date

Signtech does NOT provide primary electrical to sign location -**RESPONSIBILITY OF OTHERS!**


Customer Signature

This design is the exclusive property of Signtech and cannot be reproduced in whole or in part, without their prior written approval.

Drawing Number: 12-01179


Work Order Number: 54377

Page No. 28

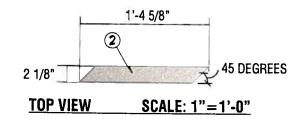

SIGN TYPE

CUSTOM D-2

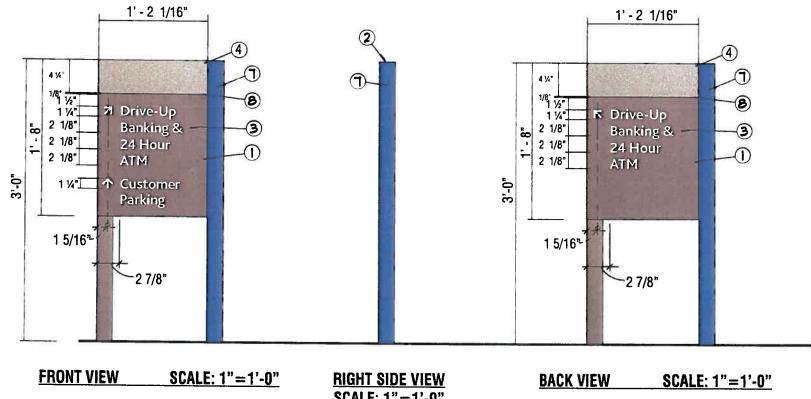

- 1. .125" ALUM. BREAKFORMED SIGN FACE. FORM AS SHOWN. ROUT 1/4" WIDE REVEAL AS SHOWN. WELD .125' ALUM. FLAT STOCK CONTINUOUS AT REVEAL AND AT BASE TO ACT AS A SPACER. WELD TO BACK SIDE FACE AND TOP TO FORM A COMPLETE ENCLOSURE. LOWER OVER FRAME AND SCREW ATTACH AT TOP. PAINT FINISH DARK NICKEL MATTHEWS MP-18248. GLOSS FINISH.
- 2. .125" ALUM. TOP. FORM AS SHOWN. PAINT FINISH NICKEL MATTHEWS MP-19891. GLOSS FINISH. MECHANICALLY ATTACH TO TOP OF FRAME
- 3. COPY AND ARROWS TO BE 3M SCOTCHLITE WHITE #680-10. TYPEFACE TO BLISS BOLD (AVAILABLE AT WWW.TYPOGRAPHY.NET). VERIFY ALL COPY PRIOR TO FABRICATION
- 4. PAINT FINISH SIGNATURE BAND NICKEL MATTHEWS MP-19891. GLOSS FINISH
- 5. NOT USED.
- 6. NOT USED.
- 7. PAINT FINISH BEVELED RETURN TO MATCH PMS 300 (MATTHEWS MP-00366). SEMI-GLOSS
- 8. PAINT FINISH REVEAL DARK NICKEL MATTHEWS MP-18248. GLOSS FINISH







JP Morgan Chase Bank #32129

Old Santa Rita Rd and Santa Rita Rd Pleasanton, CA. 94566

Initial Date: 09/21/12

Salesperson: Arthur Navarro

Coordinator: Lisa Brevard

Designer: kendra pickett

Scale: As noted

CUSTOMER APPROVAL

Customer Signature

Date

COPY, COLORS & SIZES

Signtech does NOT provide primary electrical to sign location - RESPONSIBILITY OF OTHERS!

Customer Signature

Date

This design is the exclusive property of Signtech and cannot be reproduced in whole or in part, without their prior written approval.

Drawing Number: 12-01179


.....

Work Order Number: 54377

No. 29 PERMIT - 1.04.13


Page No. 29


No. 29

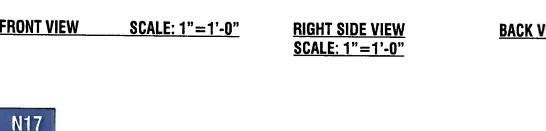

NO CHASE BRANDING

MANUFACTURE AND INSTALL ONE (1) NON-ILLUMINATED DIRECTIONAL SIGN

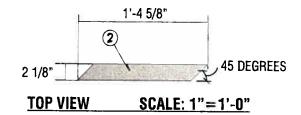

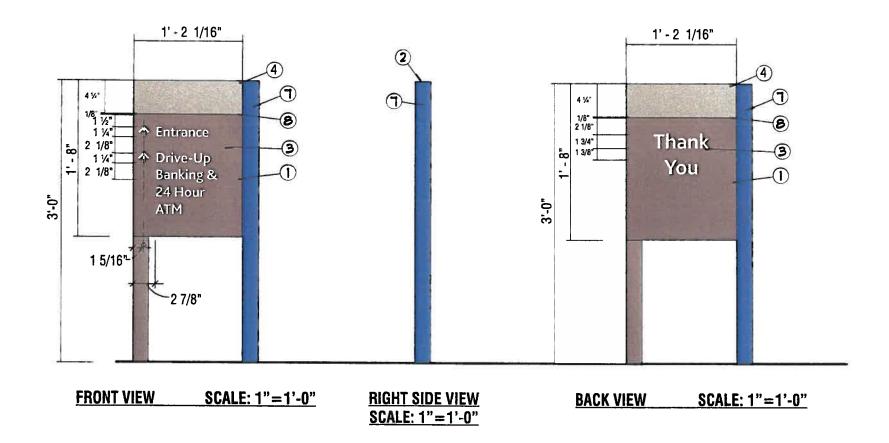

- 1. .125" ALUM. BREAKFORMED SIGN FACE. FORM AS SHOWN. ROUT 1/4" WIDE REVEAL AS SHOWN. WELD .125' ALUM. FLAT STOCK CONTINUOUS AT REVEAL AND AT BASE TO ACT AS A SPACER. WELD TO BACK SIDE FACE AND TOP TO FORM A COMPLETE ENCLOSURE. LOWER OVER FRAME AND SCREW ATTACH AT TOP. PAINT FINISH DARK NICKEL MATTHEWS MP-18248. GLOSS FINISH.
- 2. .125" ALUM. TOP. FORM AS SHOWN. PAINT FINISH NICKEL MATTHEWS MP-19891. GLOSS FINISH. MECHANICALLY ATTACH TO TOP OF FRAME
- 3. COPY AND ARROWS TO BE 3M SCOTCHLITE WHITE #680-10. TYPEFACE TO BLISS BOLD (AVAILABLE AT WWW.TYPOGRAPHY.NET). VERIFY ALL COPY PRIOR TO FABRICATION
- 4. PAINT FINISH SIGNATURE BAND NICKEL MATTHEWS MP-19891. GLOSS FINISH
- 5. NOT USED.
- 6. NOT USED.
- 7. PAINT FINISH BEVELED RETURN TO MATCH PMS 300 (MATTHEWS MP-00366). SEMI-GLOSS
- 8. PAINT FINISH REVEAL DARK NICKEL MATTHEWS MP-18248. GLOSS FINISH



Customer Signature

COPY, COLORS & SIZES

CUSTOMER APPROVAL

Signtech does NOT provide primary electrical to sign location - RESPONSIBILITY OF OTHERS!

Customer Signature

Date

This design is the exclusive property of Signtech and cannot be reproduced in whole or in part, without their prior written approval.

Drawing Number: 12-01179

Work Order Number: 54377

Page No. 30 PERMIT - 1.04.13


N18

SIGN TYPE

CUSTOM D-2

NO CHASE BRANDING

MANUFACTURE AND INSTALL ONE (1) NON-ILLUMINATED DIRECTIONAL SIGN

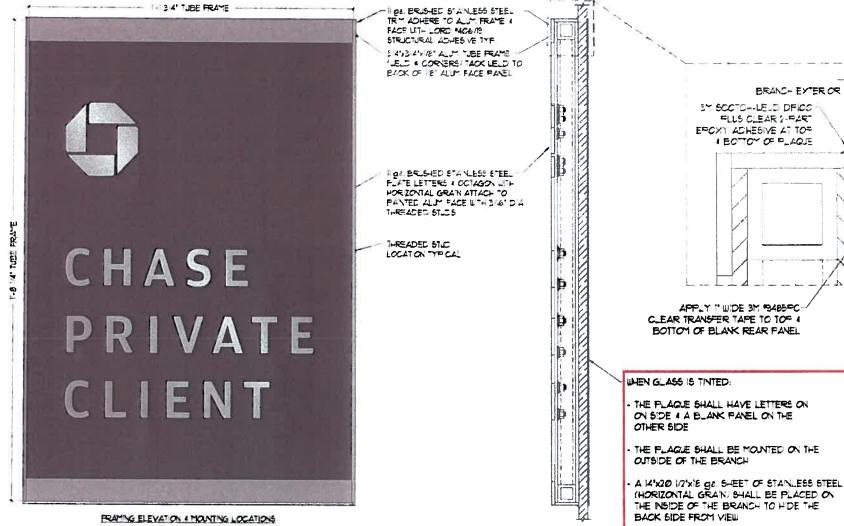

BRANCH NTERIOR

FLUS CLEAR 2-PART TATED GLASS EPOXY ACHESIVE AT TOP MOUNTING SUFACE

> 14'x20 10'x18 QE BRJSHED STAINLESS STEEL SHEET THORIZONTAL GRAIN ORIENTATION ON INSIDE OF BRANCH AT FLAQUE ATTACH TO GLASS WITH 3M \$48500 CLEAR TRANSFER TAPE - NOTE TAPE SHALL BE APPLIED TO ALL FOUR SIDES & DI AGONALLY THROUGH THE MIDDLE OF THE

APPLY 1" WIDE 3M \$3485PC-CLEAR TRANSFER TAPE TO TOP 4 BOTTOM OF BLANK REAR PANEL

THE PLAQUE SHALL HAVE LETTERS ON ON SIDE 4 A BLANK PANEL ON THE

THE PLAQUE SHALL BE MOUNTED ON THE

A 14"x20 17"x18 ge. SHEET OF STANLESS STEEL (HORIZONTAL GRAIN) SHALL BE PLACED ON THE INSIDE OF THE BRANCH TO HIDE THE

MATING SURFACES SHALL BE PREPARED N ACCORDANCE WITH 3M SPECIFICATIONS I RECOMMENDATIONS PRIOR TO APPLICATION OF EPOXY.

EPOXY SHALL BE APPLIED IN ACCORDANCE WITH 3M SPECIFICATIONS & RECCOMENDATIONS

INTED GLASS INSTALLATION DETAIL

GLASS SURFACE SHALL BE CLEANED USING ACETONE OR MEK, THEN APPLY A THIN COAT OF 3M PRIMER EC3901 AND ALLOL TO DRY BEFORE NSTALLING THE SIGN

N19

SIGN TYPE CPC-EWP-20.5-DF

MANUFACTURE AND INSTALL ONE (1) NON-ILLUMINATED ENTRANCE WALL PLAQUE

SIGN SHALL BE FULLY SUPPORTED THROUGHOUT THE CURE TIME OF THE TRANSFER TAPE



Phone: (619) 527-6100 / Fax: (619) 527-6111 www.signtechUSA.com





JP Morgan Chase Bank #32129

Old Santa Rita Rd and Santa Rita Rd Pleasanton, CA. 94566

Initial Date: __09/21/12

Salesperson: Arthur Navarro Coordinator: Lisa Brevard

Designer: kendra pickett

Scale: As noted

CUSTOMER APPROVAL

Customer Signature

COPY. COLORS & SIZES

Date

Signtech does NOT provide primary electrical to sign location -RESPONSIBILITY OF OTHERS!


Customer Signature

This design is the exclusive property of Signtech and cannot be reproduced in whole or in part, without their prior written approval.

Drawing Number: 12-01179

Work Order Number: 54377

Page No. 31

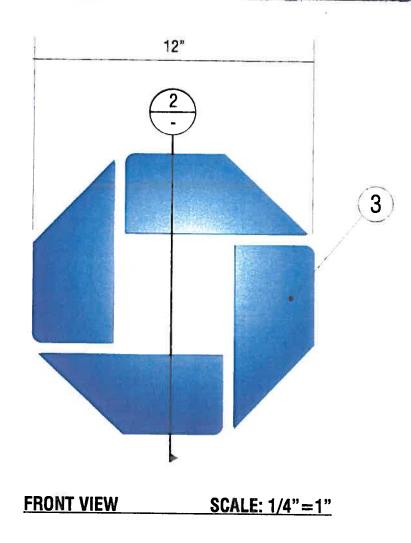


N24 N25

SIGN TYPE CUSTOM LNIC-OCT

MANUFACTURE AND INSTALL TWO (2) NON-ILLUMINATED CHANNEL LOGOS

- 1. .090" ALUM. LETTER RETURN. FORM AS SHOWN. PAINT FINISH CHASE NICKEL MATTHEWS MP# 19891, GLOSS FINISH.
- 2. OCTAGON TO BE THERMOFORMED ACRYLIC. PAINT FINISH ALL EXPOSED SURFACES MATTHEWS MP# 00366 (PMS #300 BLUE), SEMI-GLOSS.
- 3. .090" ALUMINUM OCTAGON RETURN. FORM AS SHOWN. PAINT FINISH MATTHEWS MP# 00366 (PMS #300 BLUE), SEMI-GLOSS.
- 4. .090" ALUMINUM INTERMITTENT ATTACHMENT CLIPS AS REQ'D.
- 5. 1/4" THREADED ROD AS REQ'D FOR ATTACHMENT OF LOGO TO WALL.
 DOUBLE MOUNT FASTEN THREADED ROD TO ATTACHMENT CLIP.
 SET LETTERS AT 1/2" STANDOFF FROM WALL. ATTACH LETTERS
 TO WALL WITH SILICONE CAULK AS REQUIRED FOR SECURE FASTENING.

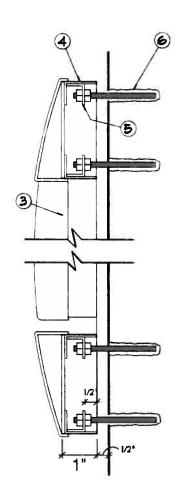

2 DETAIL AT OCTAGON



COPY, COLORS & SIZES

Signtech does NOT provide primary

electrical to sign location -

RESPONSIBILITY OF OTHERS!

This design is the exclusive property of Signtech and cannot be reproduced in whole or in part, without their prior written approval.


PERMIT - 1.04.13

Drawing Number: 12-01179

Work Order Number: 54377

Customer Signature

Page No. 34

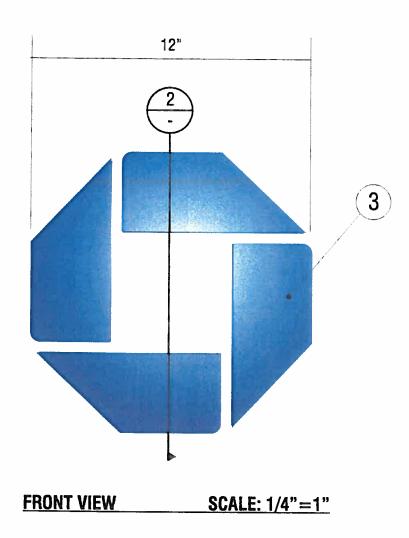


N24 N25

SIGN TYPE CUSTOM LNIC-OCT

MANUFACTURE AND INSTALL TWO (2) NON-ILLUMINATED CHANNEL LOGOS

- 1. .090" ALUM. LETTER RETURN. FORM AS SHOWN. PAINT FINISH CHASE NICKEL MATTHEWS MP# 19891, GLOSS FINISH.
- 2. OCTAGON TO BE THERMOFORMED ACRYLIC. PAINT FINISH ALL EXPOSED SURFACES MATTHEWS MP# 00366 (PMS #300 BLUE), SEMI-GLOSS.
- .090" ALUMINUM OCTAGON RETURN. FORM AS SHOWN. PAINT FINISH MATTHEWS MP# 00366 (PMS #300 BLUE), SEMI-GLOSS.
- 4. .090" ALUMINUM INTERMITTENT ATTACHMENT CLIPS AS REQ'D.
- 5. 1/4" THREADED ROD AS REQ'D FOR ATTACHMENT OF LOGO TO WALL.
 DOUBLE MOUNT FASTEN THREADED ROD TO ATTACHMENT CLIP.
 SET LETTERS AT 1/2" STANDOFF FROM WALL. ATTACH LETTERS
 TO WALL WITH SILICONE CAULK AS REQUIRED FOR SECURE FASTENING.

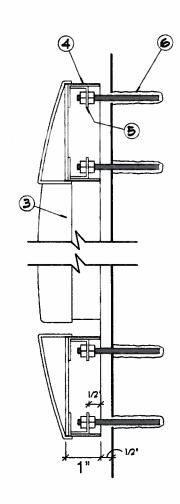

2 DETAIL AT OCTAGON

