



1/4" = 1'-0"

DESIGNER OF DISCREPANCIES.

Install per manufacturer's requirements. 2. 2 x 3 over 3 x 10 barge rafter. 1 x 6 western red cedar eaves. 3. 6" seamless gutter over 2 x 10 fascia.

Copper cap. 5. Knee brace: 8 x 8 horizontal, 4 x 8 diagonal & 3 x 8 vertical, all western red cedar trim.

Copper cap. Sloped 4 x 6 over 3 x 14 trim at wall.


or felt).


grade or 2" above concrete or paving.

10. Sloped 4 x 6 over 3 x 14 trim at wall. 11. Stucco over 4 x 10 cap.

at trellis pier.

13. Stone tile at exterior stair case. Copper cap.

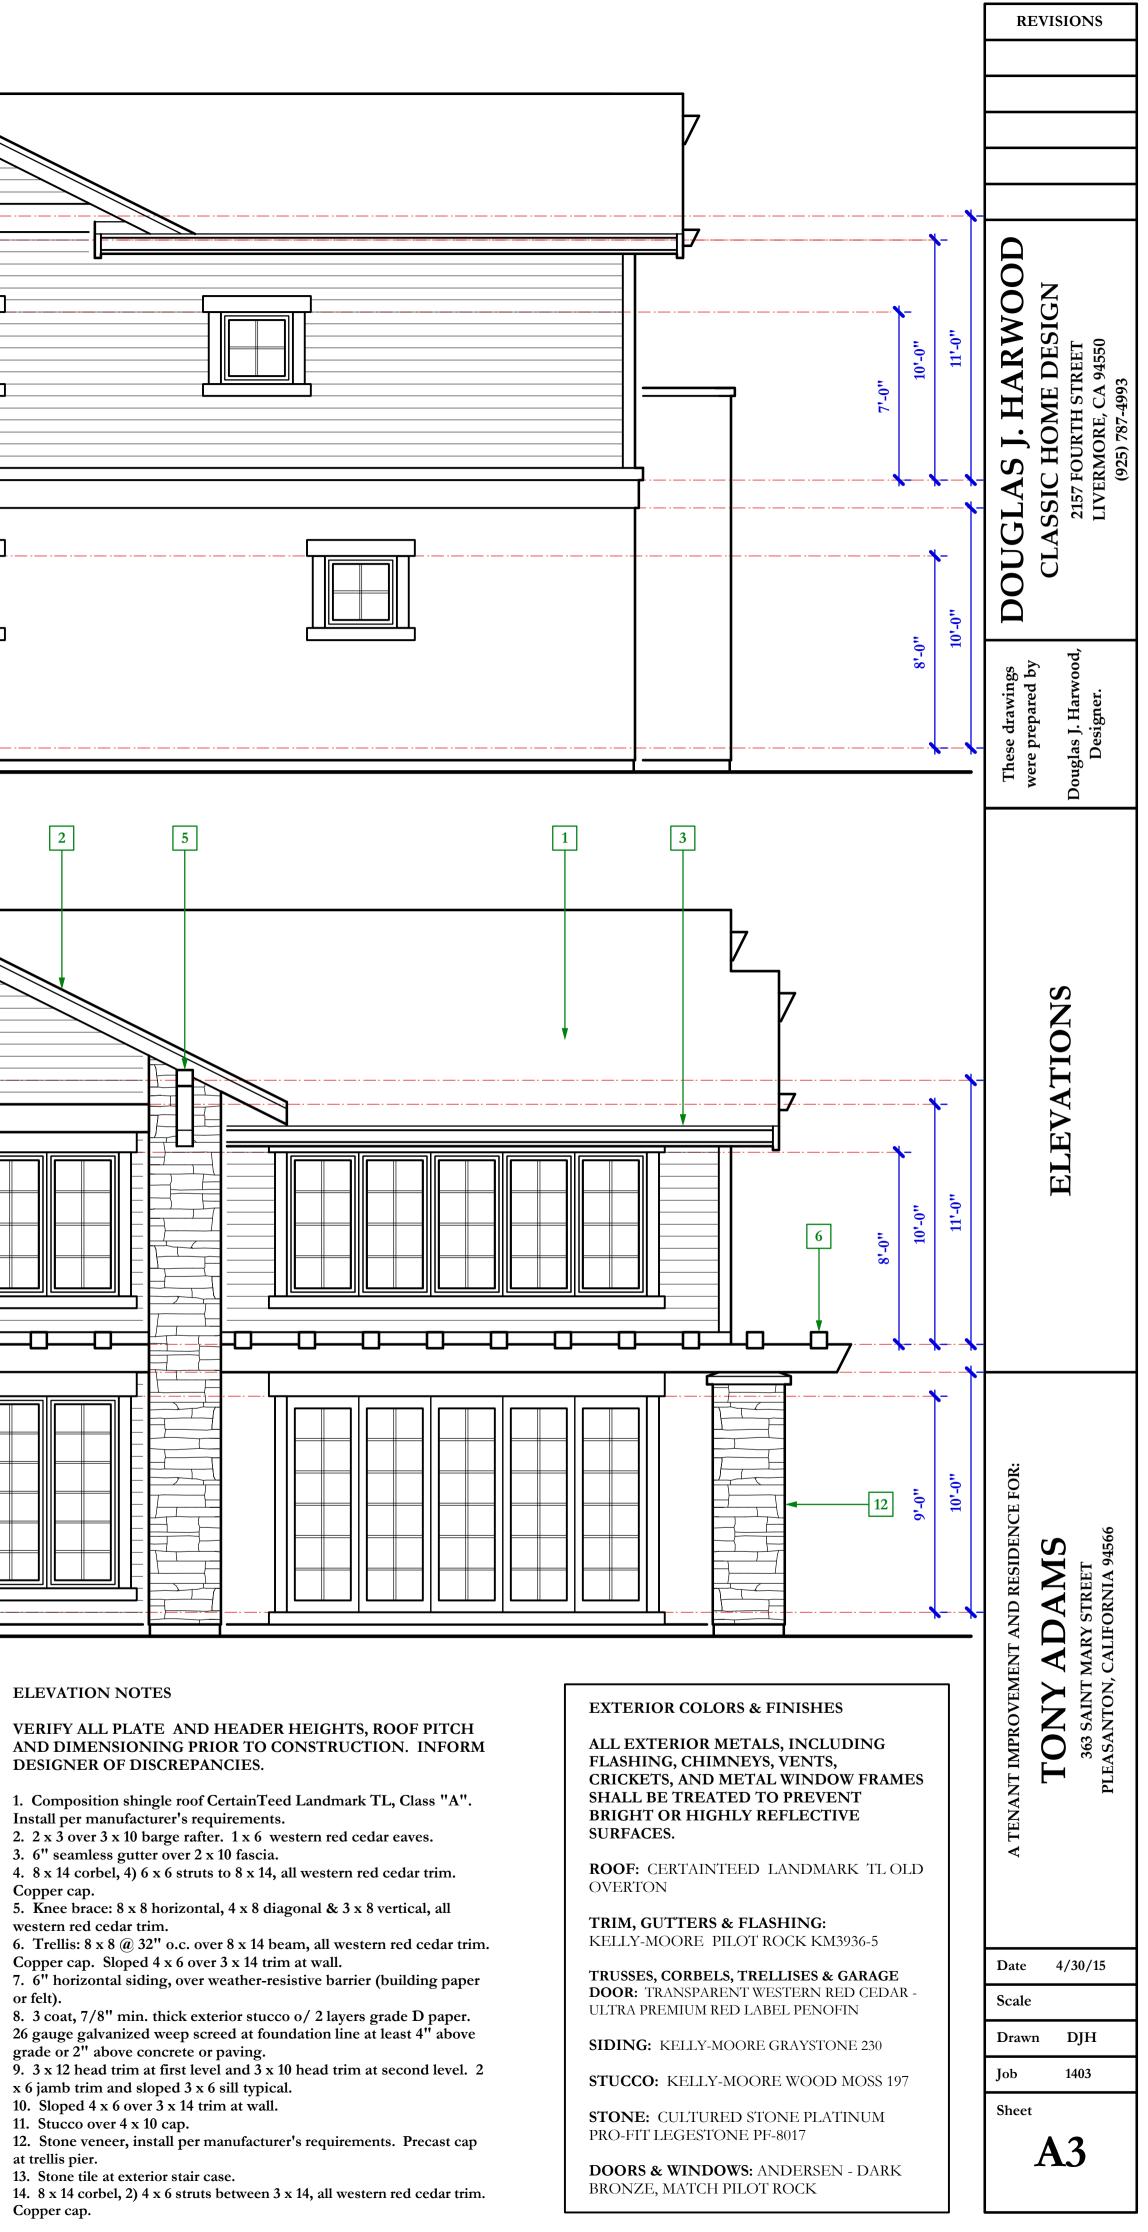

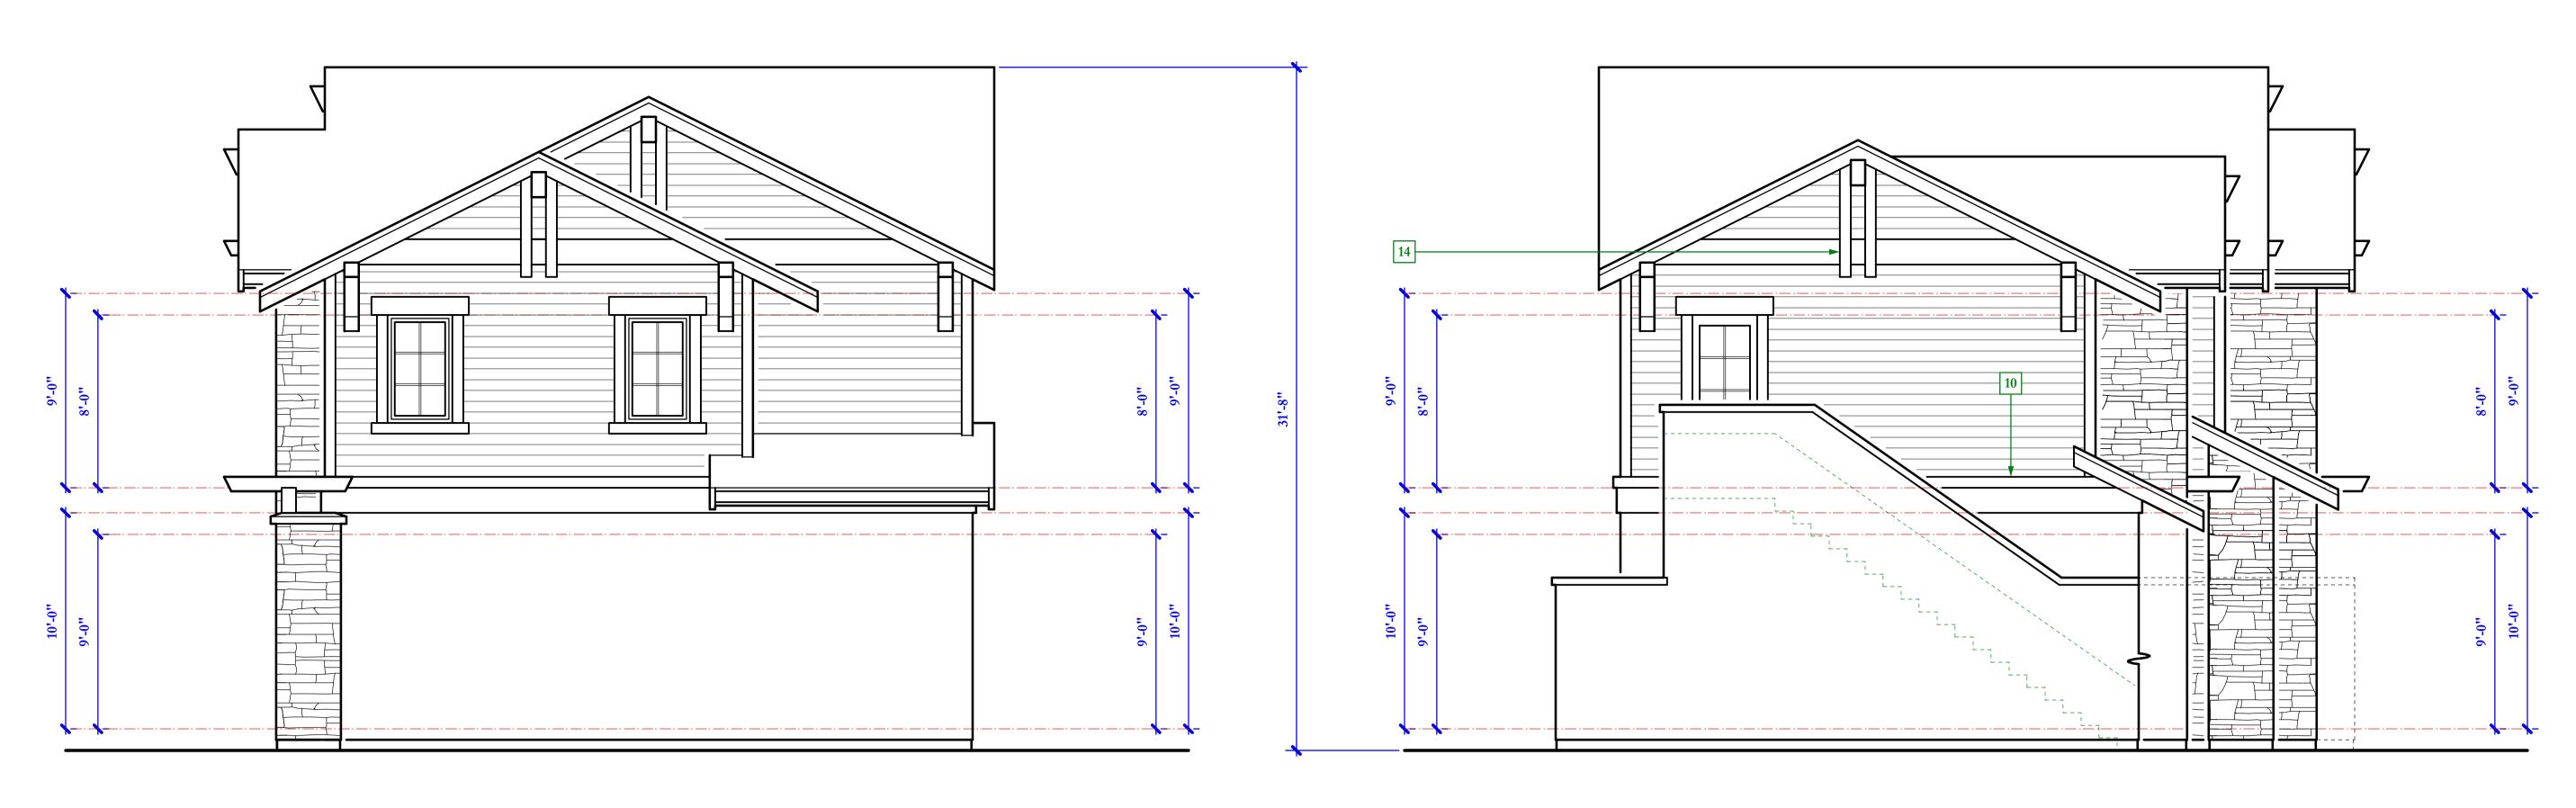

### **NORTH ELEVATION** 1/4" = 1'-0"

#### **ELEVATION NOTES**

VERIFY ALL PLATE AND HEADER HEIGHTS, ROOF PITCH AND DIMENSIONING PRIOR TO CONSTRUCTION. INFORM DESIGNER OF DISCREPANCIES.

1. Composition shingle roof CertainTeed Landmark TL, Class "A".

Install per manufacturer's requirements. 2. 2 x 3 over 3 x 10 barge rafter. 1 x 6 western red cedar eaves.

3. 6" seamless gutter over 2 x 10 fascia.

4. 8 x 14 corbel, 4) 6 x 6 struts to 8 x 14, all western red cedar trim.

Copper cap. 5. Knee brace: 8 x 8 horizontal, 4 x 8 diagonal & 3 x 8 vertical, all western red cedar trim.

6. Trellis: 8 x 8 @ 32" o.c. over 8 x 14 beam, all western red cedar trim. Copper cap. Sloped 4 x 6 over 3 x 14 trim at wall. 7. 6" horizontal siding, over weather-resistive barrier (building paper

or felt).

8. 3 coat, 7/8" min. thick exterior stucco o/ 2 layers grade D paper.
26 gauge galvanized weep screed at foundation line at least 4" above

grade or 2" above concrete or paving.
9. 3 x 12 head trim at first level and 3 x 10 head trim at second level. 2 x 6 jamb trim and sloped 3 x 6 sill typical.
10. Sloped 4 x 6 over 3 x 14 trim at wall.

11. Stucco over 4 x 10 cap.

12. Stone veneer, install per manufacturer's requirements. Precast cap

at trellis pier. 13. Stone tile at exterior stair case.

14. 8 x 14 corbel, 2) 4 x 6 struts between 3 x 14, all western red cedar trim. Copper cap.

### **EXTERIOR COLORS & FINISHES**

ALL EXTERIOR METALS, INCLUDING FLASHING, CHIMNEYS, VENTS, CRICKETS, AND METAL WINDOW FRAMES SHALL BE TREATED TO PREVENT **BRIGHT OR HIGHLY REFLECTIVE** SURFACES.

ROOF: CERTAINTEED LANDMARK TL OLD OVERTON

**TRIM, GUTTERS & FLASHING:** KELLY-MOORE PILOT ROCK KM3936-5

TRUSSES, CORBELS, TRELLISES & GARAGE DOOR: TRANSPARENT WESTERN RED CEDAR -ULTRA PREMIUM RED LABEL PENOFIN


SIDING: KELLY-MOORE GRAYSTONE 230

STUCCO: KELLY-MOORE WOOD MOSS 197

**STONE:** CULTURED STONE PLATINUM PRO-FIT LEGESTONE PF-8017


DOORS & WINDOWS: ANDERSEN - DARK BRONZE, MATCH PILOT ROCK

**SOUTH ELEVATION** 1/4'' = 1'-0''

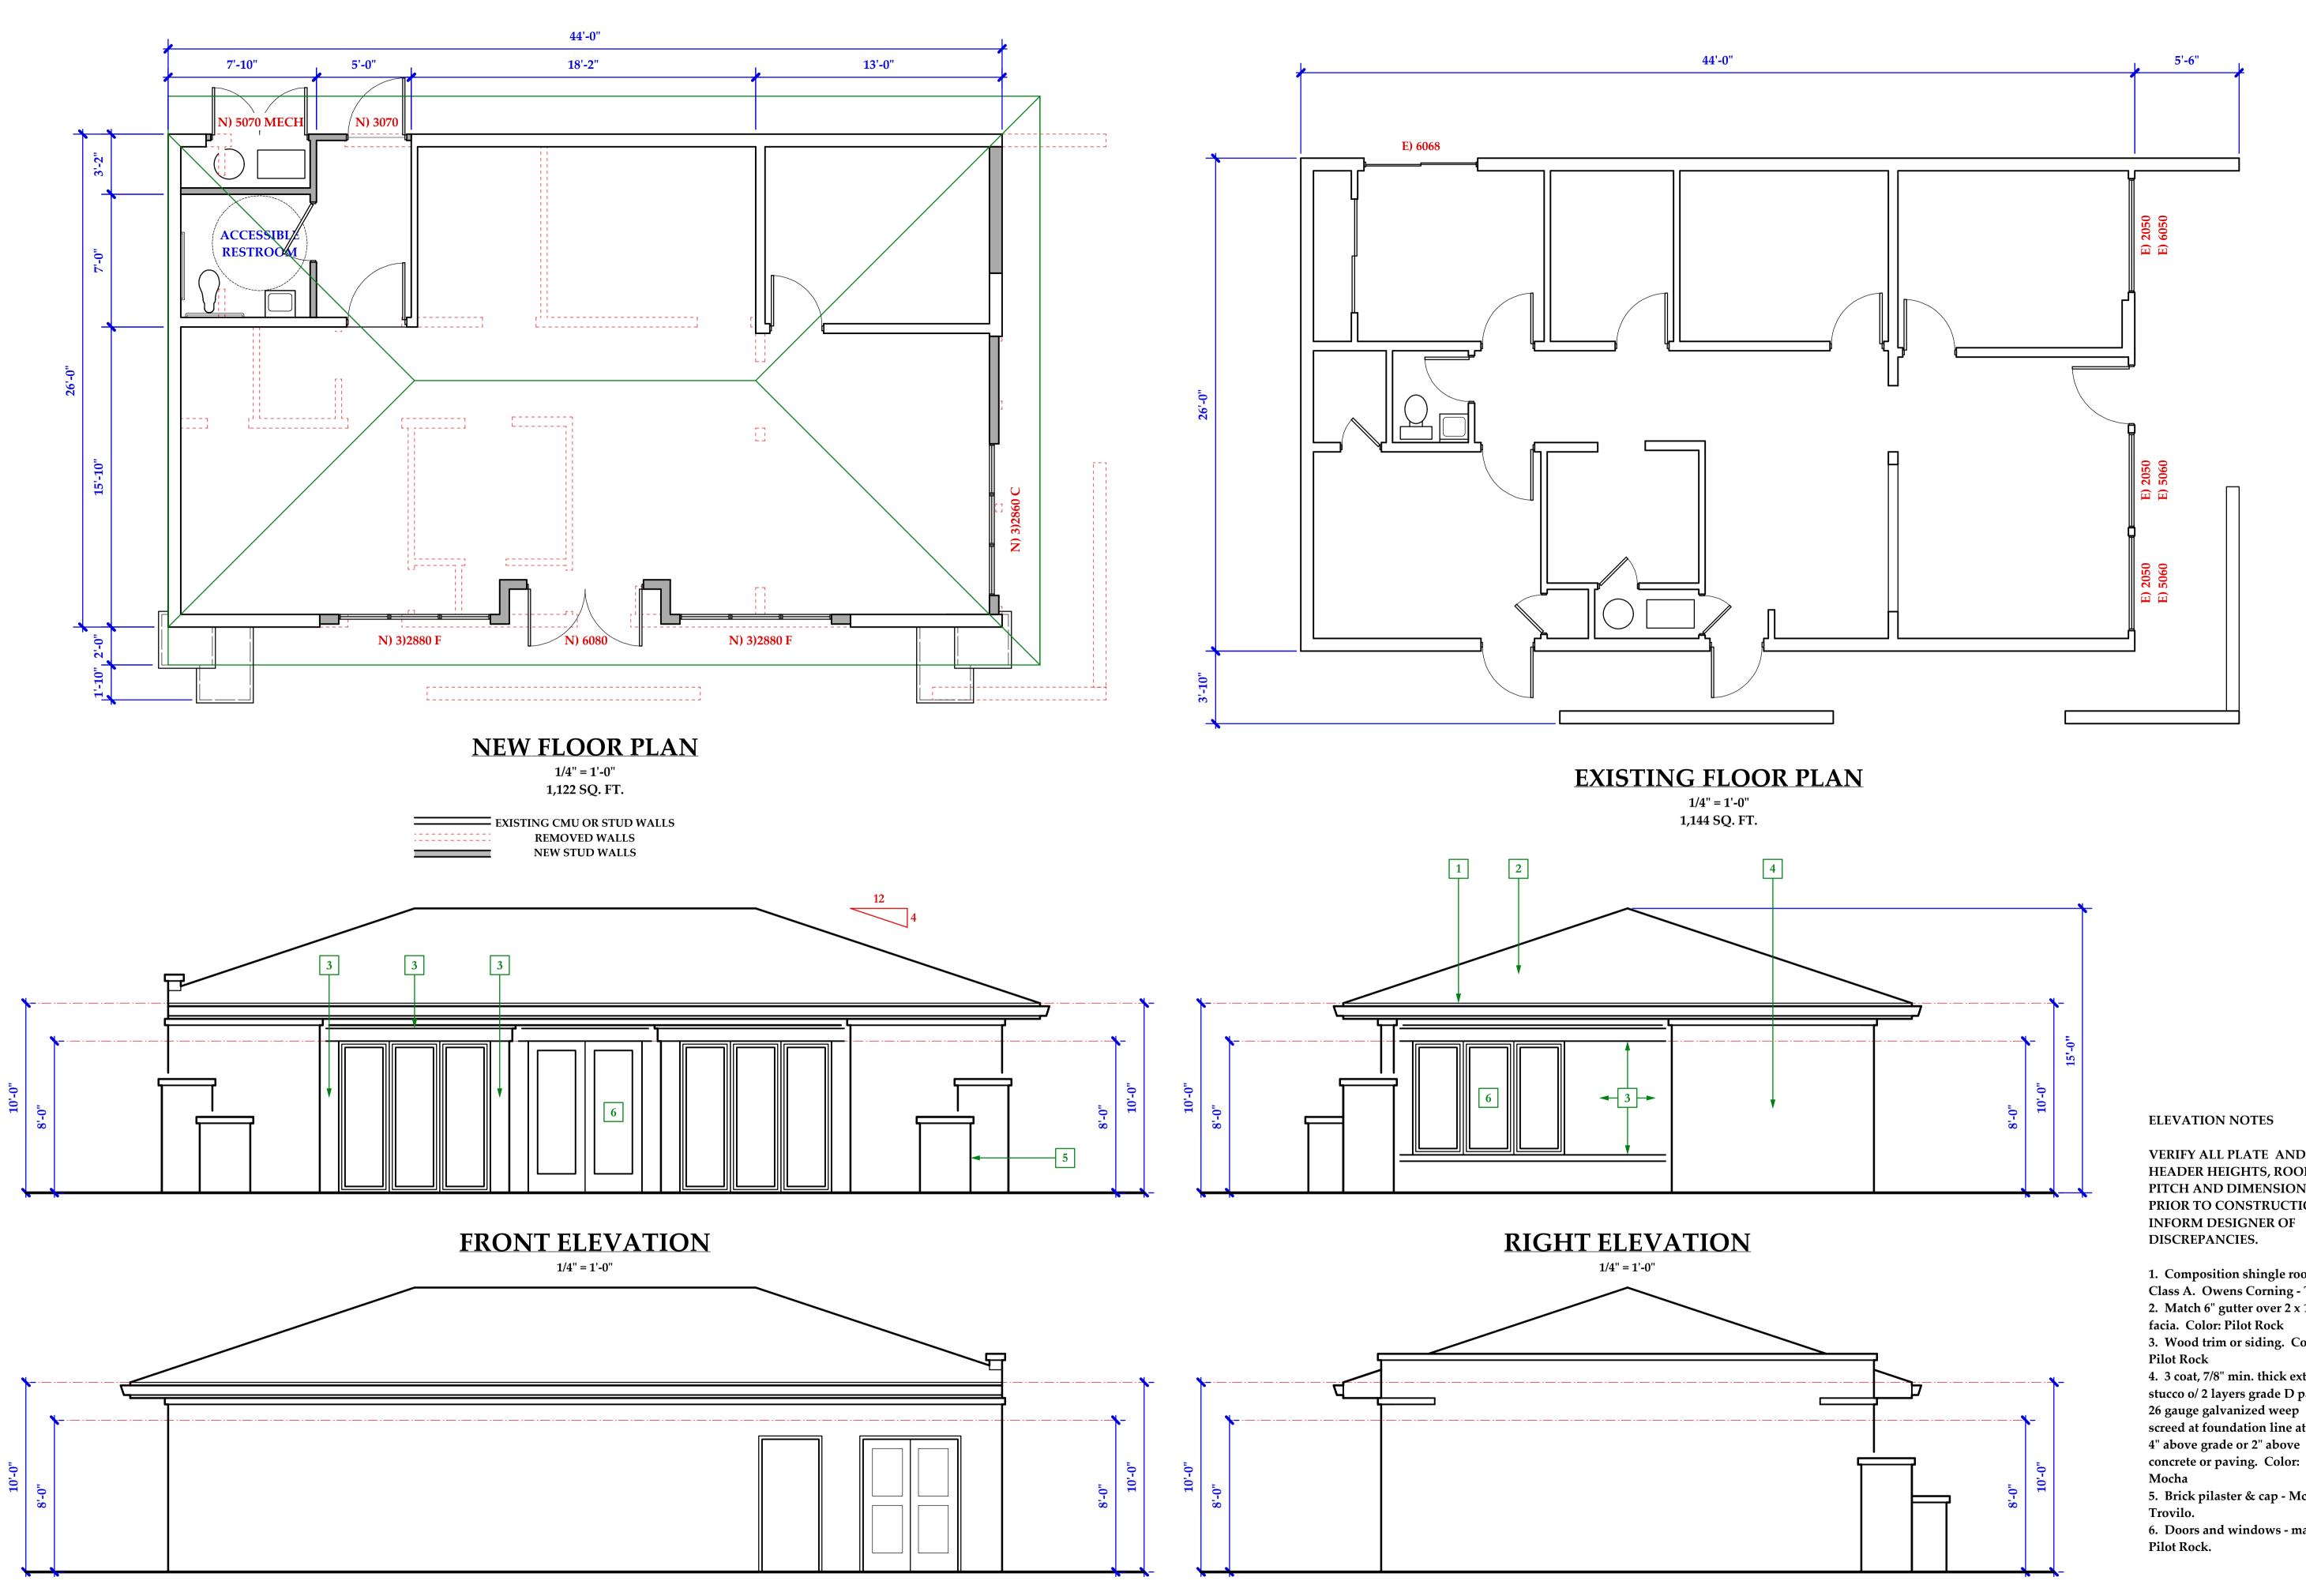

**REAR ELEVATION** 

1/4" = 1'-0"

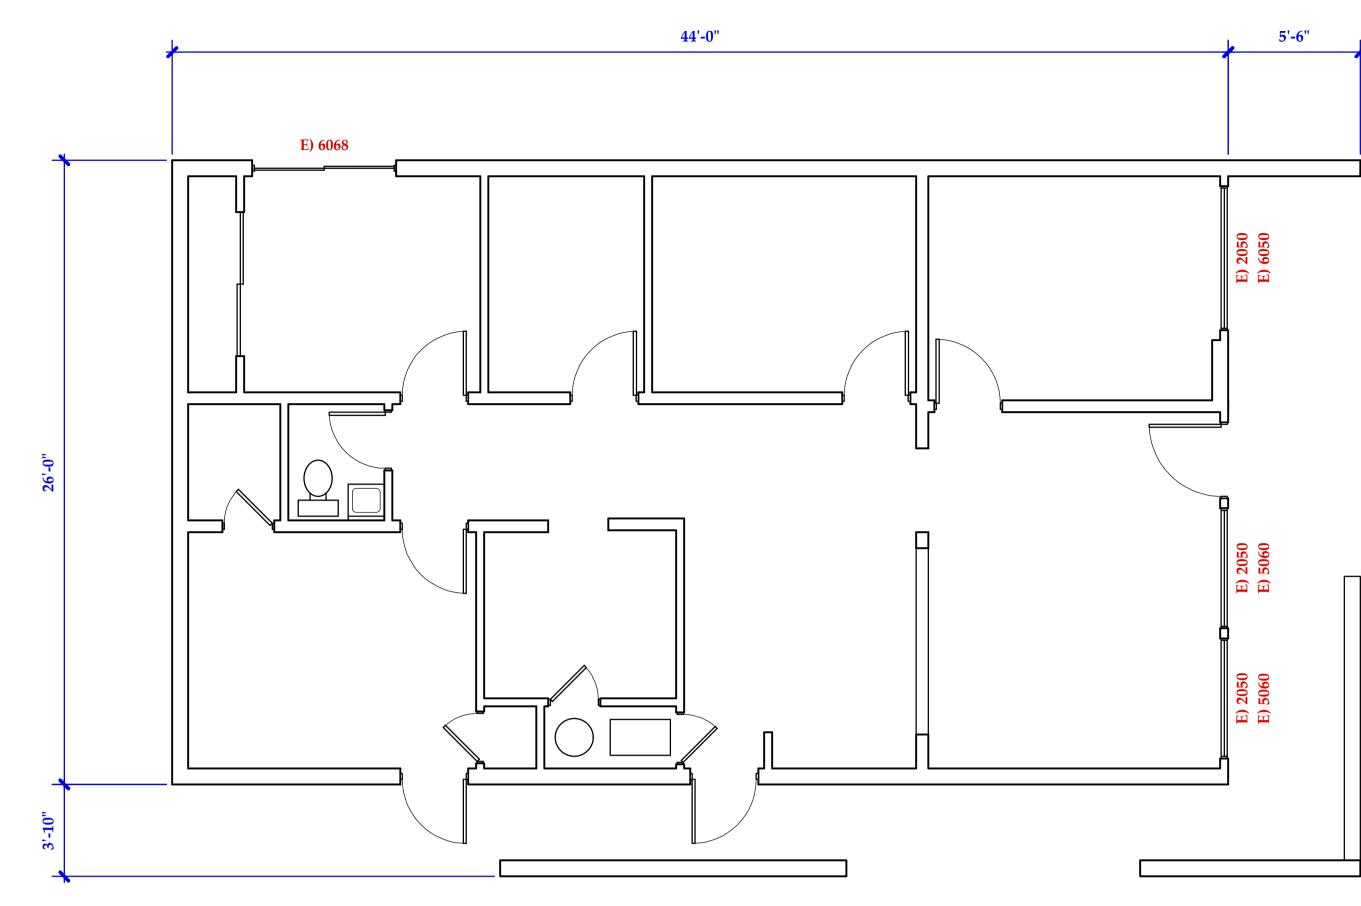

**LEFT ELEVATION** 1/4" = 1'-0"

### **ELEVATION NOTES**

VERIFY ALL PLATE AND HEADER HEIGHTS, ROOF PITCH AND DIMENSIONING PRIOR TO CONSTRUCTION. INFORM DESIGNER OF DISCREPANCIES.


1. Composition shingle roof, Class A. Owens Corning - Teak 2. Match 6" gutter over 2 x 10 facia. Color: Pilot Rock 3. Wood trim or siding. Color:


4. 3 coat, 7/8" min. thick exterior stucco o/ 2 layers grade D paper. 26 gauge galvanized weep screed at foundation line at least

concrete or paving. Color: 5. Brick pilaster & cap - McNear

6. Doors and windows - match

REVISIONS
DOUGLAS J. HARWOOD CLASSIC HOME DESIGN 2157 FOURTH STREET LIVERMORE, CA 94550 (925) 787-4993
These drawings were prepared by Douglas J. Harwood, Designer.
NEW & EXISTING PLANS ELEVATIONS
A TENANT IMPROVEMENT AND RESIDENCE FOR: TONY ADAMS 363 SAINT MARY STREET PLEASANTON, CALIFORNIA 94566
Date 4/30/15
Scale
Drawn DJH
Job 1403 Sheet

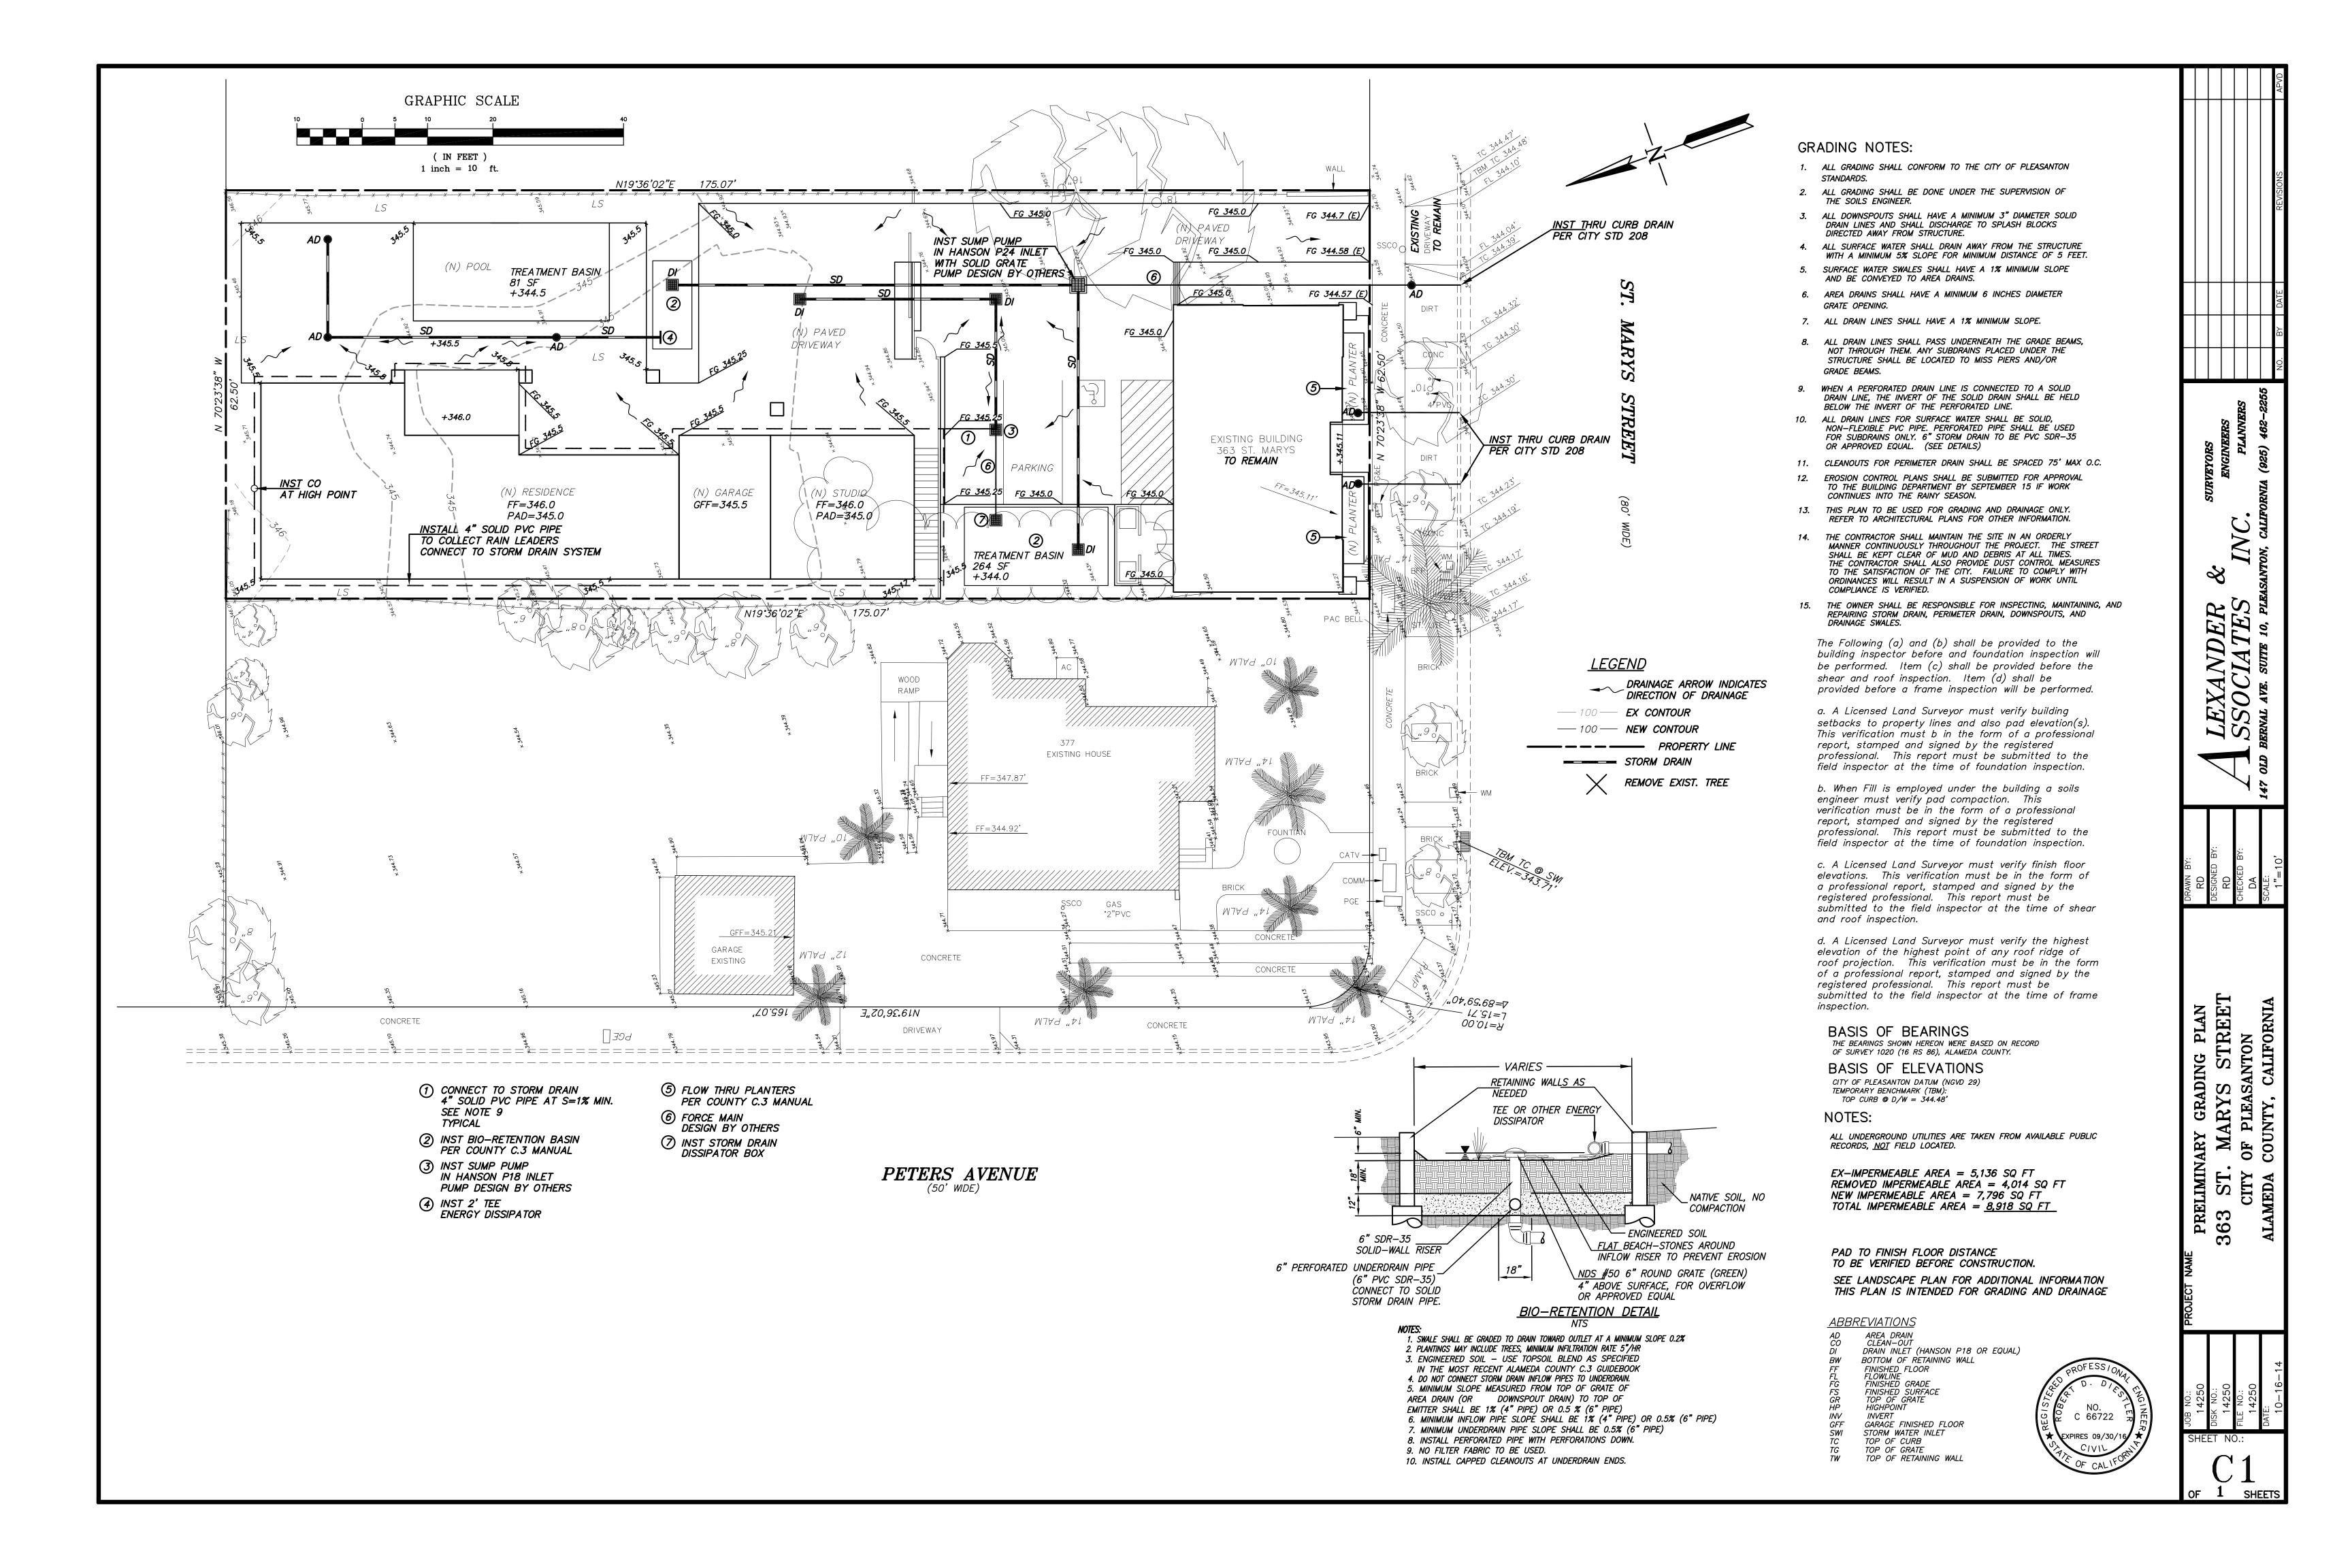

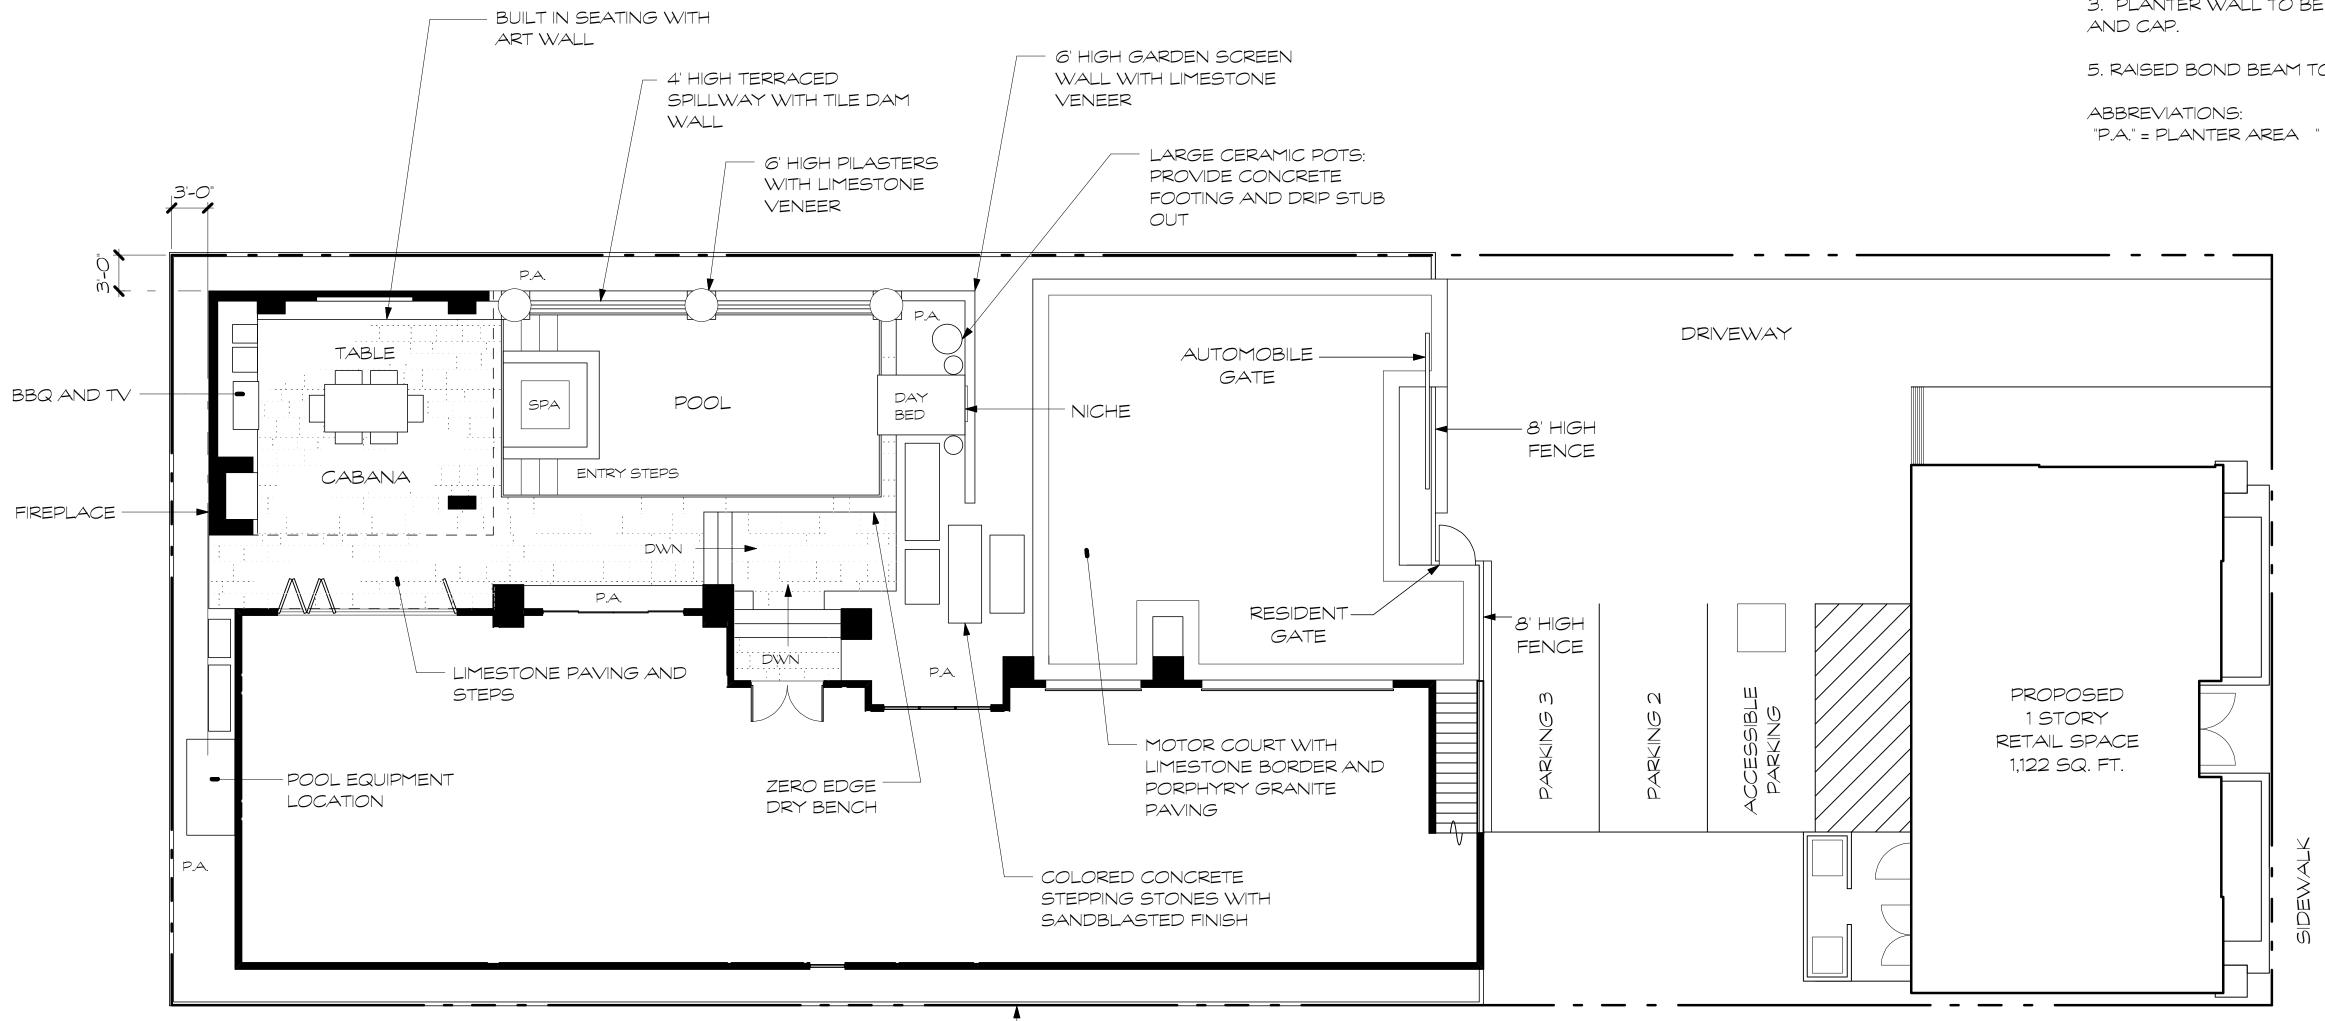

- 6' HIGH WOOD FENCING

PROPOSED HARDSCAPE PLAN <u>1/8" = 1'-0"</u>

# 'AUTUMN BEIGE'

COLORS:

1. CONCRETE :

BLOCKS FOR STEEL.

#### FINISHES:

2. STONE PAVING AT STOOPS AND STEPS TO BE LINEAR PATTERN (10", 16", AND 20" WIDE BY VARIOUS LENGTHS) TRAVERTINE PAVING SET ON 4" REINFORCED CONCRETE SUBPOUR. TRAVERTINE TO BE SURFACE TEXTURED (NOT POLISHED). CONFIRM SELECTION WITH OWNER. NOTE: GROUT COLOR TO MATCH STONE IN TONE. (NOT DARKER)

5. RAISED BOND BEAM TO HAVE TILE VENEER DAM WALL

THE LANDSCAPE CONTRACTOR SHALL INSPECT THE SITE AND BE FAMILIAR WITH ALL EXISTING SITE CONDITIONS PRIOR TO BIDDING THE JOB. CONTRACTOR SHALL NOT WILLFULLY PROCEED WITH CONSTRUCTION AS SHOWN WHEN IT IS OBVIOUS THAT OBSTRUCTIONS, UTILITIES, LANDSCAPE GRADE DIFFERENCES, OR LANDSCAPE AREA DISCREPANCIES OCCUR ON SITE THAT HAVE NOT BEEN REPRESENTED ON THE DESIGN. SUCH CONDITIONS SHALL IMMEDIATELY BE BROUGHT TO THE ATTENTION OF THE LANDSCAPE DESIGNER. THE CONTRACTOR SHALL ASSUME FULL RESPONSIBILITY FOR ALL NECESSARY REVISIONS DUE TO FAILURE TO GIVE SUCH NOTIFICATION.


# HARDSCAPE NOTES:

ALL CONCRETE TO HAVE #3 REBAR AT 18" ON CENTER BOTH WAYS. 4" COMPACTED GRAVEL BASE. 4" THICK CONCRETE MINIMUM. USE DOBIE

COLORS USED ON STEPPING STONES TO BE L.M. SCOFIELD COLOR #0288

ALL CONCRETE TO HAVE LIGHT SANDBLASTED FINISH.

3. PLANTER WALL TO BE CONCRETE BLOCK OR GUNITE TRAVERTINE VENEER

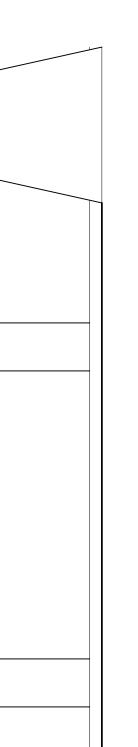

m


M

GENERAL NOTES

CONTRACTORS MUST BE PROPERLY AND CURRENTLY LICENSED BY THE CALIFORNIA CONTRACTORS STATE LICENSED BOARD PRIOR TO ENTERING INTO AN AGREEMENT TO PERFORM WORK AND MAY PERFORM ONLY SUCH WORK AS IS WITHIN THE SCOPE OF SAID LICENSED SPECIALTY.

CONTRACTOR SHALL BE RESPONSIBLE FOR BEING FAMILIAR WITH ALL UNDERGROUND UTILITIES, PIPES AND STRUCTURES. CONTRACTOR SHALL TAKE SOLE RESPONSIBILITY FOR COST INCURRED DUE TO DAMAGE AND REPLACEMENT OF SAID UTILITIES PRIOR TO COMMENCEMENT OF ANY CONSTRUCTION CONTRACTOR SHALL NOTIFY USA UNDERGROUND ALERT @ (800) 277-2600.



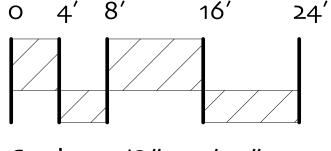

Scale: 1/8'' = 1'-0''

SHEET INDEX:

L-1 HARDSCAPE LAYOUT

L-2 PLANTING PLAN

L-3 PLANTING NOTES

# Martin Hoffmann 4713 First Street


Suite 205 Pleasanton. Ca 94566 925 462 2190 fax 925 462 2199

# residence of Tony Adams

363 Saint Mary Street Pleasanton, Ca.

#### NOTE: This plan is diagrammatic in nature. It is meant as a general guide to construction only. It is not fully detailed nor exhaustively specified. It is the responsibility of the contractor to become familiar with the site prior to starting work. Notify landscape designer promptly with any field discrepancies. It is the responsibility of the contractor and/ or owner to verify, select, and resolve all structures, water features, and planting materials. The contractor and owner are soley responsible for quality control,

construction standards and for maintaining compliance with local and county codes on this project.

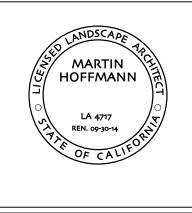

REV. NO. REVISION


HARDSCAPE LAYOUT

Date:

Scale: 1/8" = 1'-0"

Job No: Drawn: mfh

L-1

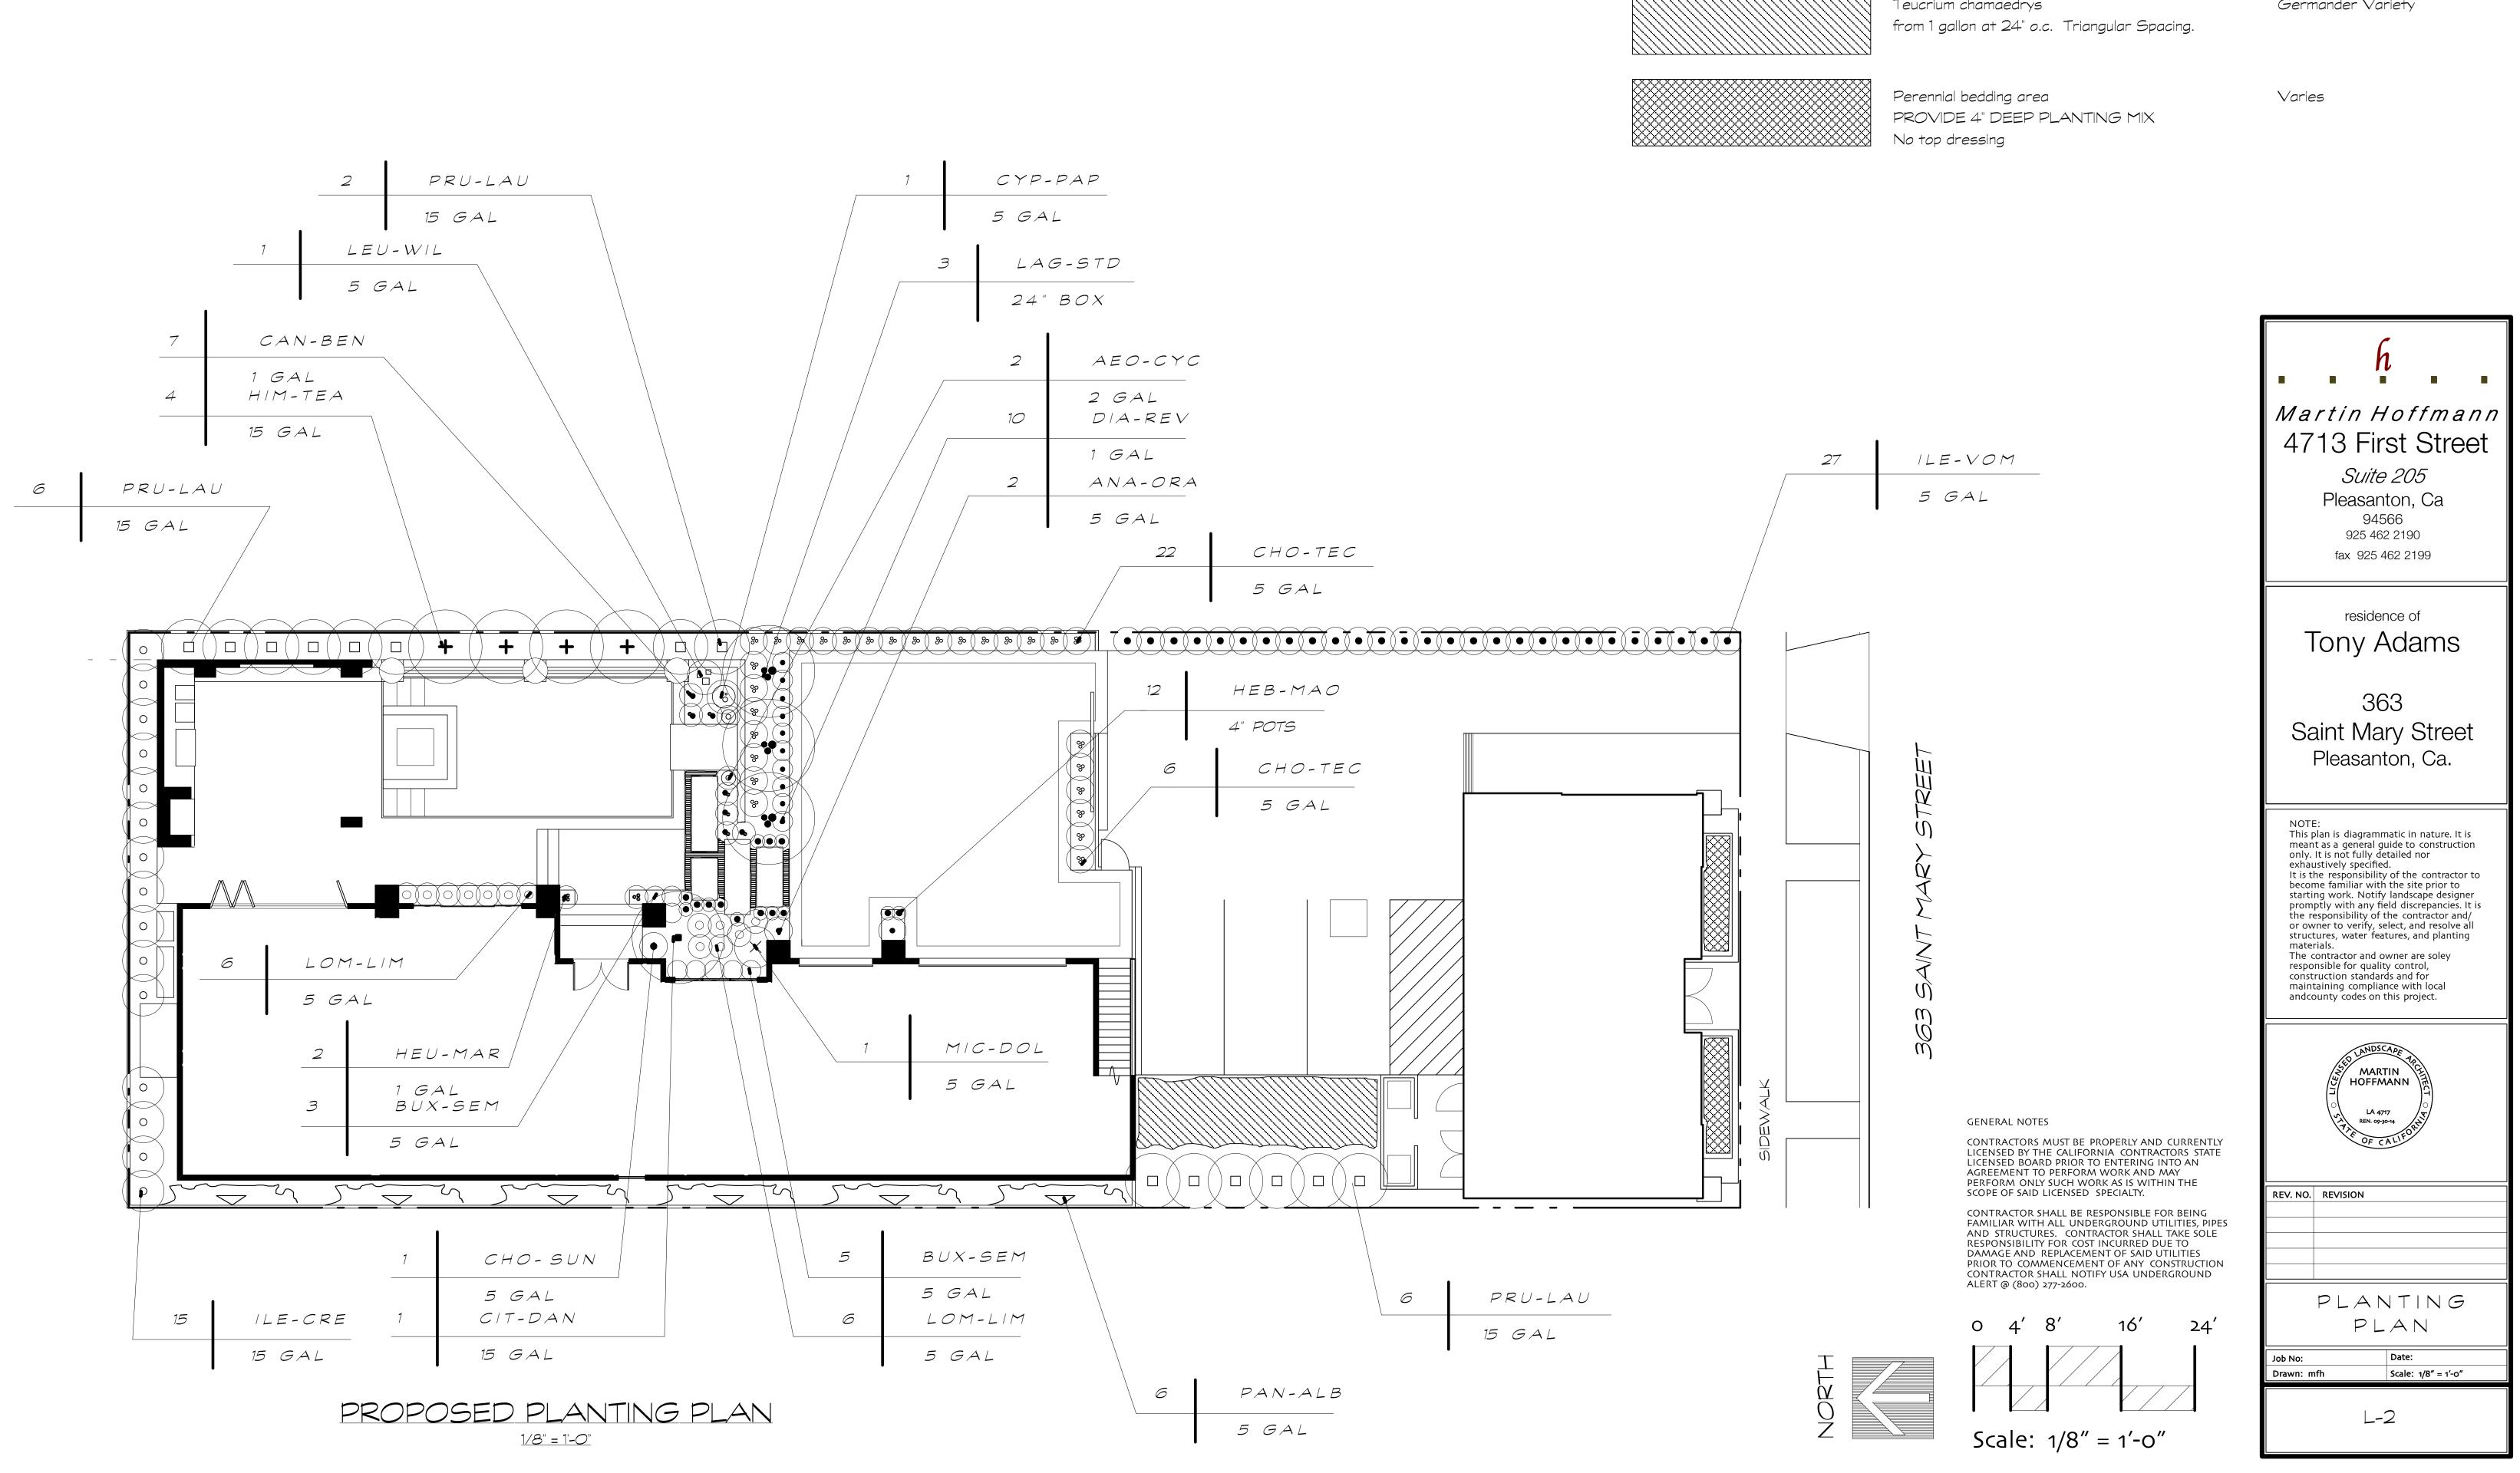






Sedum spurium 'John Creech' from 4" pots at 24" o.c. Triangular Spacing.


Teucrium chamaedrys

Stonecrop

Germander Variety

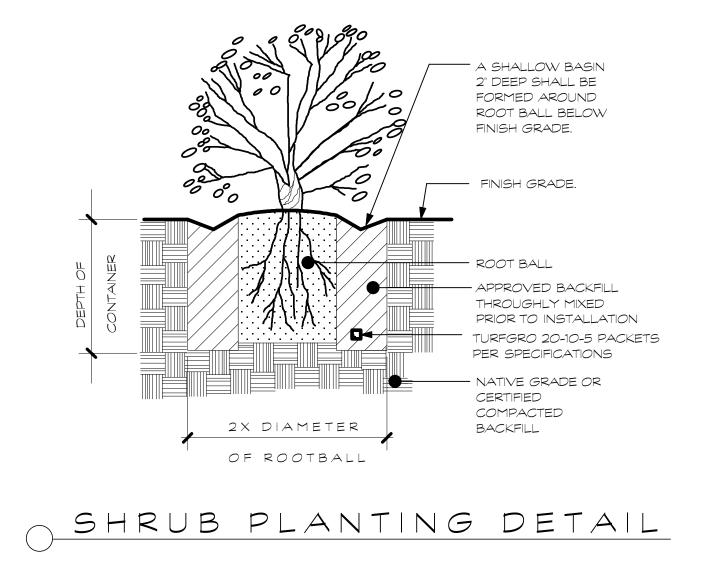

# STANDARD TRUNK TREE PLANTING

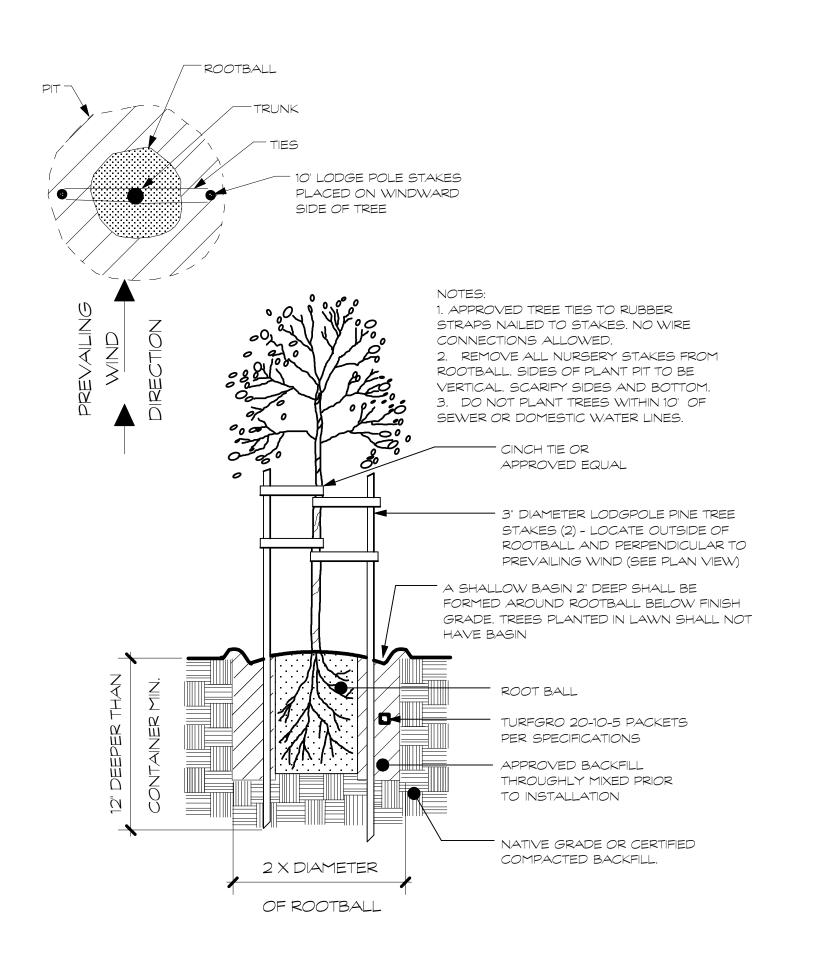

# PLANTING NOTES:

#### GENERAL NOTATION:

THE LANDSCAPE CONTRACTOR SHALL INSPECT THE SITE AND BE FAMILIAR WITH ALL EXISTING SITE CONDITIONS PRIOR TO BIDDING THE JOB. CONTRACTOR SHALL NOT WILLFULLY PROCEED WITH CONSTRUCTION AS SHOWN WHEN IT IS OBVIOUS THAT OBSTRUCTIONS, UTILITIES, LANDSCAPE GRADE DIFFERENCES, OR LANDSCAPE AREA DISCREPENCIES OCCUR ON SITE THAT HAVE NOT BEEN REPRESENTED ON THE DESIGN. SUCH CONDITIONS SHALL IMMEDIATELY BE BROUGHT TO THE ATTENTION OF THE LANDSCAPE DESIGNER. THE CONTRACTOR SHALL ASSUME FULL RESPONSIBILITY FOR ALL NECESSARY REVISIONS DUE TO FAILURE TO GIVE SUCH NOTIFICATION. ALL LOCAL CODES AND ORDINANCES SHALL BE OBSERVED. PLANTING SHALL BE INSTALLED IN CONFORMANCE WITH ALL APPLICABLE LOCAL CODES AND ORDINANCES BY EXPERIENCED WORKMEN AND A LICENSED LANDSCAPE CONTRACTOR WHO SHALL OBTAIN ALL NECESSARY PERMITS AND PAY ALL REQUIRED FEES. CONTRACTOR SHALL BE RESPONSIBLE FOR COORDINATION BETWEEN TRADES AND SUBCONTRACTORS AS REQUIRED TO COMPLETE LANDSCAPE OPERATIONS. THE CONTRACTOR SHALL BE RESPONSIBLE FOR ANY DAMAGE TO EXISTING FACILITIES CAUSED BY OR DURING THE PERFORMANCE OF HIS/ HER WORK. ALL REPAIRS SHALL BE MADE AT NO COST TO THE OWNER.

#### SOIL PREPARATION:

THE LANDSCAPE CONTRACTOR SHALL BE RESPONSIBLE FOR FINISH GRADING AND ALL PLANTING AREA DRAINAGE. POSITIVE DRAINAGE AWAY FROM HOUSE (2% MIN.) SHALL BE MAINTAINED. NO LOW SPOTS WHICH HOLD STANDING WATER WILL BE ACCEPTED. THE LANDSCAPE CONTRACTOR SHALL INCORPORATE BACKFILL SOIL MIXES IN PLANTING AREAS AS NOTED BELOW. WHERE ROTOTILLING IS NOT POSSIBLE, WORK IN AMENDMENT WITH HAND TOOLS. AFTER INSTALLATION OF IRRIGATION SYSTEM, ALL PLANTING AREAS ARE TO BE FINE GRADED TO WITHIN 2 INCHES AND SLIGHTLY MOUNDED AWAY FROM EDGES OF TOP OF HEADER, CURB, WALK, PLANTER, ETC... AND RAKED SMOOTH WITH ALL ROCK AND DEBRIS OVER 1 INCH IN DIAMETER REMOVED.

#### SOIL AMENDMENTS:

THE LANDSCAPE CONTRACTOR SHALL INCORPORATE, BY MEANS OF ROTOTILLING, 6 CUBIC YARDS OF 'NITROFIED' SOIL CONDITIONER (WITH A PH OF 6.5 TO 7.5) AND 15 LBS. OF GRANULAR FERTILIZER (12-12-12) PER 1,000 SQUARE FEET OF PLANTING AREA INTO THE TOP 6" OF SOIL FOR ALL PLANTING AREAS EXCEPT AS NOTED BELOW:

### PERENNIAL BEDDING AREAS:

PERENNIAL BEDS SHALL BE EXCAVATED AND 6" (OR DEPTH NOTED) OF PURE PLANTING MIX (SUCH AS DIABLO SOIL'S 'DIABLO MIX') SHALL BE USED. NO TOP DRESSING SHALL BE UTILIZED FOR CULTIVATED BEDS.

#### BACKFILL SOIL MIXES:

PLANTING PIT MIX FOR TREES AND SHRUBS TO CONSIST OF 1/3 ORGANIC AMENDMENT AND 2/3 AMENDED TOPSOIL AS NOTED ABOVE.

#### ACID BACKFILL MIX:

BACK FILL FOR ACID LOVING PLANTS (FOR ALL CITRUS ) SHALL BE 30% AMENDED SOIL, 20% SAND, AND 50% PRE-MOISTENED PEAT WITH '49'ER BRAND ACID FOOD' AT MANUFACTURER'S RECOMMENDED APPLICATION RATE. PLANTING PITS TO BE MINIMUM 2 TIMES WIDTH OF ROOTBALL AND 2 TIMES DEPTH OF ROOTBALL

#### SHRUB PLANTING

THE SHRUBS SHALL BE SPOTTED AS PER PLAN. NO SUBSTITUTIONS UNLESS AUTHORIZED BY LANDSCAPE DESIGNER OR OWNER. ALL SHRUBS SHALL RECIEVE TURFGRO 20-10-5 PACKETS AT THE FOLLOWING RATIOS: (1) TABLET PER 1 GALLON, (2) TABLETS FOR 5 GALLON, AND (4) TABLETS FOR 15 GALLON.

### TREE PLANTING:

THE TREES SHALL BE SPOTTED AS PER PLAN. TREES SHALL TYPICALLY BE LOCATED A MINIMUM OF FOUR (4') FEET FROM ALL CURBS, WALKS, HEADERS. BUILDINGS, OR OVERHANGS, AND OTHER TREES WITHIN THE PROJECT. TREE BACKFILL SHALL BE THE 'PIT PLANTING MIX' AS NOTED ABOVE. STD. TRUNK INDICATES A SINGLE TRUNK. AND A MULTI TRUNK INDICATES (3) TRUNKS FROM THE BASE OF TREE. DOUBLE STAKE ALL STANDARD TRUNK TREES. ALL TREES SHALL RECIEVE TURFGRO 20-10-5 PACKETS AT THE FOLLOWING RATIOS: (4) TABLET PER 15 GALLON, (5) TABLETS FOR 24" BOX, AND (6) TABLETS FOR 36" BOX AND LARGER. THOROUGHLY WATER ALL TREES IMMEDIATELY FOLLOWING PLANTING.

#### TOP DRESSING:

TOP DRESSING TO CONSIST OF 2" LAYER MEDIUM FIR BARK CHIPS FOR ALL PLANTING AREAS EXCEPT LAWN AND MEADOW GRASS. APPLY 'RONSTAR' PRE EMERGENT PRIOR TO TOP DRESS AT MANUFACTURER'S RECOMMENDED RATE.

#### MAINTANENCE:

THE CONTRACTOR SHALL MAINTAIN THE PROJECT FOR 90 DAYS ( OR AS APPROVED BY OWNER ) UPON COMPLETION AND APPROVAL OF THE PROJECT. DURING THE ENTIRE MAINTENANCE PERIOD, WATERING, CULTIVATING, WEEDING, REPAIR OF STAKES AND TIES, AND SPRAYING FOR INSECTS AND DISEASES SHALL BE PERFORMED. AT THE END OF MAINTENANCE PERIOD, ALL AREAS SHALL BE FREE OF WEEDS AND ALL PLANT MATERIAL SHALL BE IN A HEALTHY. THRIVING CONDITION.

### SUBSTITUTIONS:

REQUESTS FOR SUBSTITUTIONS OF PLANT MATERIAL TO BE MADE (5) DAYS PRIOR TO PLANTING.

#### GUARANTEE:

ALL CONSTRUCTION, TREES, SHRUBS, AND IRRIGATION BY LANDSCAPE CONTRACTOR AND/OR HIS SUBCONTRACTORS SHALL BE GUARANTEED FOR ONE (1) FULL YEAR AFTER THE BEGINNING OF THE MAINTENANCE PERIOD. THE CONTRACTOR SHALL REPLACE ANY AND ALL LANDSCAPE MATERIALS THAT ARE IN AN UNACCEPTABLE CONDITION FOR THE TIME OF USE, AND ANY PLANT MATERIAL THAT ARE NOT IN A VIGOROUS STATE OF GROWTH. THE CONTRACTOR SHALL NOT BE HELD LIABLE FOR LOSS OF PLANT MATERIAL DUE TO VANDALISM, ACCIDENTAL CAUSES, OR ACTS OF NEGLECT BY OTHERS THAN THE CONTRACTOR, HIS AGENTS, OR EMPLOYEES.

# Planting Legend:

SYMBOL BOTANICAL NAME

TREES: MIC FIG Michelia figo

TRI LAU Tristania laurina 'Elegant' (standard trunk)

SUCCULENTS: AEO CYC Aeonium 'Cyclops'

#### BAMBOOS:

VINES:

HIM TEA Himalayacalamus hookerianus 'Teague's Blue'

PAN ALB Pandorea jasminoides 'Alba'

#### FRUIT TREES:

CIT DAN Citrus reticulata 'Dancy'

SPECIALTY	SHRUBS/TOPIARY:
BUX MON	Buxus sempervirens 'Monru
$ILE \vee OM$	llex vomitora 'Nana'
ILE CRE	llex crenata 'Sky Pencil'

#### SHRUBS:

BUX SEM	Buxus sempervirens 'Suffriuticosa'
CHO SUN	Choisya ternata 'Sundance'
POL VIR	Polygala virgata
PED BRA	Pedilanthus bracteatus
PRU LAU	Prunus laurocerasus

#### GRASSES AND GRASSLIKE:

ANA ORA	Anigozanthos 'Orange Cross'
CYP PAP	Cyperus papyrus 'Egyptian'
CHR TEC	Chrondropetalum tectorum
DIA REV	Dianella revoluta 'Baby Bliss'
LOM LIM	Lomandra 'Lime Tuff

#### PERENNIALS:

CAN BEN	Canna 'Bengal Tiger'
HEU MAR	Heuchera sanguinea 'Marmelade'
HEB MAO	Hebe 'Maori Gem'
*	

' available at Devil Mountain Wholesale phone (925) 829 6006

# GROUND COVERS:



Teucrium chamaedrys from 1 gallon at 24" o.c. Triangular Spacing.

Perennial bedding area No top dressing

COMMON NAME	wucols (water use rating)
Bananna shrub No Common Name	medium medium
no common name	low
Blue Bamboo	medium
Bower Vine	medium
Tangerine	medium
Green Tower Boxwood Dwarf Yaupon Holly Topiary Chinese Holly	medium medium medium
English Boxwood Mexican Orange Purple Broom Slipper Plant English Laurel	medium medium Iow medium
Kangaroo Paw Papyrus Grass Variety Baby Bliss Flax Lily Mat Rush	medium high medium medium medium
Canna Lily Variety Coral Bells Hebe	medium medium Iow

from 4" pots at 24" o.c. Triangular Spacing.

PROVIDE 4" DEEP PLANTING MIX

Stonecrop

Germander Variety

Varies

## Martin Hoffmann 4713 First Street

Suite 205 Pleasanton, Ca 94566 925 462 2190 fax 925 462 2199


# residence of Tony Adams

363 Saint Mary Street Pleasanton, Ca.

#### NOTE:

This plan is diagrammatic in nature. It is meant as a general guide to construction only. It is not fully detailed nor exhaustively specified. It is the responsibility of the contractor to become familiar with the site prior to starting work. Notify landscape designer promptly with any field discrepancies. It is the responsibility of the contractor and/ or owner to verify, select, and resolve all structures, water features, and planting materials.

The contractor and owner are solev responsible for quality control, construction standards and for maintaining compliance with local and county codes on this project.

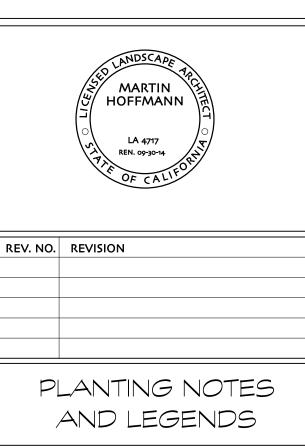

Job No: Drawn: mfh


L-3

Date:





**EAST ELEVATION** 1/4" = 1'-0"

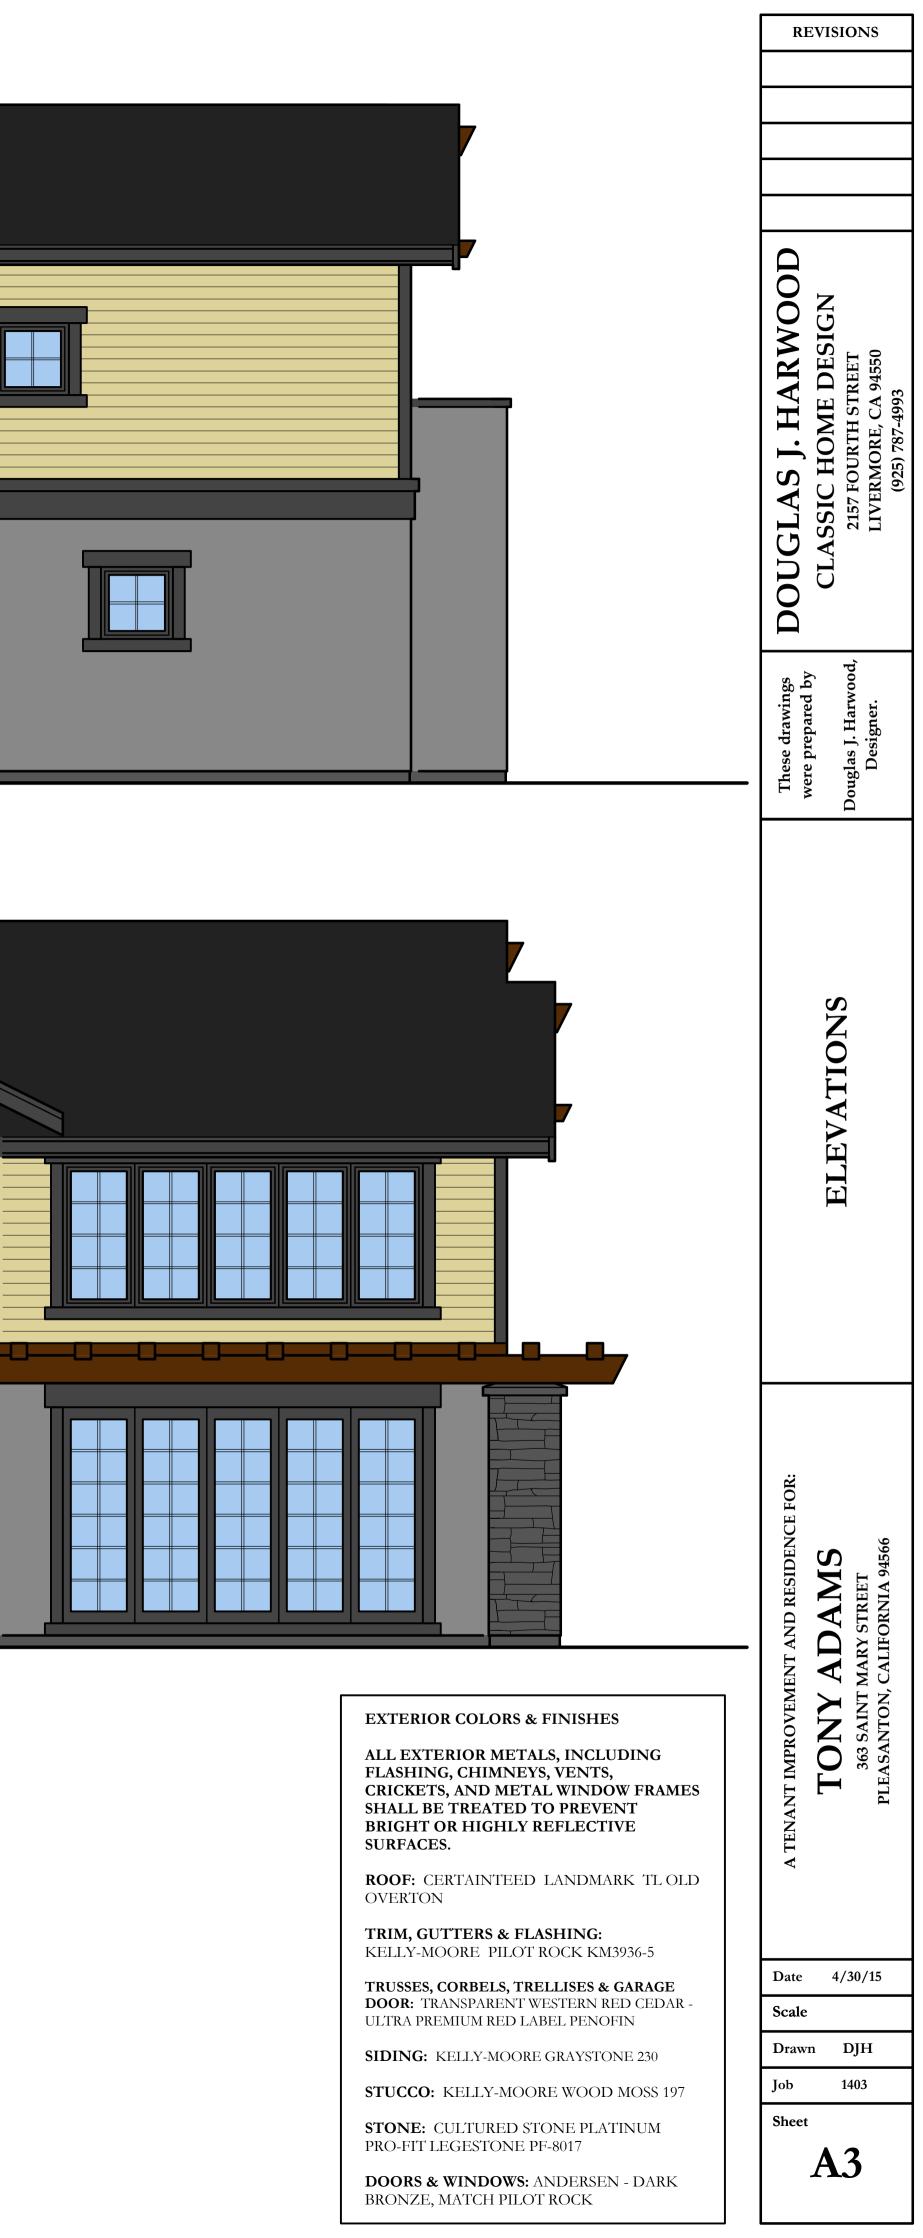



# **NORTH ELEVATION** 1/4" = 1'-0"



## **SOUTH ELEVATION** 1/4" = 1'-0"

#### **EXTERIOR COLORS & FINISHES**

ALL EXTERIOR METALS, INCLUDING FLASHING, CHIMNEYS, VENTS, CRICKETS, AND METAL WINDOW FRAMES SHALL BE TREATED TO PREVENT BRIGHT OR HIGHLY REFLECTIVE SURFACES.

ROOF: CERTAINTEED LANDMARK TL OLD OVERTON

TRIM, GUTTERS & FLASHING: KELLY-MOORE PILOT ROCK KM3936-5

TRUSSES, CORBELS, TRELLISES & GARAGE DOOR: TRANSPARENT WESTERN RED CEDAR -ULTRA PREMIUM RED LABEL PENOFIN

SIDING: KELLY-MOORE GRAYSTONE 230

STUCCO: KELLY-MOORE WOOD MOSS 197

**STONE:** CULTURED STONE PLATINUM PRO-FIT LEGESTONE PF-8017

DOORS & WINDOWS: ANDERSEN - DARK BRONZE, MATCH PILOT ROCK

	,	
7		

DOUGLAS J. HARWOOD CLASSIC HOME DESIGN 2157 FOURTH STREET LIVERMORE, CA 94550 (925) 787-4993
These drawings were prepared by Douglas J. Harwood, Designer.
ELEVATIONS
A TENANT IMPROVEMENT AND RESIDENCE FOR: TONY ADAMS 363 SAINT MARY STREET PLEASANTON, CALIFORNIA 94566
Date 4/30/15
Scale
Drawn DJH
Job 1403 Sheet