

Existing residence



New apartments


View looking Northwest

Harrison Street Apartments

4722 Harrison Street


Pleasanton, California

Vicinity Map

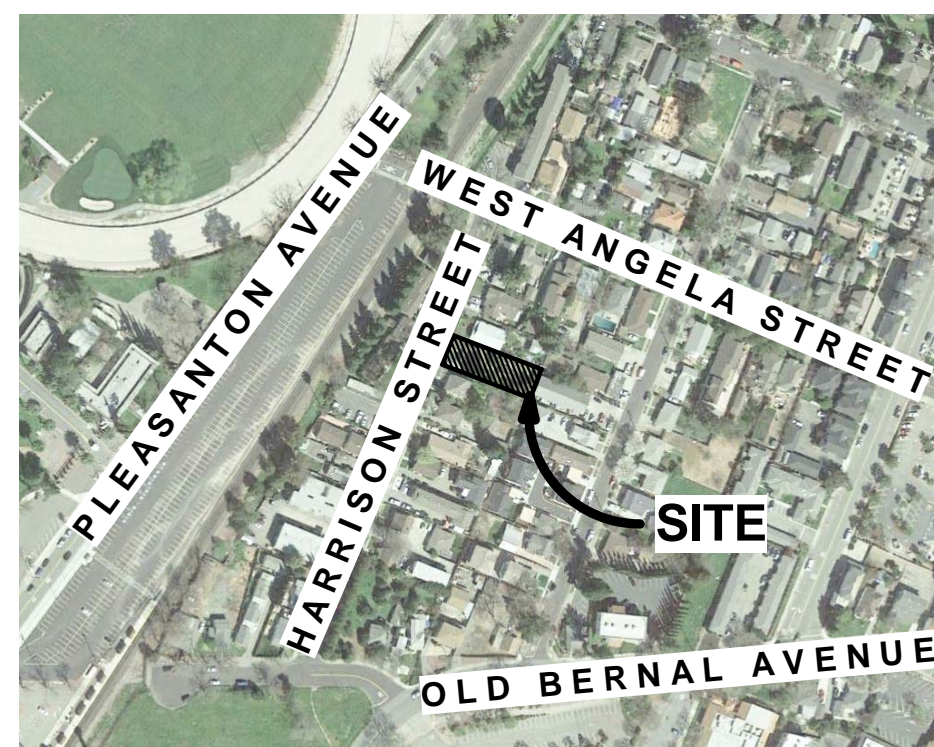

**JOHNSON
LYMAN
ARCHITECTS**

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PHONE: 925.930.9690 FAX: 925.930.9039
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Project Summary

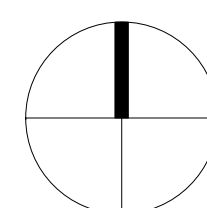Site Area:	7,509 SF +/-	Parking Provided:	5 stalls
Site Coverage:	35%		
Floor Area Ratio (Excluding Garage):	45.9%		
APN:	94-155-20		
Existing Building Area:			
Residence:	1,042 SF +/-		
Garage:	400 SF +/-		
Proposed Building Area:			
Residence:	1,042 SF +/- (Existing)		
Garages:	440 SF		
Unit 1			
First Floor:	576 SF		
Second Floor:	644 SF		
Unit 2			
First Floor:	576 SF		
Second Floor:	608 SF		
Total	3,886 SF		

Project Team

Owner

Dennis Winslow &
Bonnie Waters
286 Rickenbacker Circle
Livermore, CA 94551

Civil Engineer

Humann Company, Inc.
1021 Brown Avenue
Lafayette, CA 94549
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Architect

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1375 Locust Street Suite 202
Walnut Creek, CA 94596
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Landscape Architect

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Sheet Index

A0	Cover Sheet	CB	Color and Materials
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A4.1	Elevations		
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A0

4-9-18




View looking Northeast


Fence not shown for clarity




View looking Southeast

Fence not shown for clarity

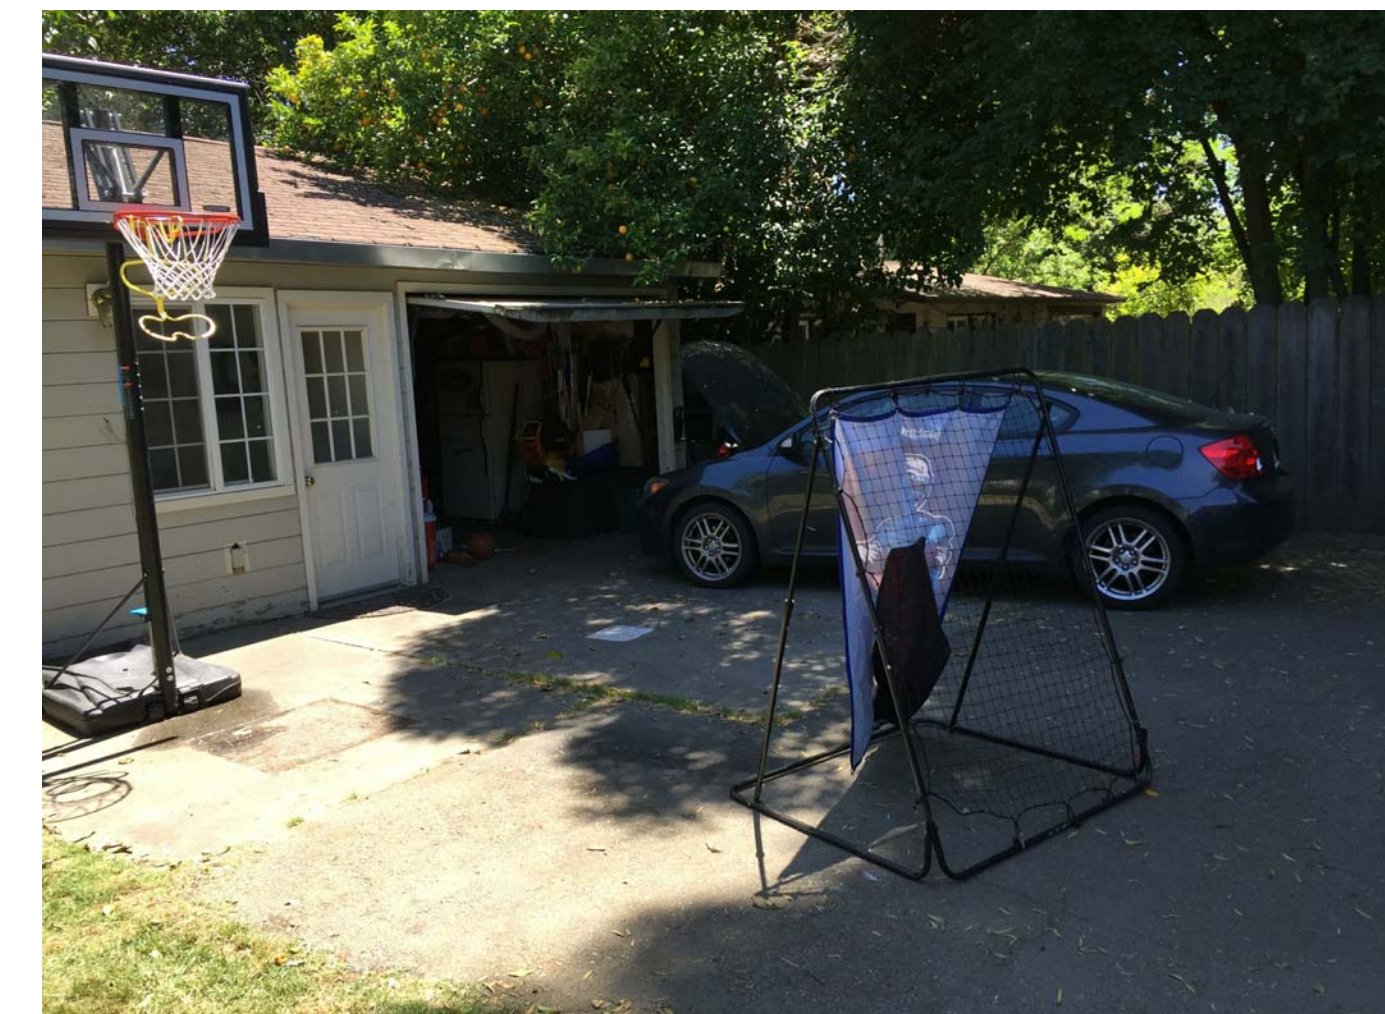


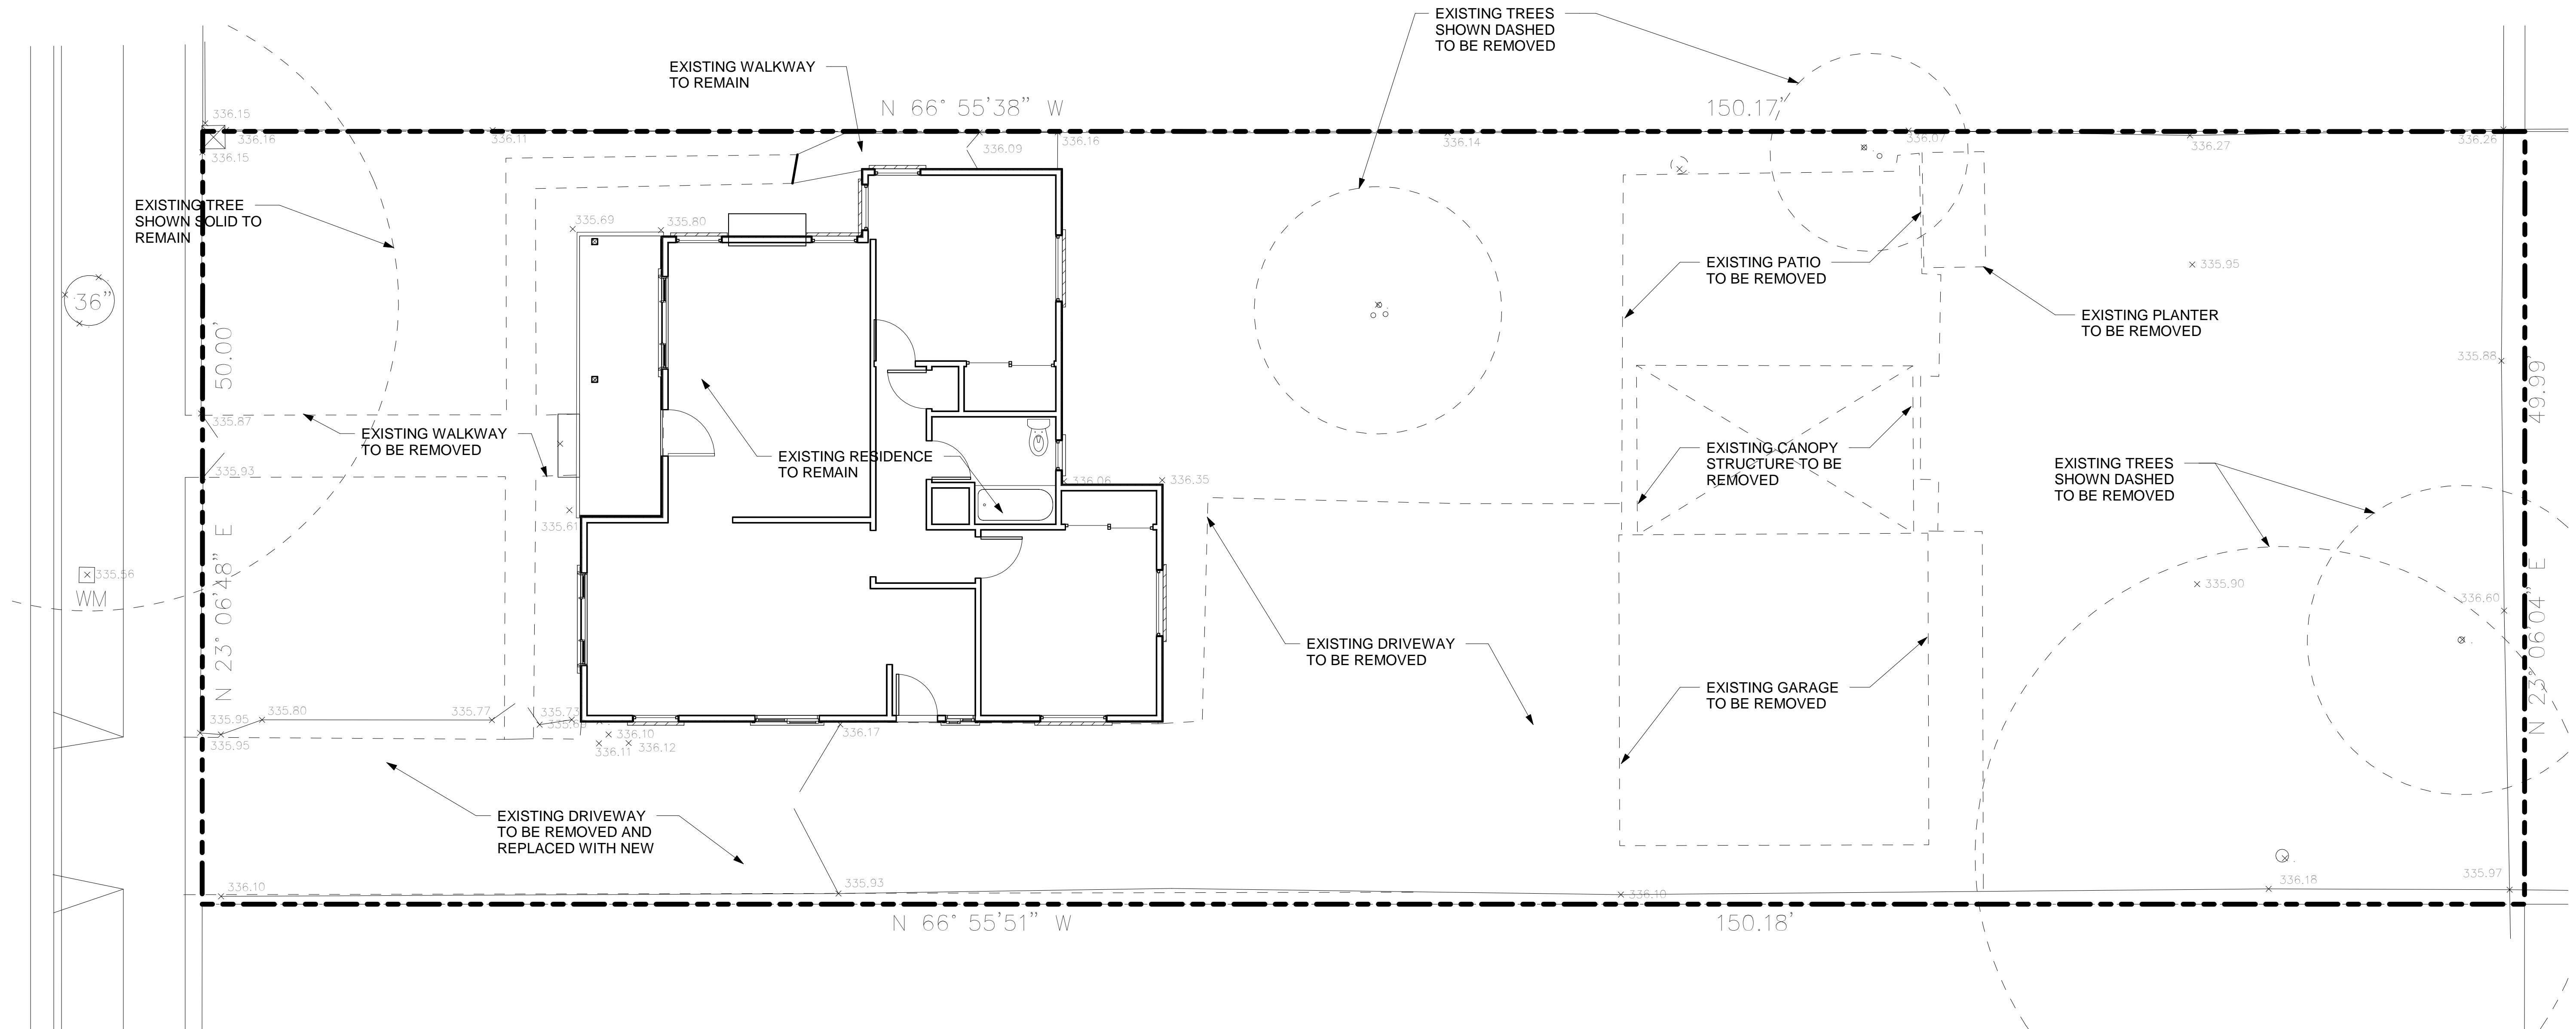


1 DEMO PLAN
3/16" = 1'-0"

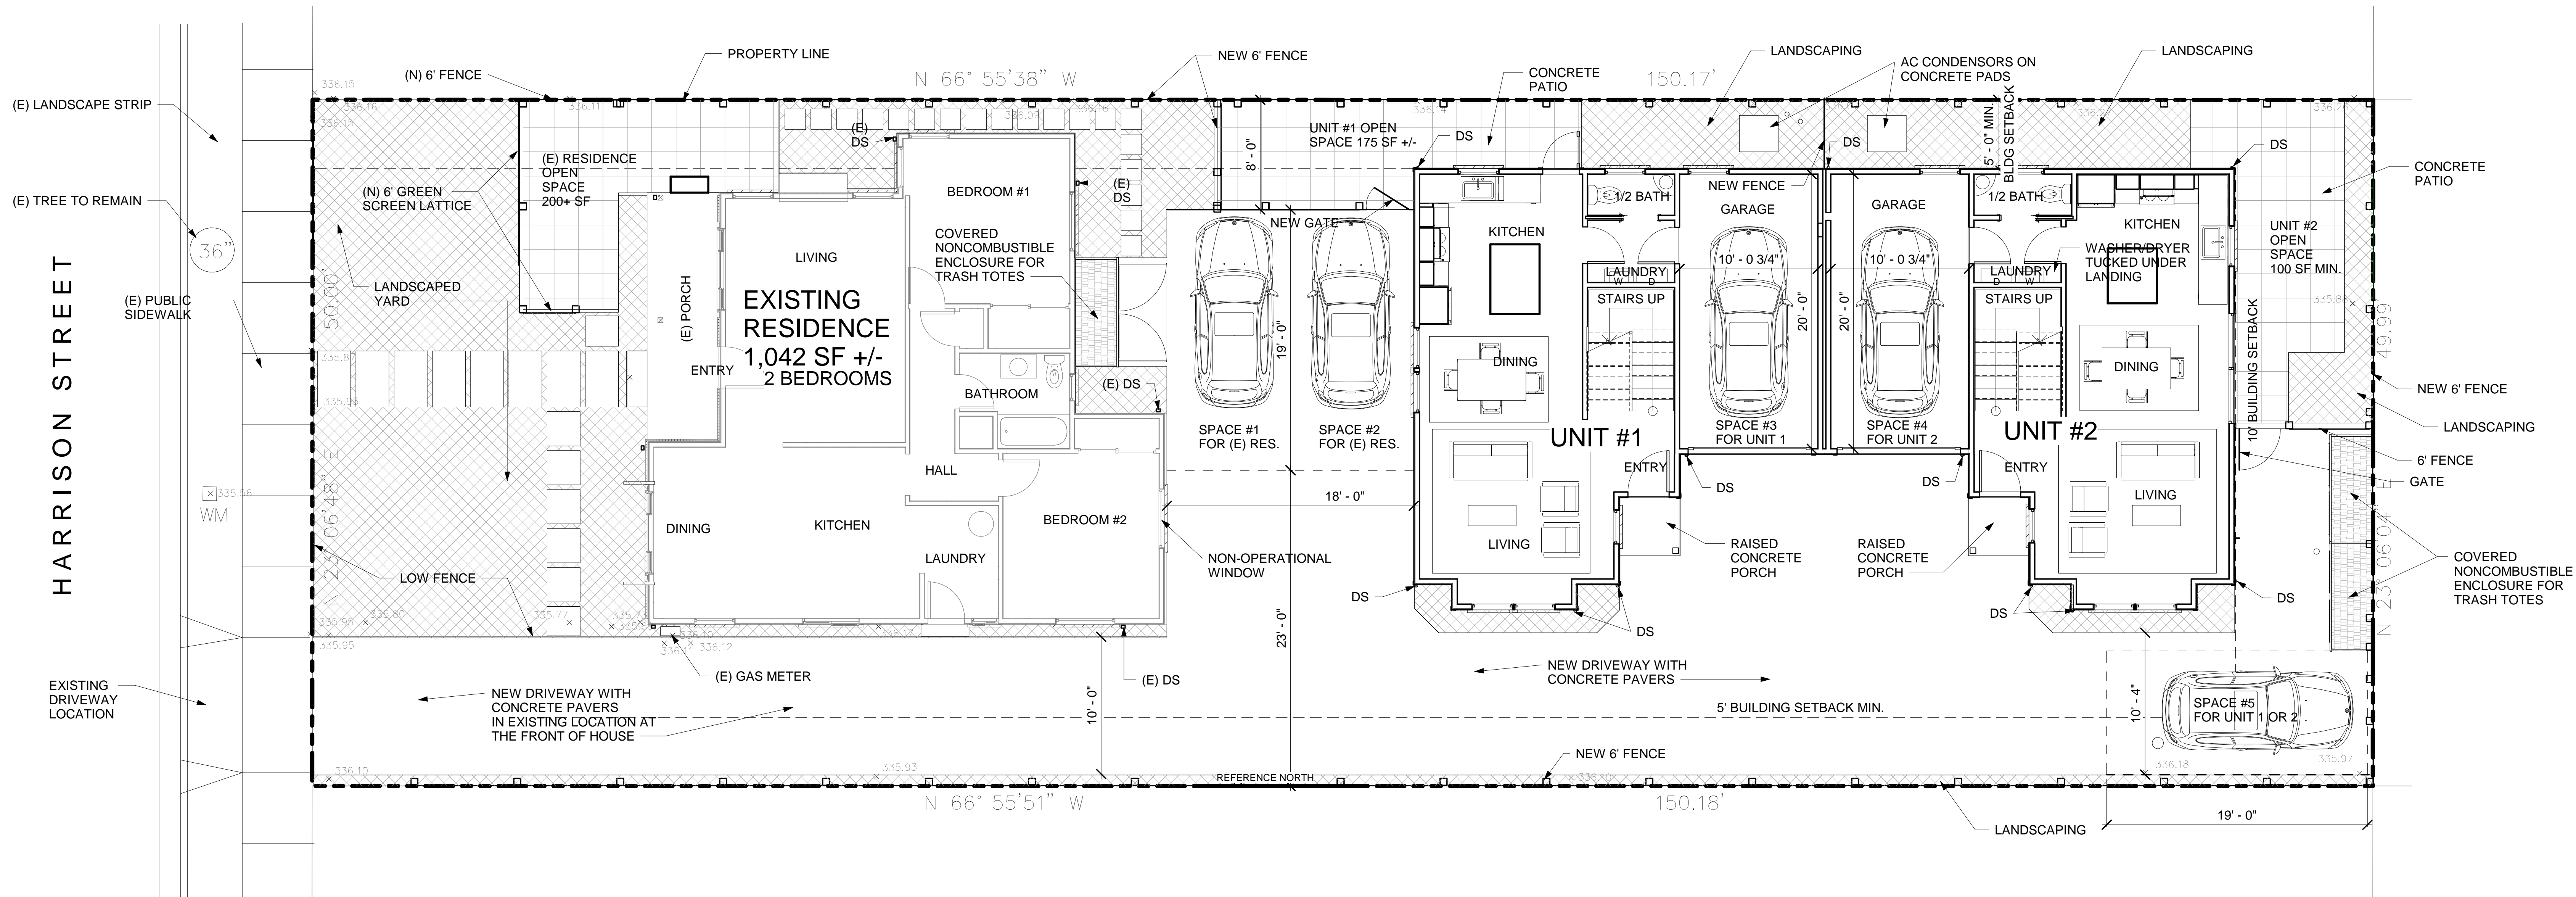


1 1ST FLOOR PLAN
3/16" = 1'-0"

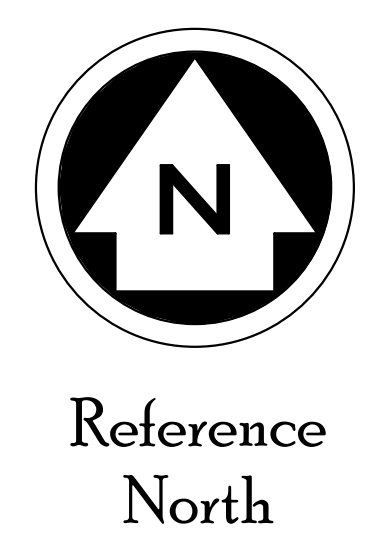

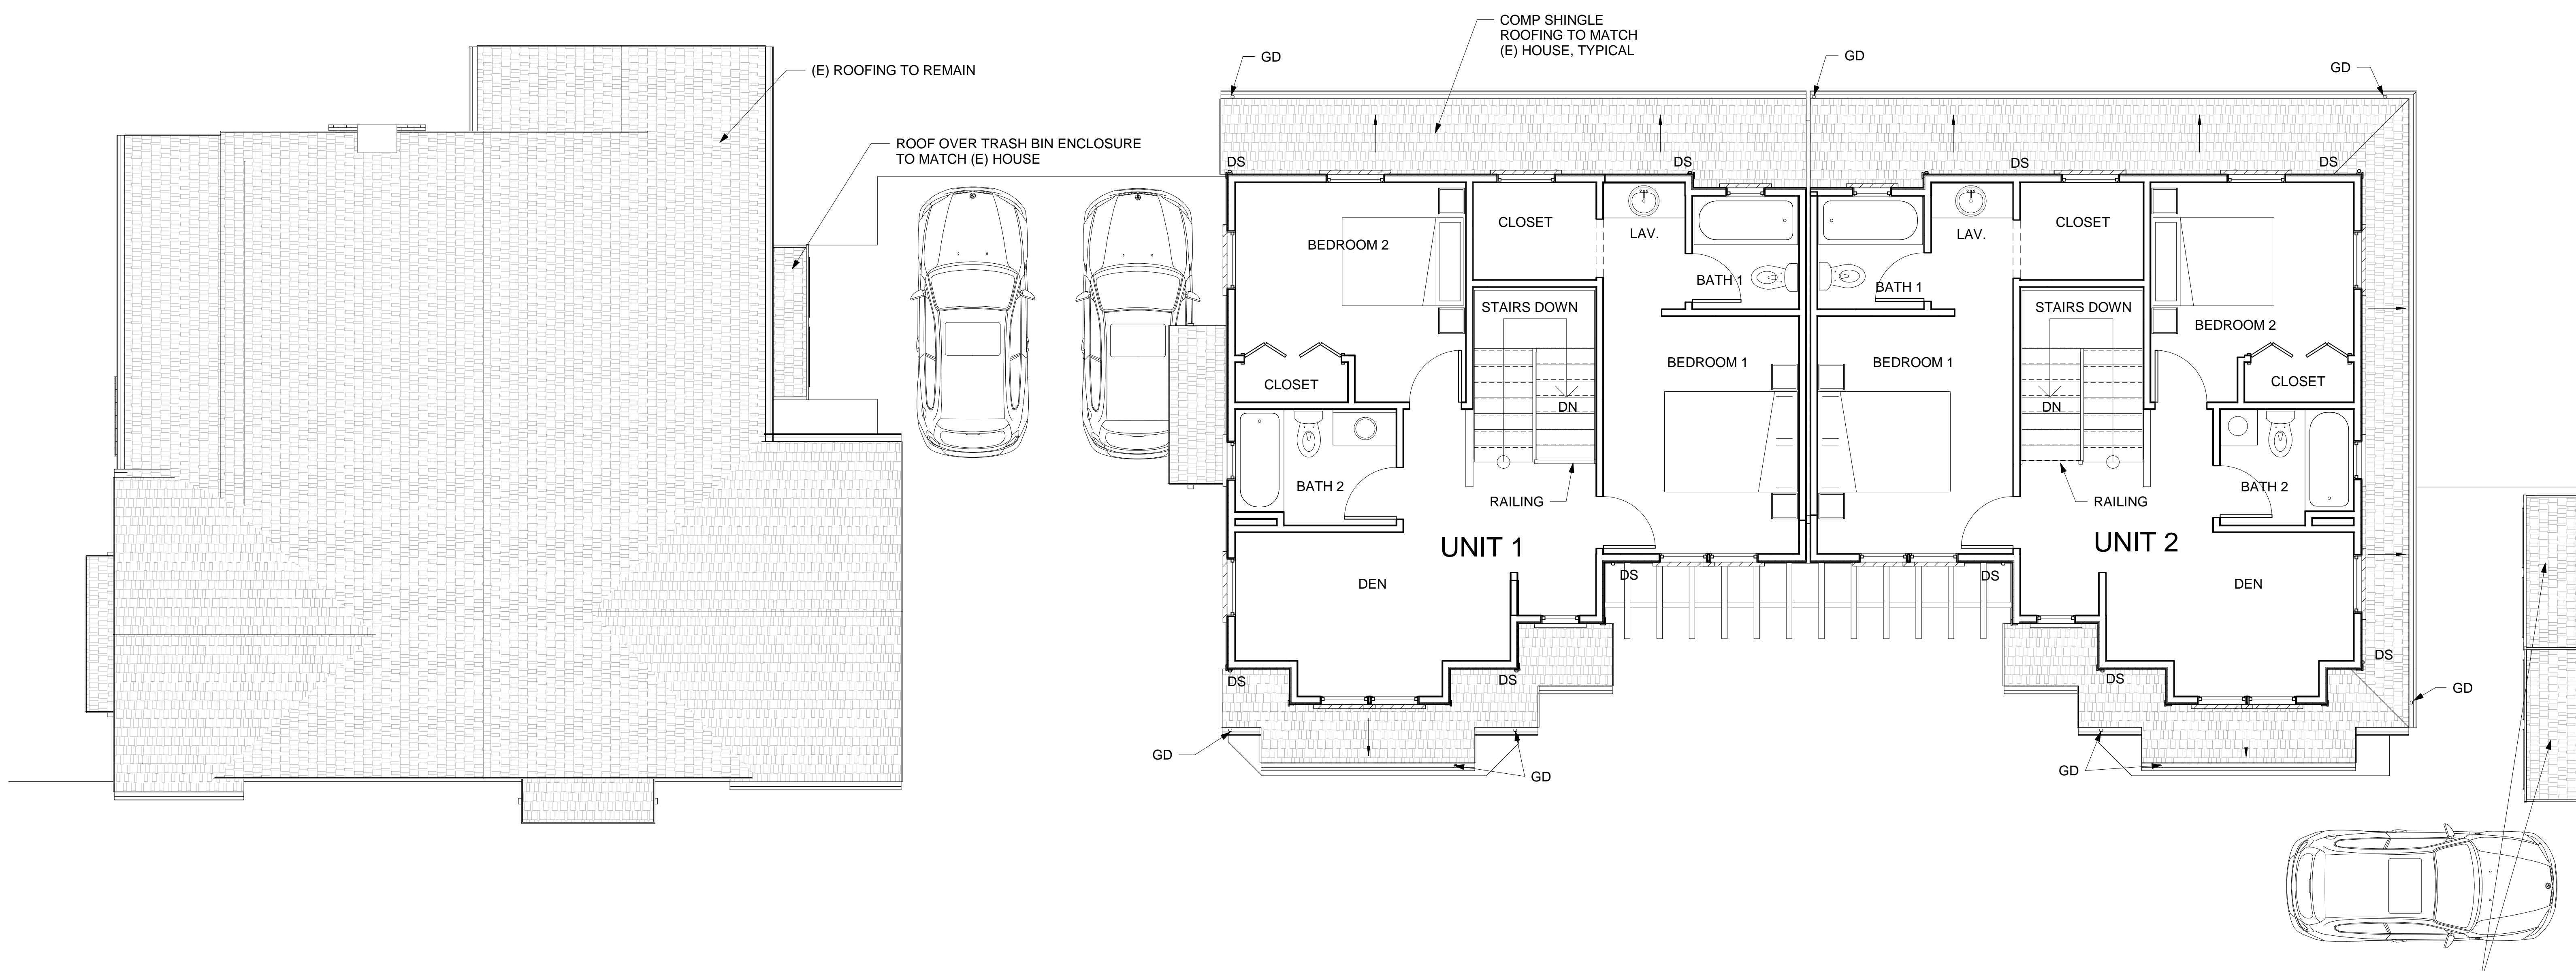

1 2ND FLOOR PLAN
1/4" = 1'-0"

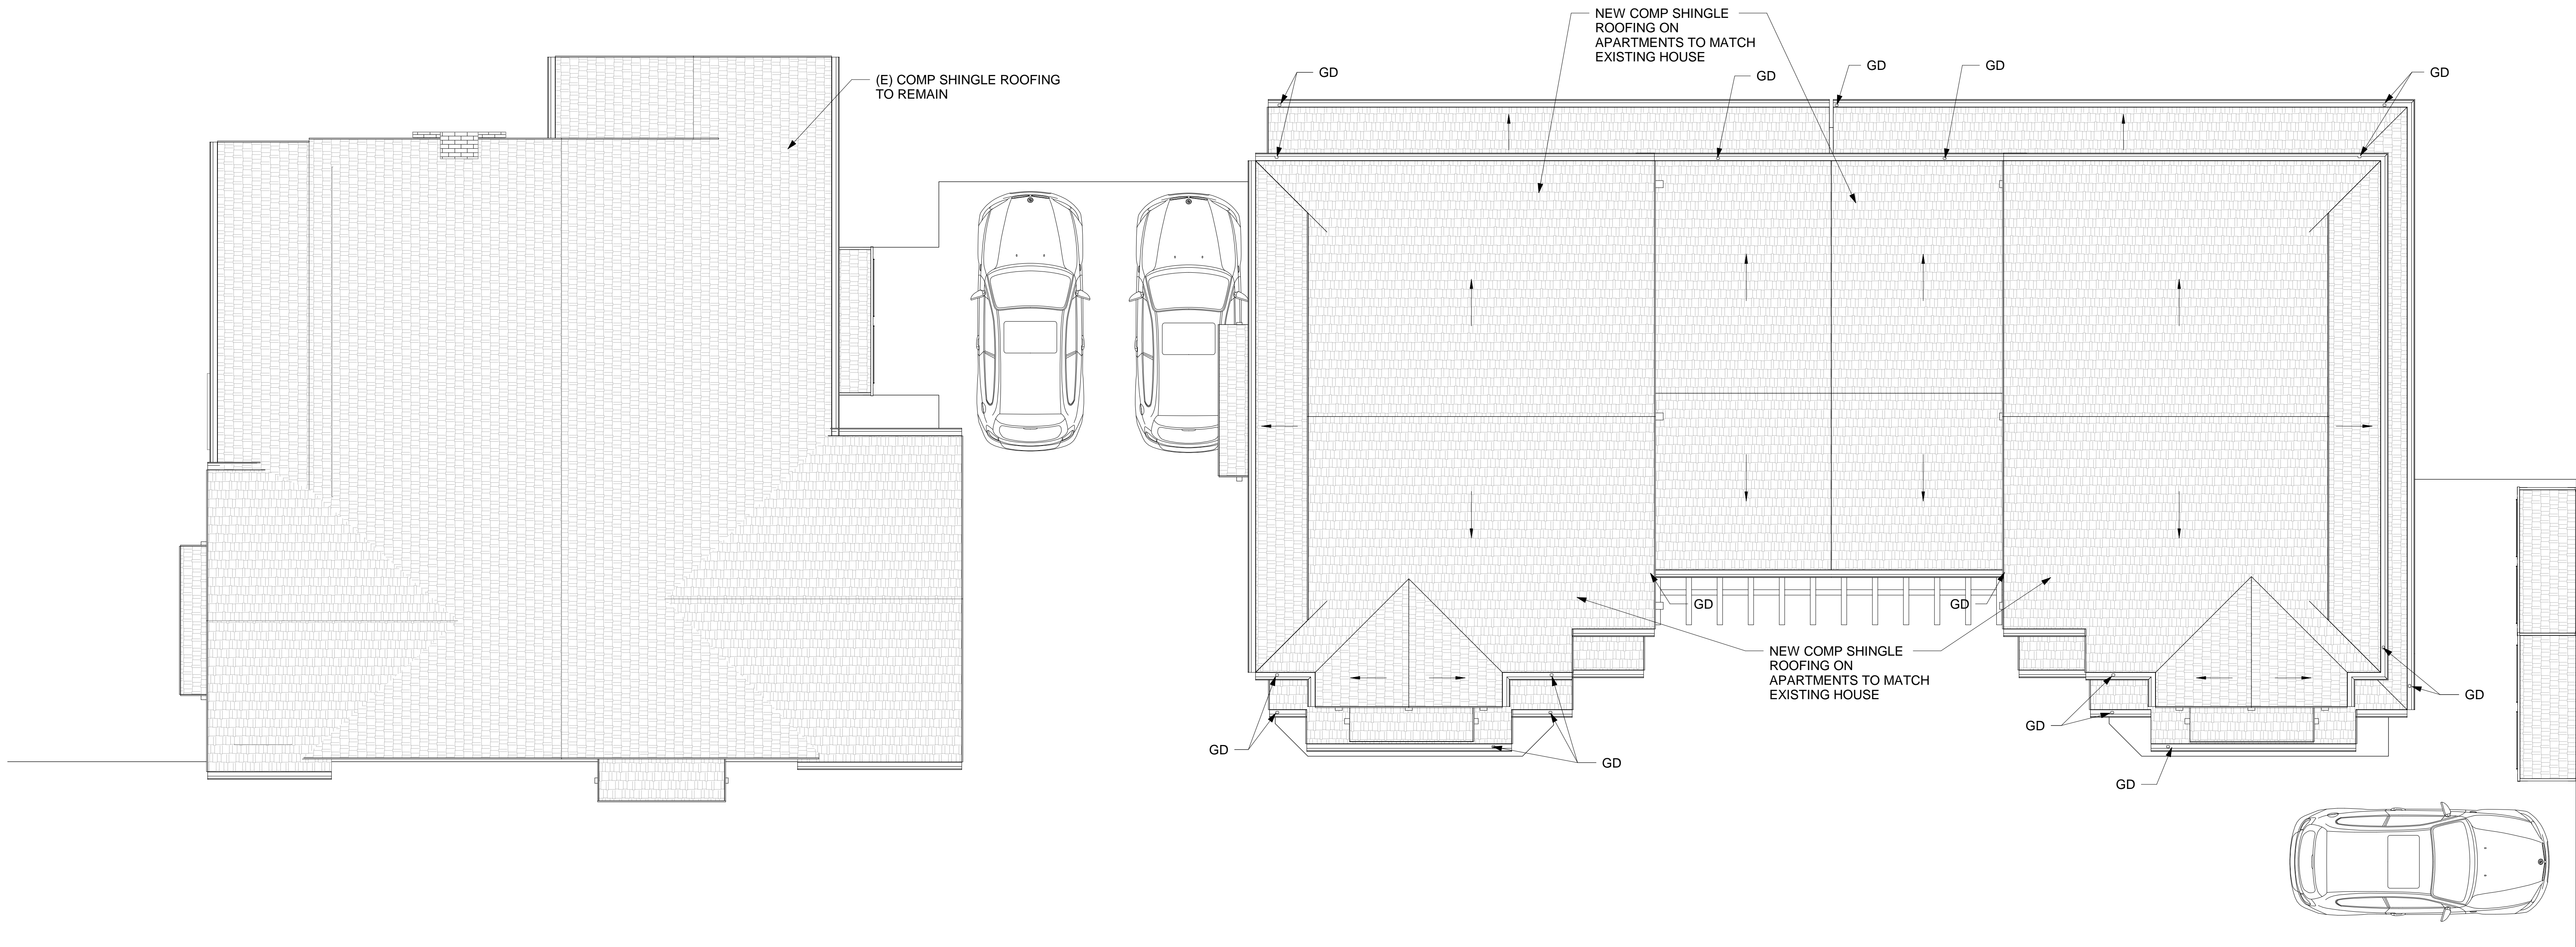

1 ROOF PLAN
1/4" = 1'-0"




1 NORTH ELEVATION
1/4" = 1'-0"

COVERED NONCOMBUSTIBLE ENCLOSURE WITH 3 REFUSE TOTES

PAINTED CEMENT FIBER LAPPED SIDING

2ND FLOOR PLAN
10'-0"

1st Floor
0"

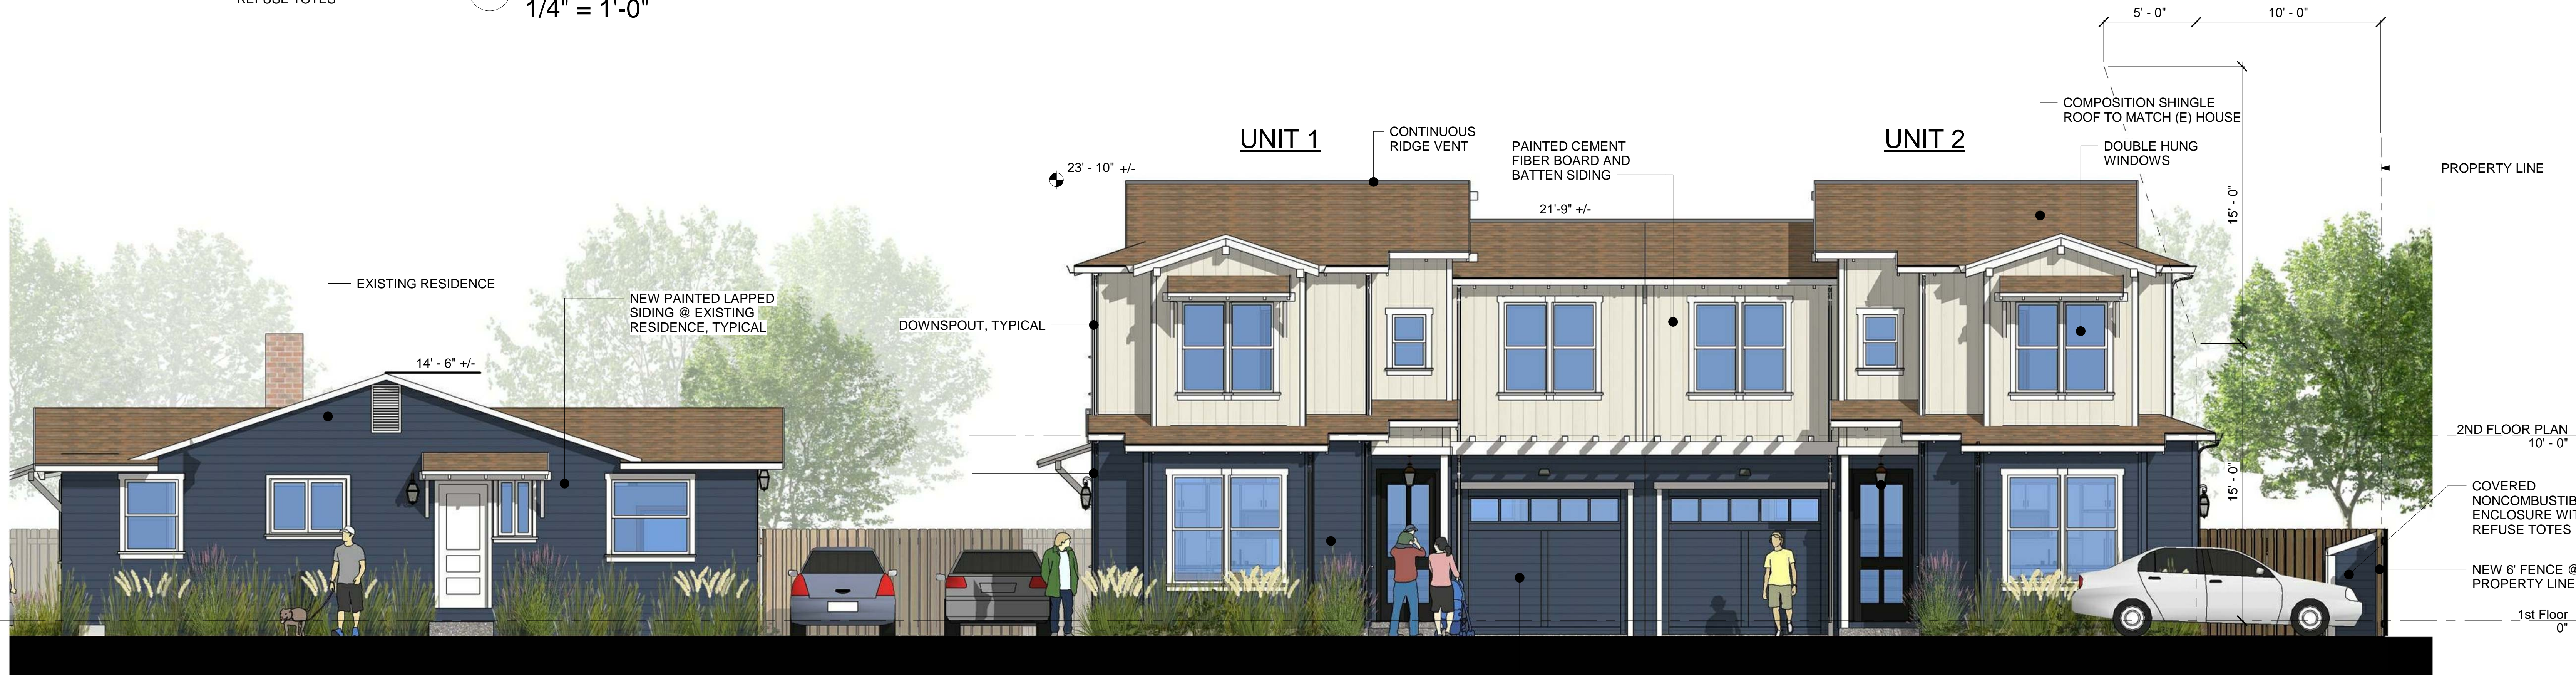

2 SOUTH ELEVATION
1/4" = 1'-0"

PAINTED CEMENT FIBER LAPPED SIDING

SECTIONAL GARAGE DOOR

DECORATIVE LIGHT FIXTURE, TYPICAL




1 WEST ELEVATION - (E) HOUSE
1/4" = 1'-0"



2 EAST ELEVATION - (E) HOUSE
1/4" = 1'-0"

COVERED NONCOMBUSTIBLE ENCLOSURE WITH 3 REFUSE TOTES

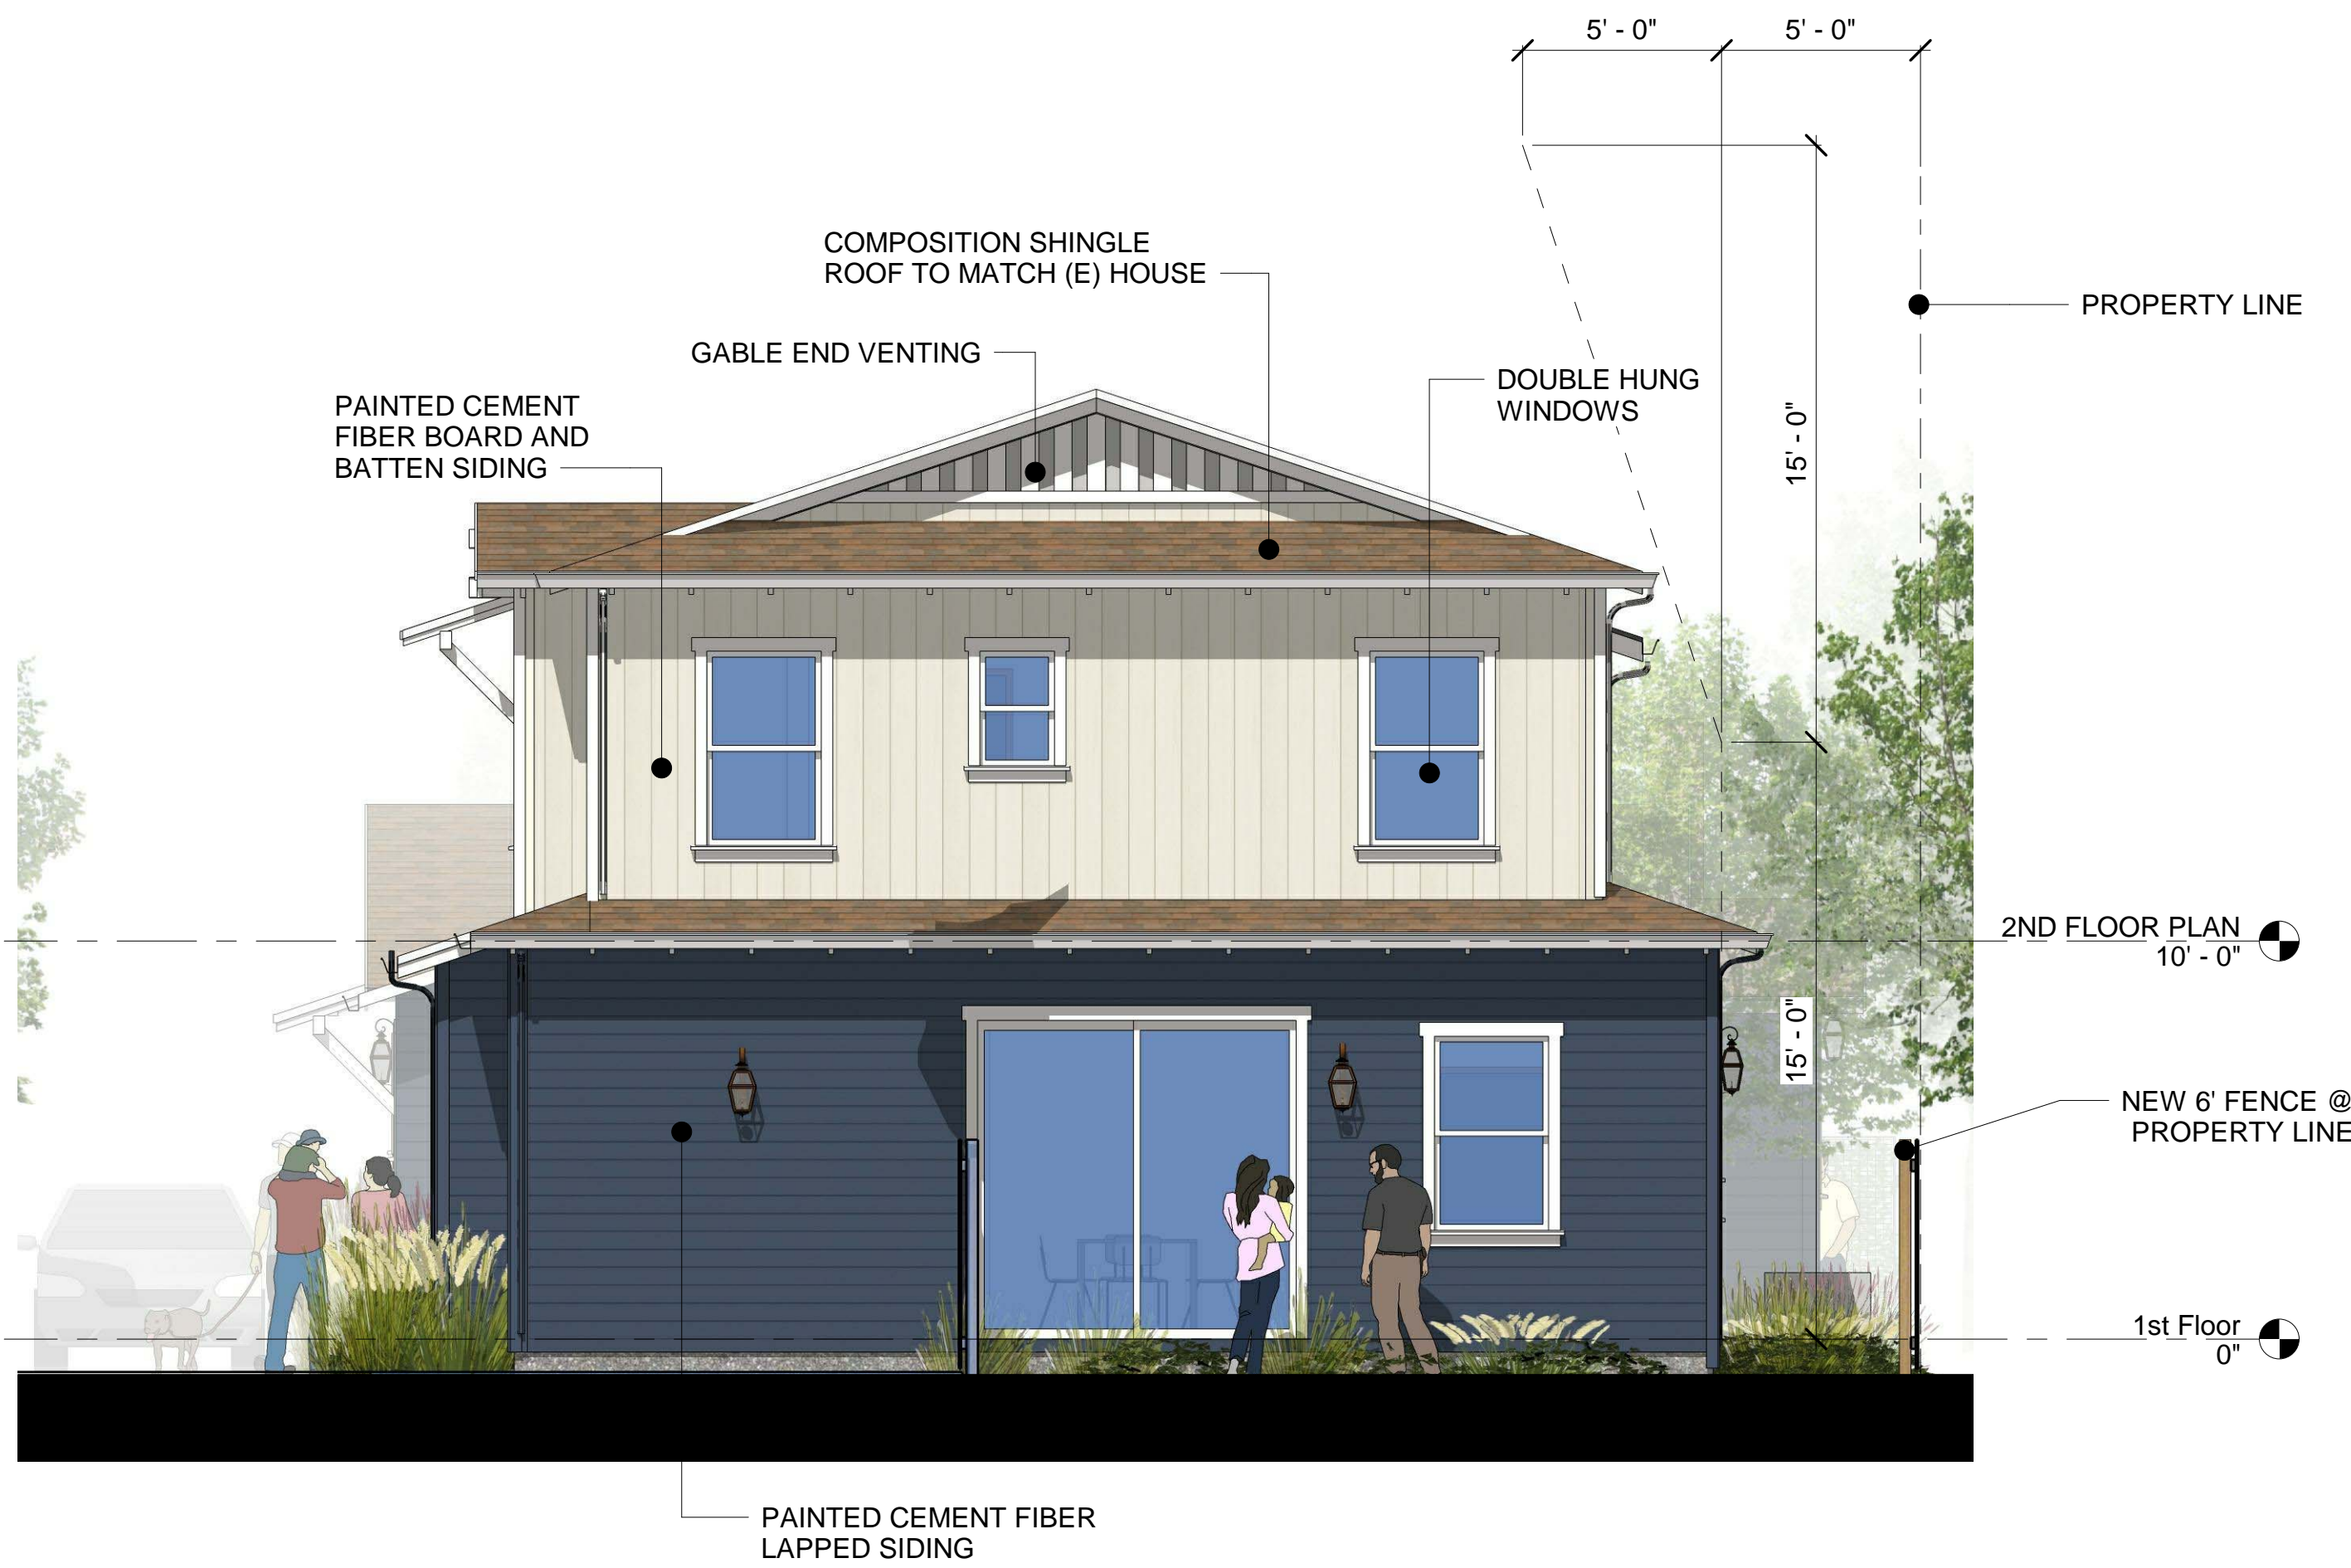

3 EAST ELEVATION - UNIT 2
1/4" = 1'-0"



4 WEST ELEVATION - UNIT 1
1/4" = 1'-0"

4006 — EXTERIOR DECORATIVE



SERIES: Mastermark® Collection
TYPE: Exterior Decorative
APPLICATIONS: Can be used for a swing door, with barn track hardware, with pivot hardware, in a patio swing door or slider system and many other applications for the home's exterior.

Construction Type: Engineered All-Wood Stiles and Rails with Dowel Pinned Stile/Rail Joinery

Panel: 1-1/4" Innerbond® Double Hip-Raised Panel Profile: Ovolo Sticking Glass: 5/8" Clear Insulated Glazing


STANDARD FEATURES

- Any Wood Species
- Virtually Any Size
- Glass Options
- UltraBlock® Technology
- Privacy Rating: 1

DETAILED DRAWING




DETAILS

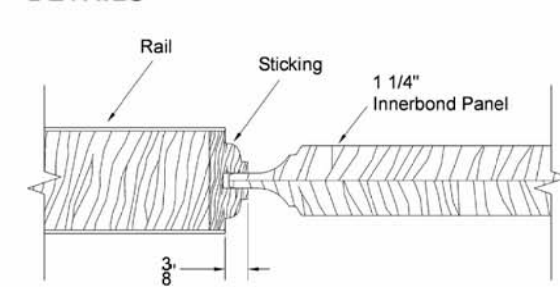


ENTRY DOOR




LIGHT FIXTURE

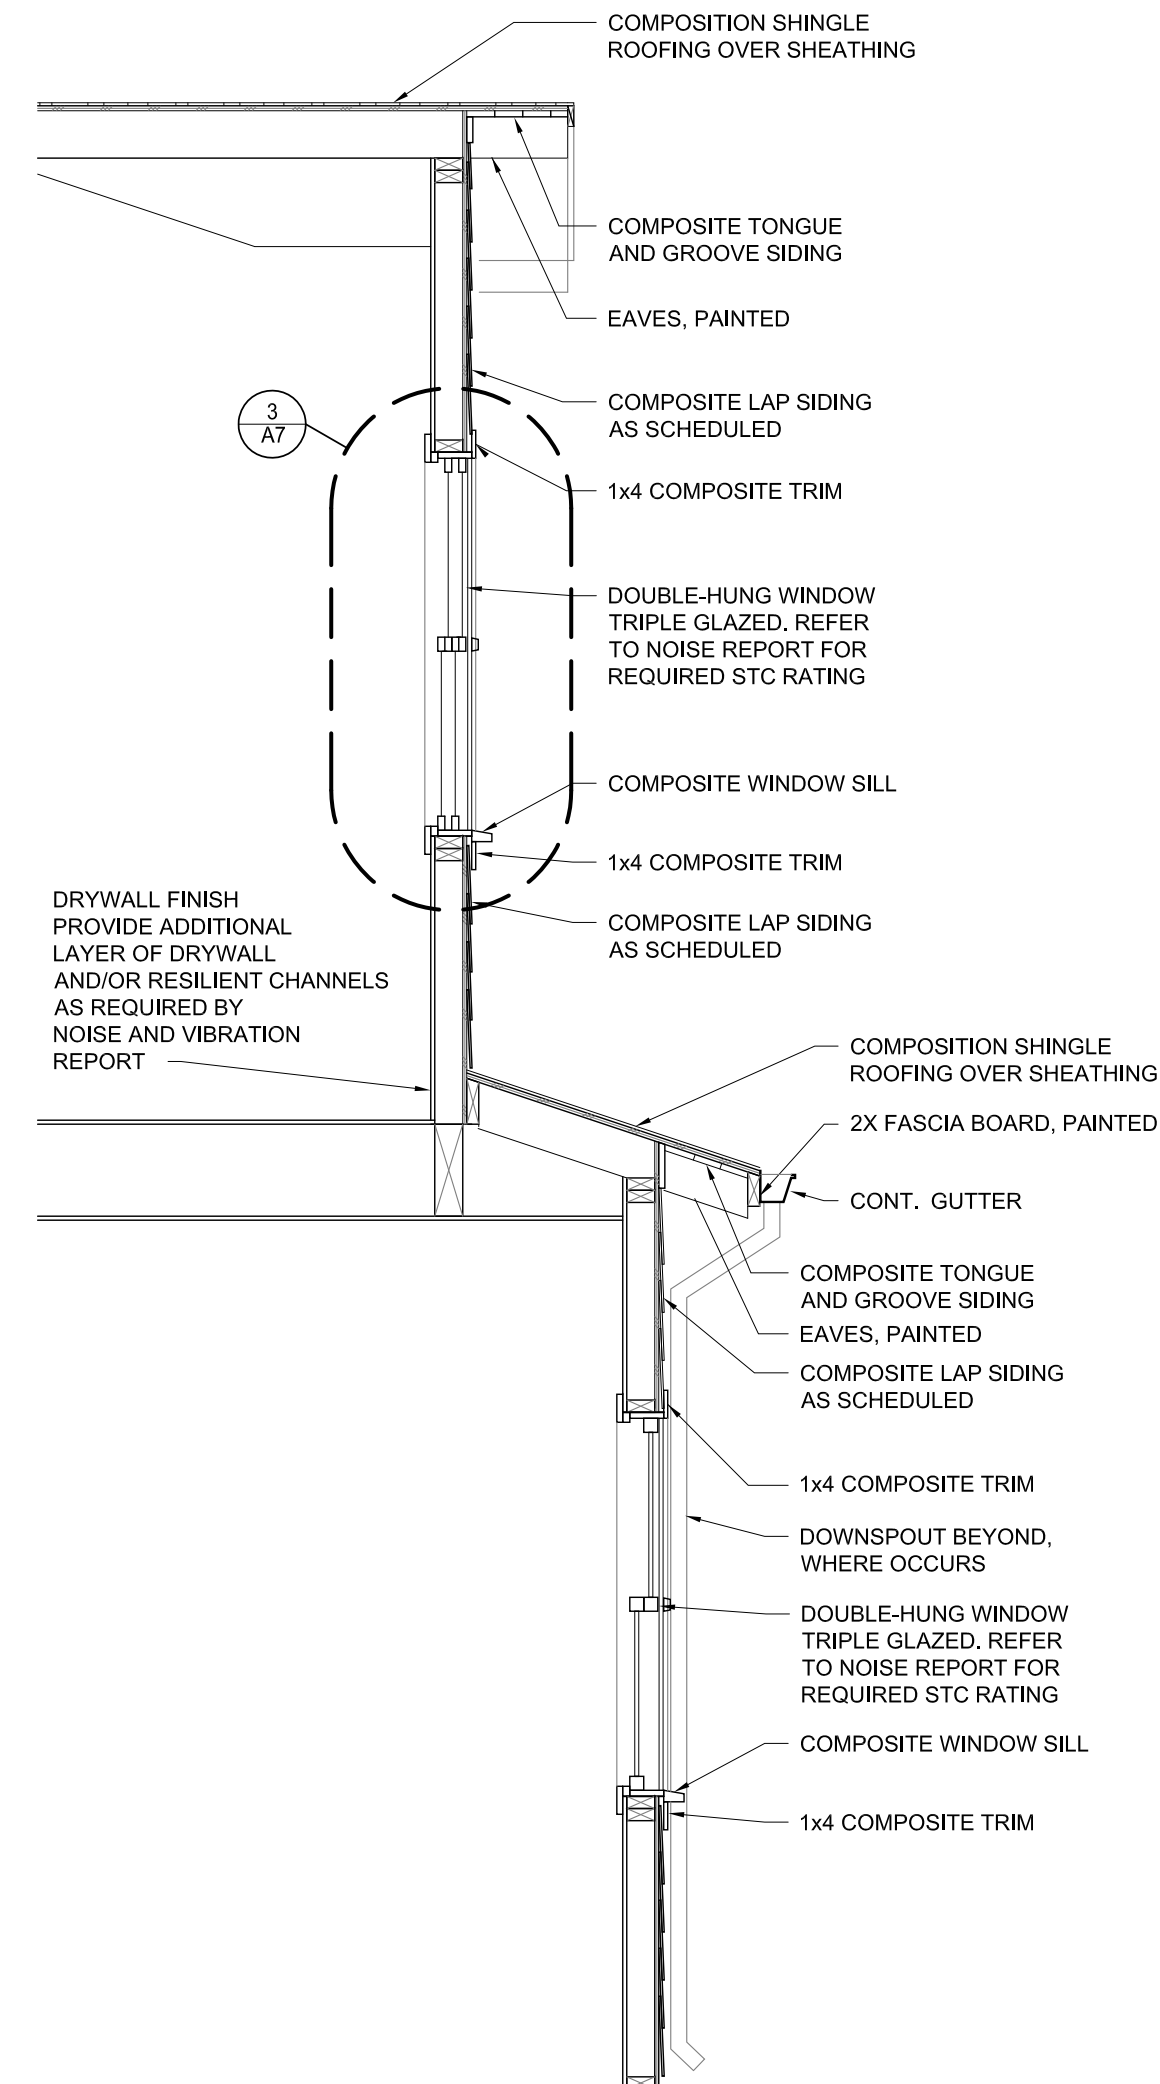


1 EXTERIOR WALL SECTION
1/2" = 1'-0"

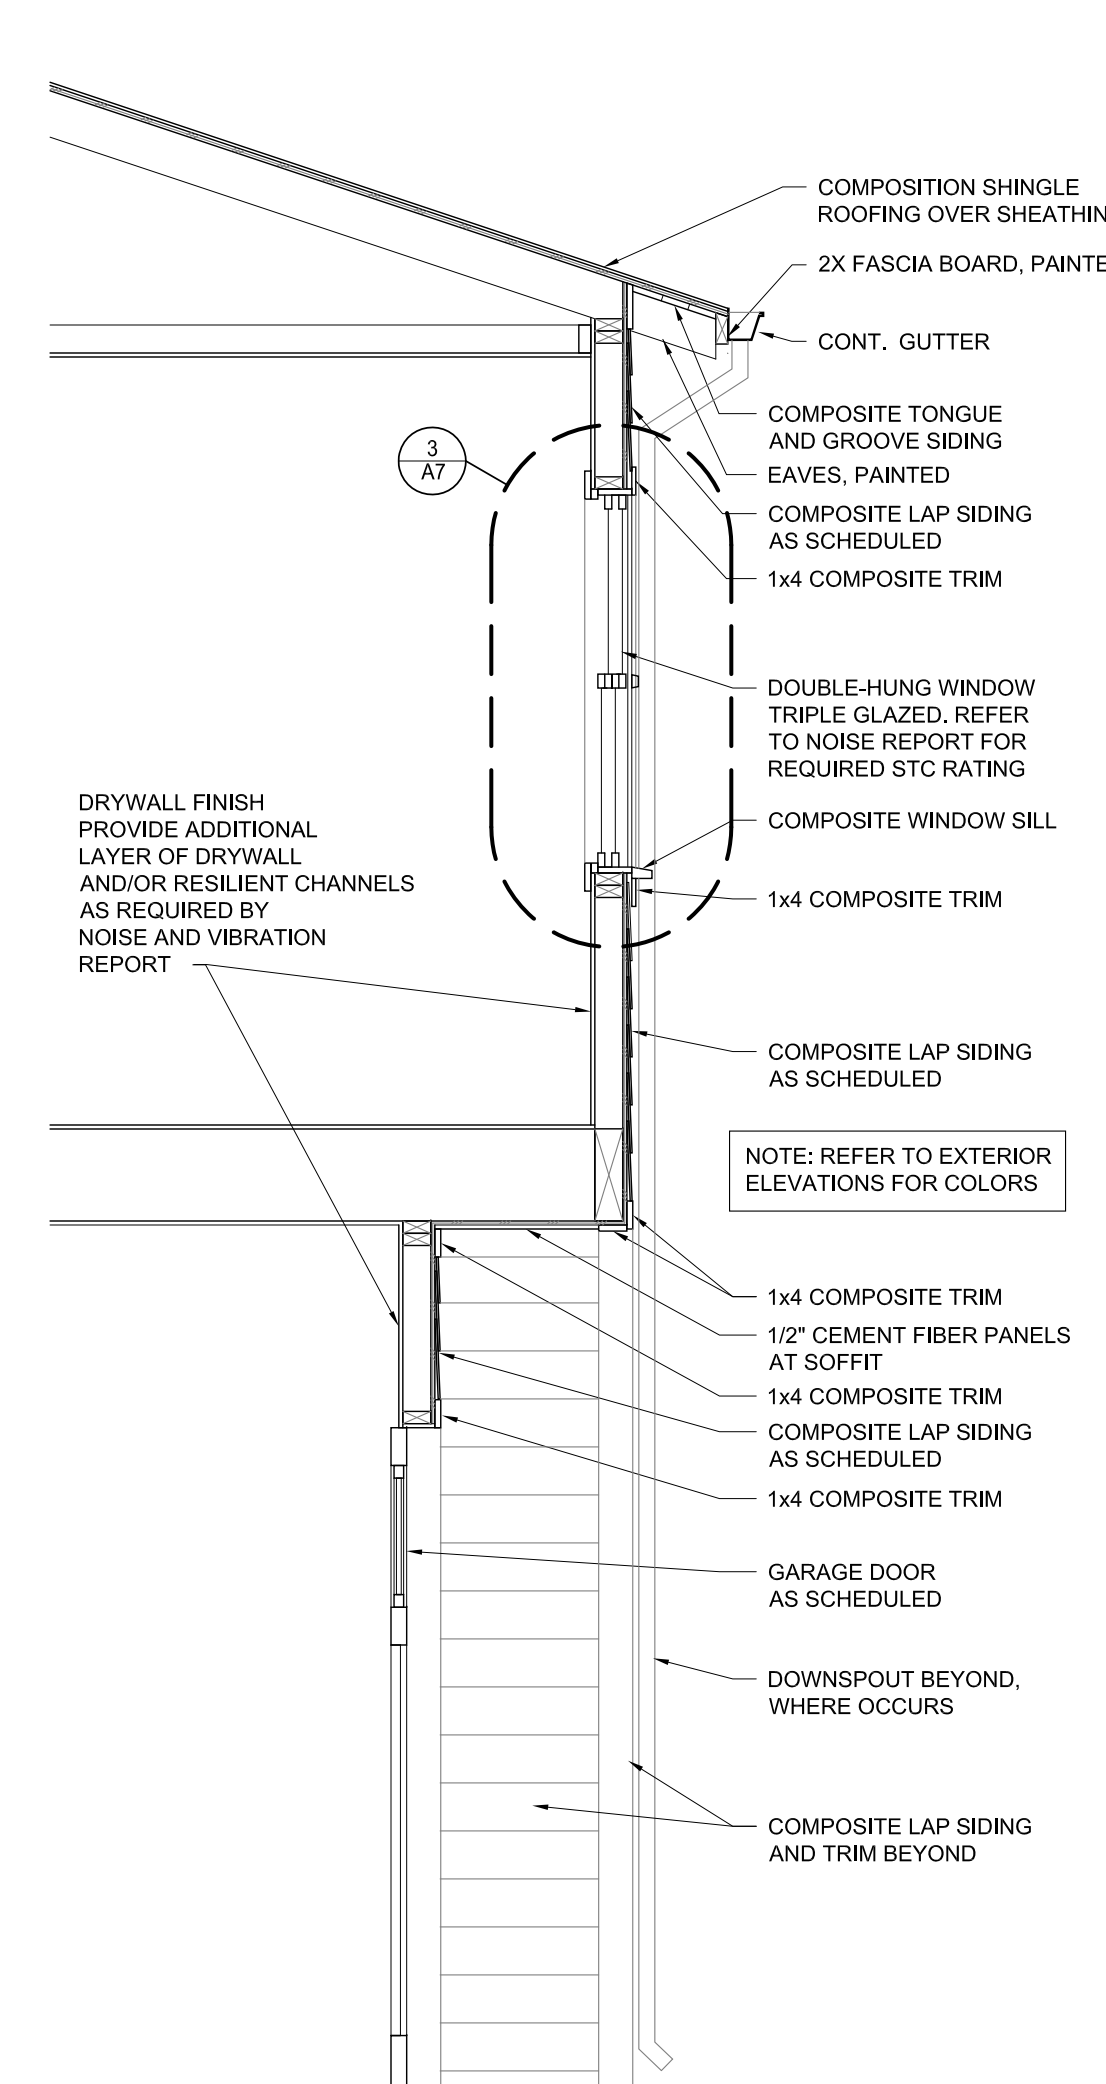


2 EXTERIOR WALL SECTION
1/2" = 1'-0"

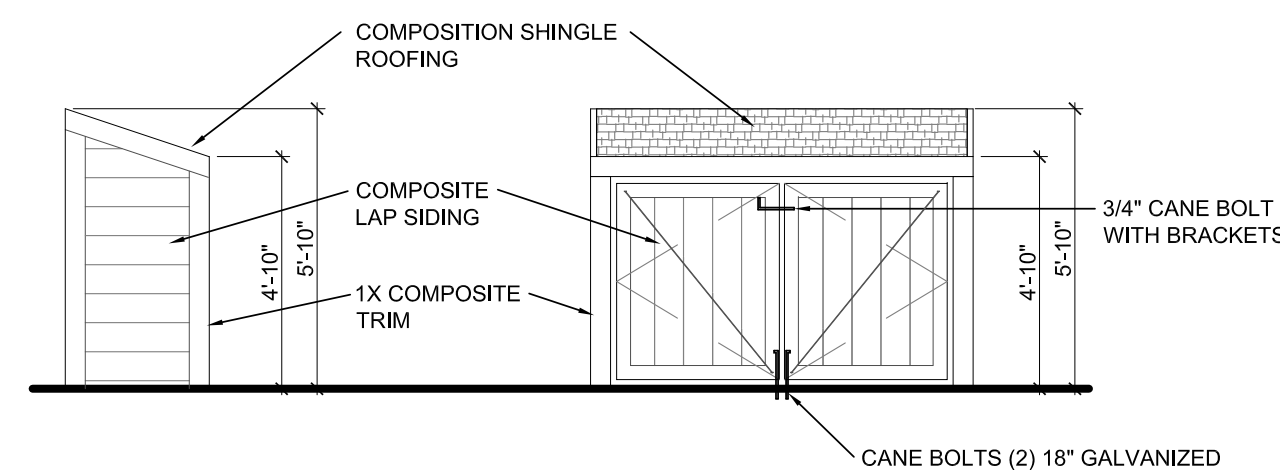

5 TRASH ENCLOSURE ELEVATIONS
1/4" = 1'-0"

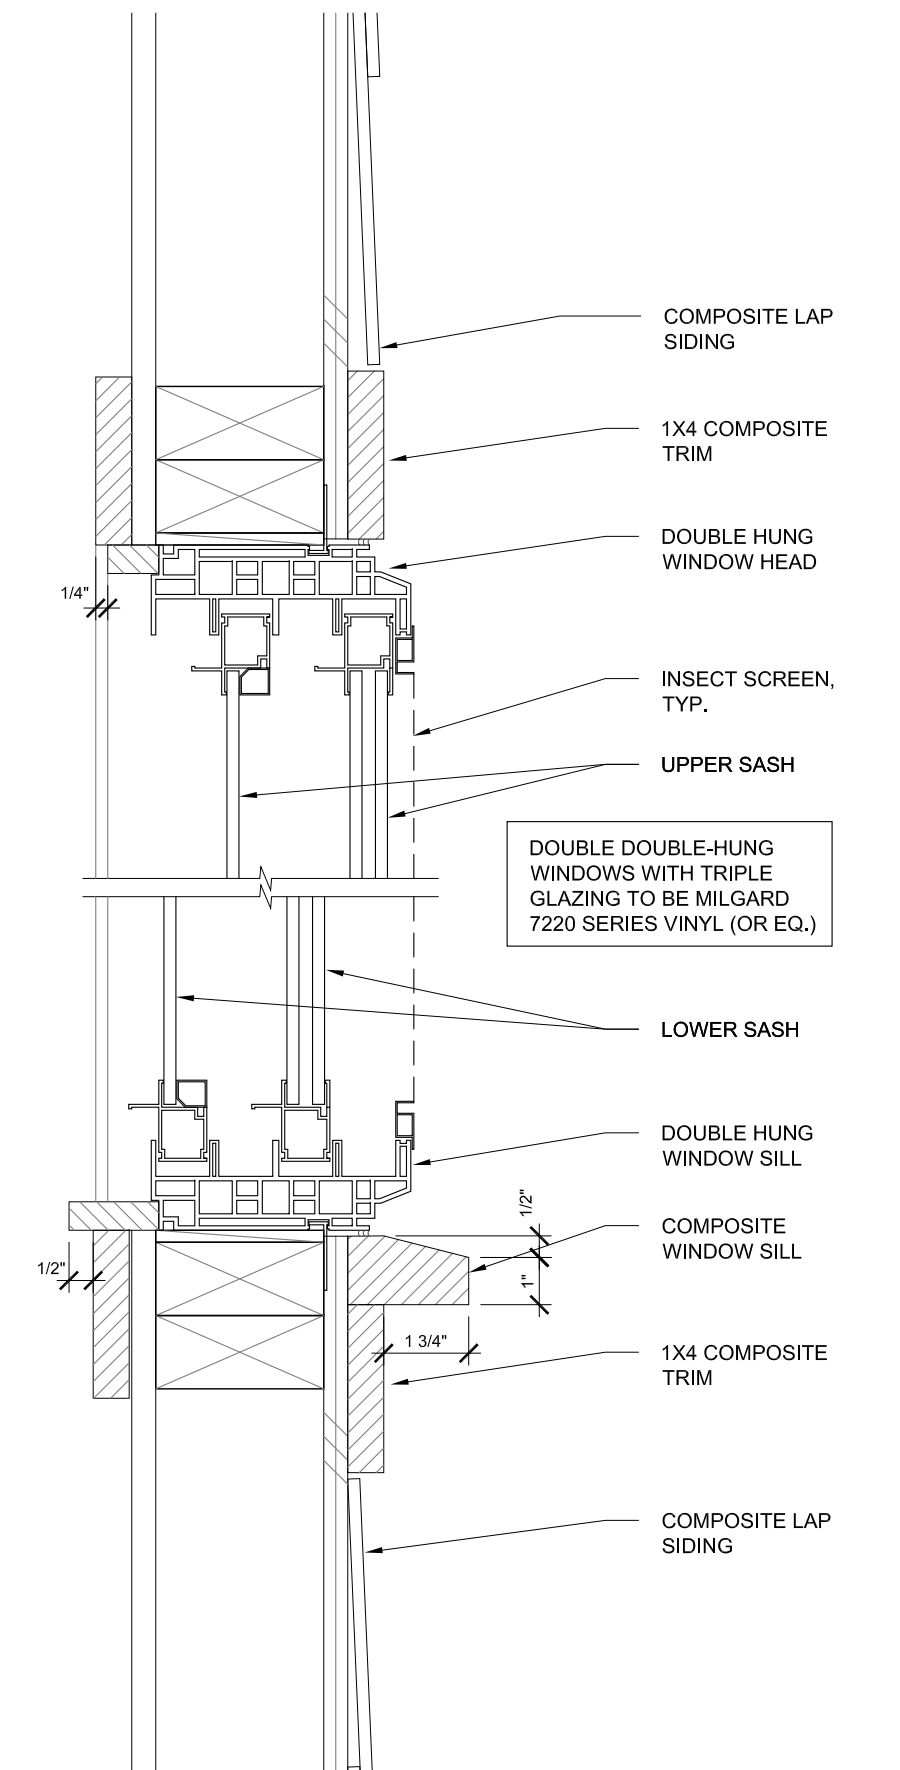

3 SECTION AT WINDOW
3" = 1'-0"

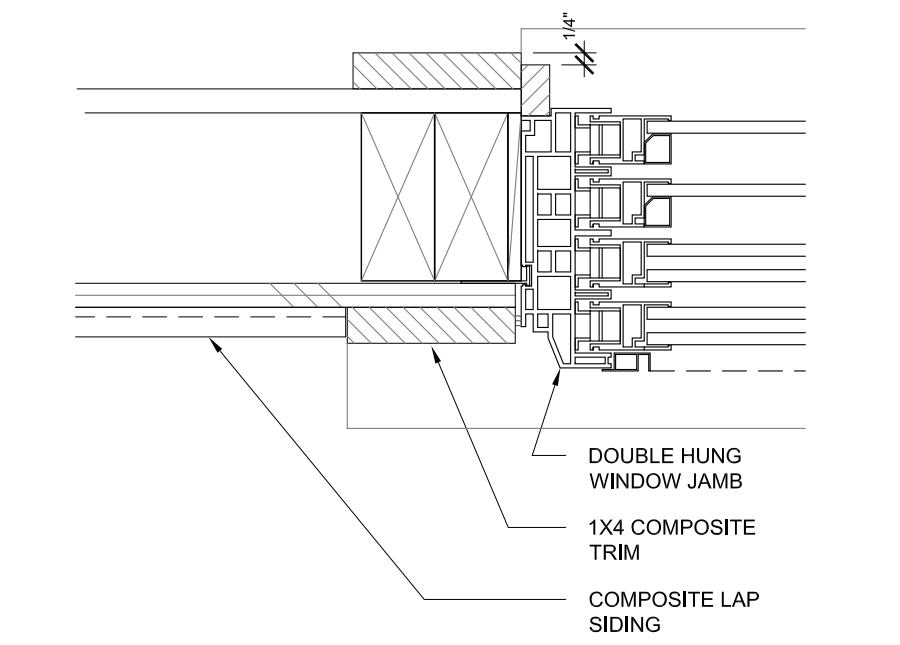

4 JAMB AT WINDOW
3" = 1'-0"



carriage house LOOKS for LESS



The Grand Harbor® Collection

Enhance the classic details of your home without breaking your budget.

When budget is the deciding factor, this low-maintenance, insulation-optional steel frame carriage house style garage door combines clean lines and classic charm to provide a popular style at a great value.

Accented with decorative black wrought iron hardware, these doors have the appearance of a swing-out door, but offer the convenience of modern overhead operation.

Door Designs

Solid Top Sections
Solid top sections in rectangular, square and arch designs provide more design options to complement new home styles.

Faux Top Sections
Faux top sections create the illusion of a window by using a solid dark gray steel background with arch, square and rectangular grille overlays. Provides added security while creating the appearance of a real window.







Glazed Top Sections
Glazed top sections in clear or obscure glass and snap-in grilles create square and rectangular designs. Wrought iron windows feature a black iron-look design on a "seeded" look acrylic that provides an Old World European style to complement light fixtures, entry doors and other decorative features.

Top/Window Sections


SERIES 1 & SERIES 2
TOP11, TOP12, Wrought Iron Short, TOP13, ARCH1, Wrought Iron Long, XG14, XG14, XA24, Plain Short, RED12, SQ22, Plain Long, RED14, SQ24, ARCH, GRW1, QRLA1

SERIES 3 & SERIES 4
TOP11, ARCH1, Additional cable with door design available.


GARAGE DOOR

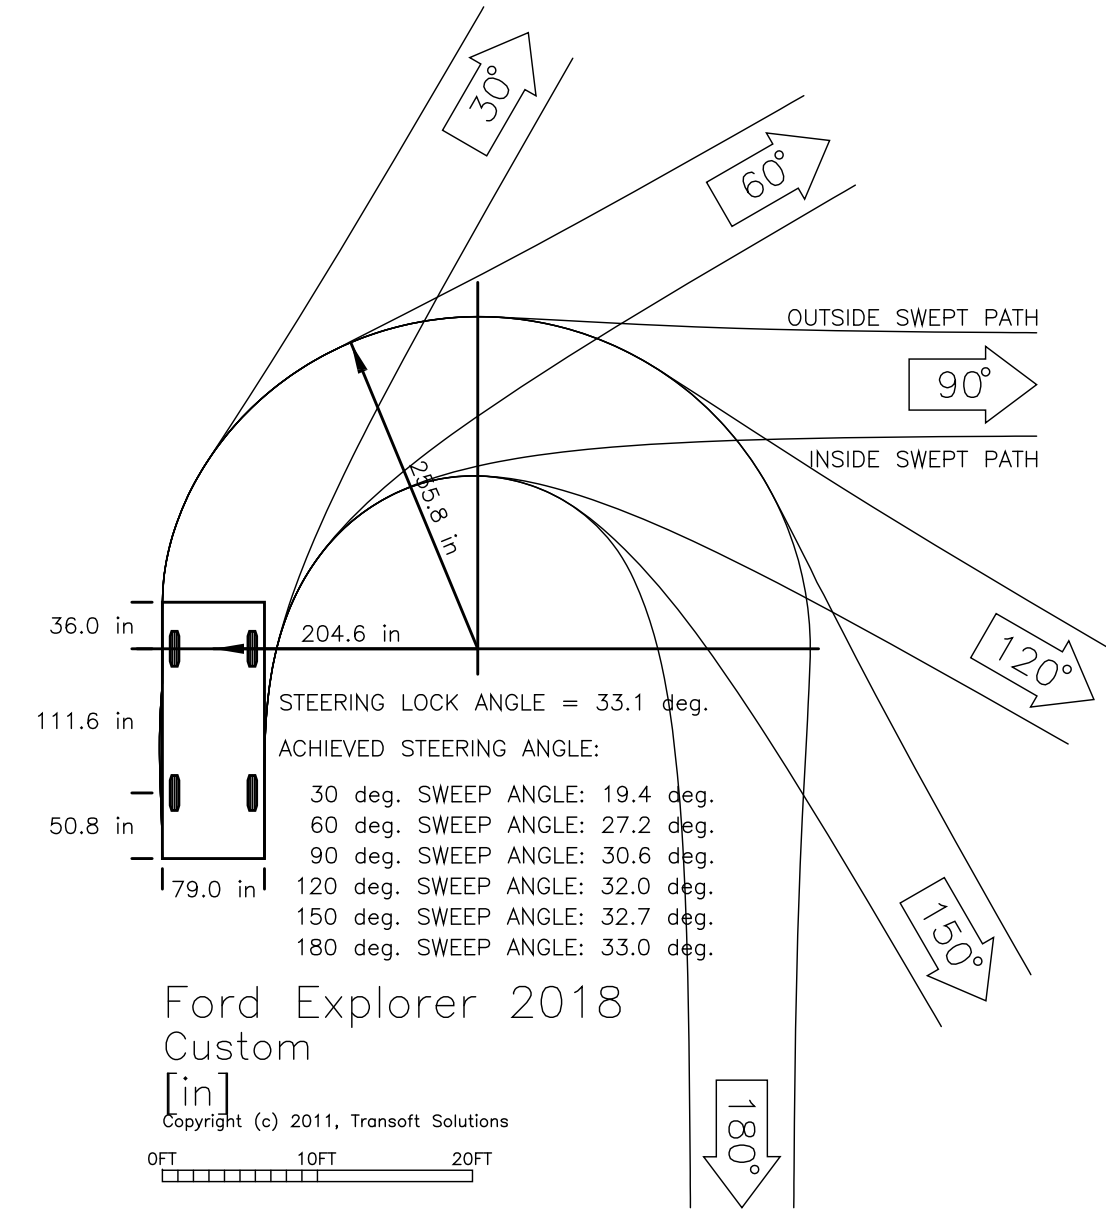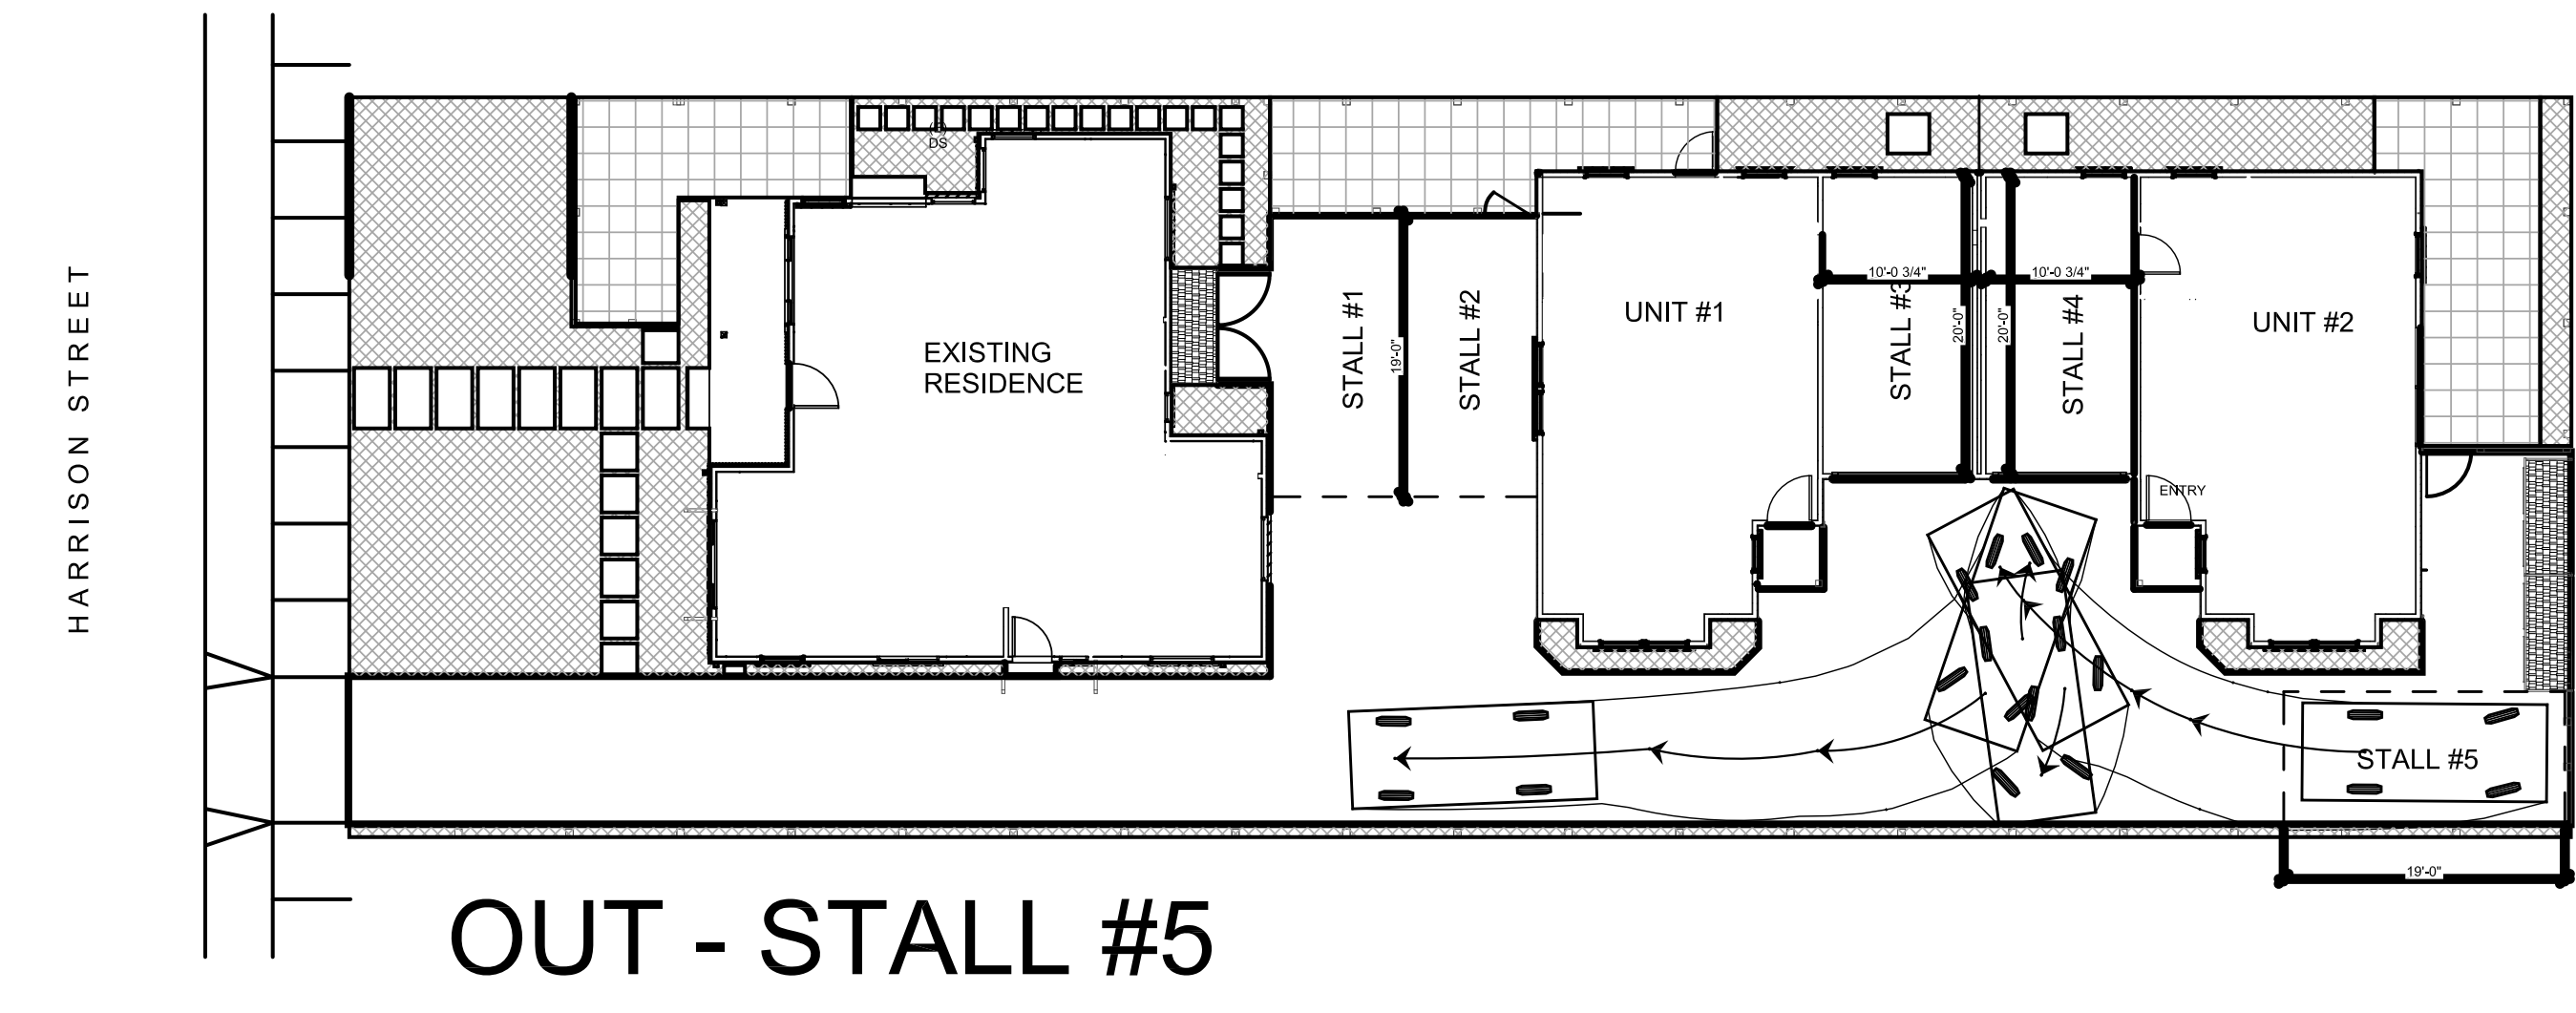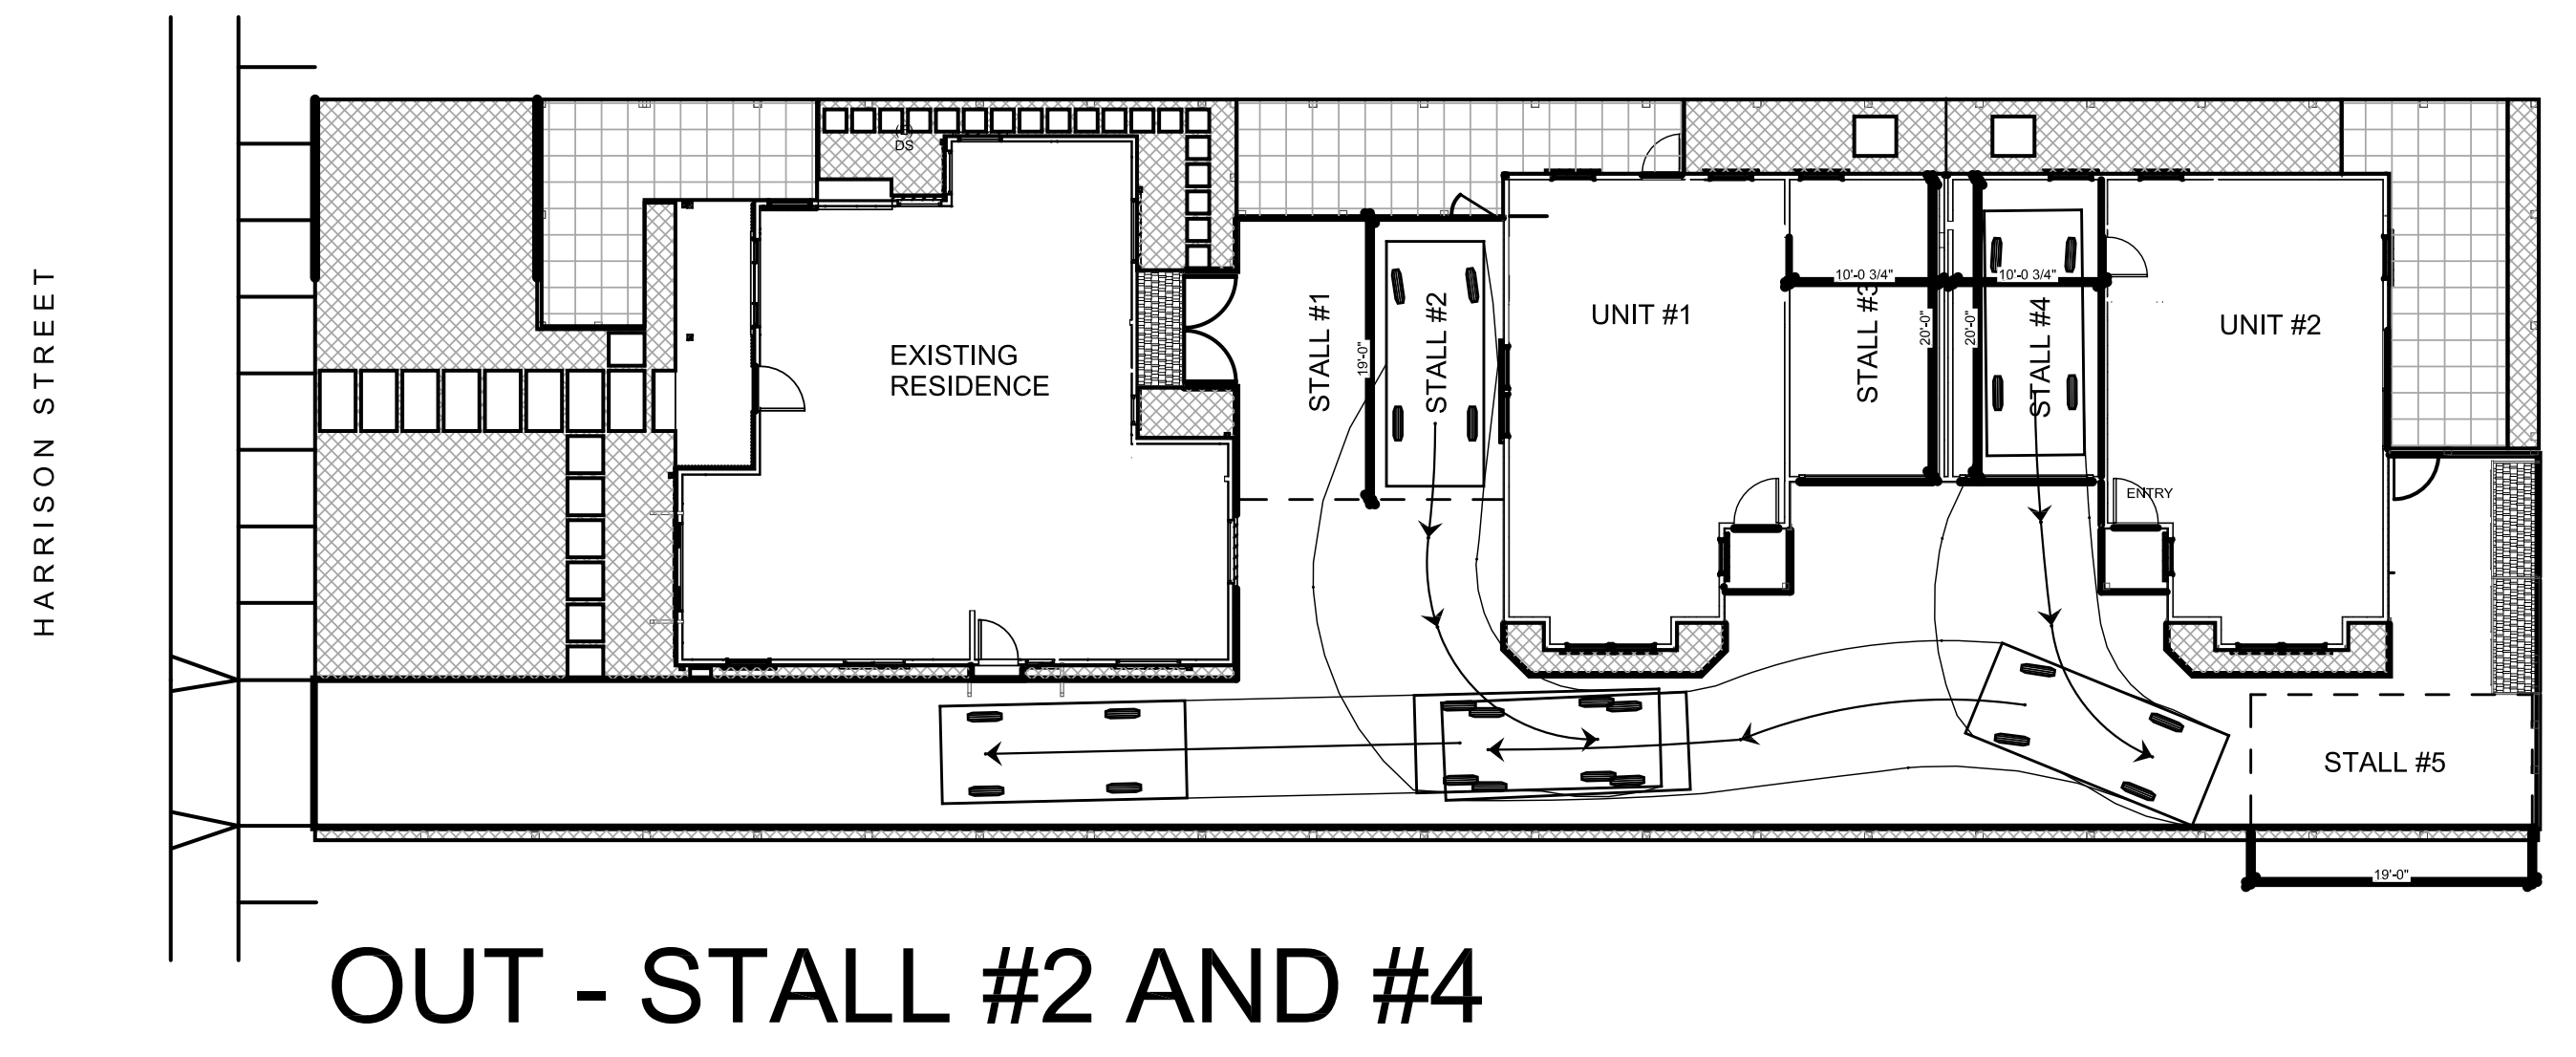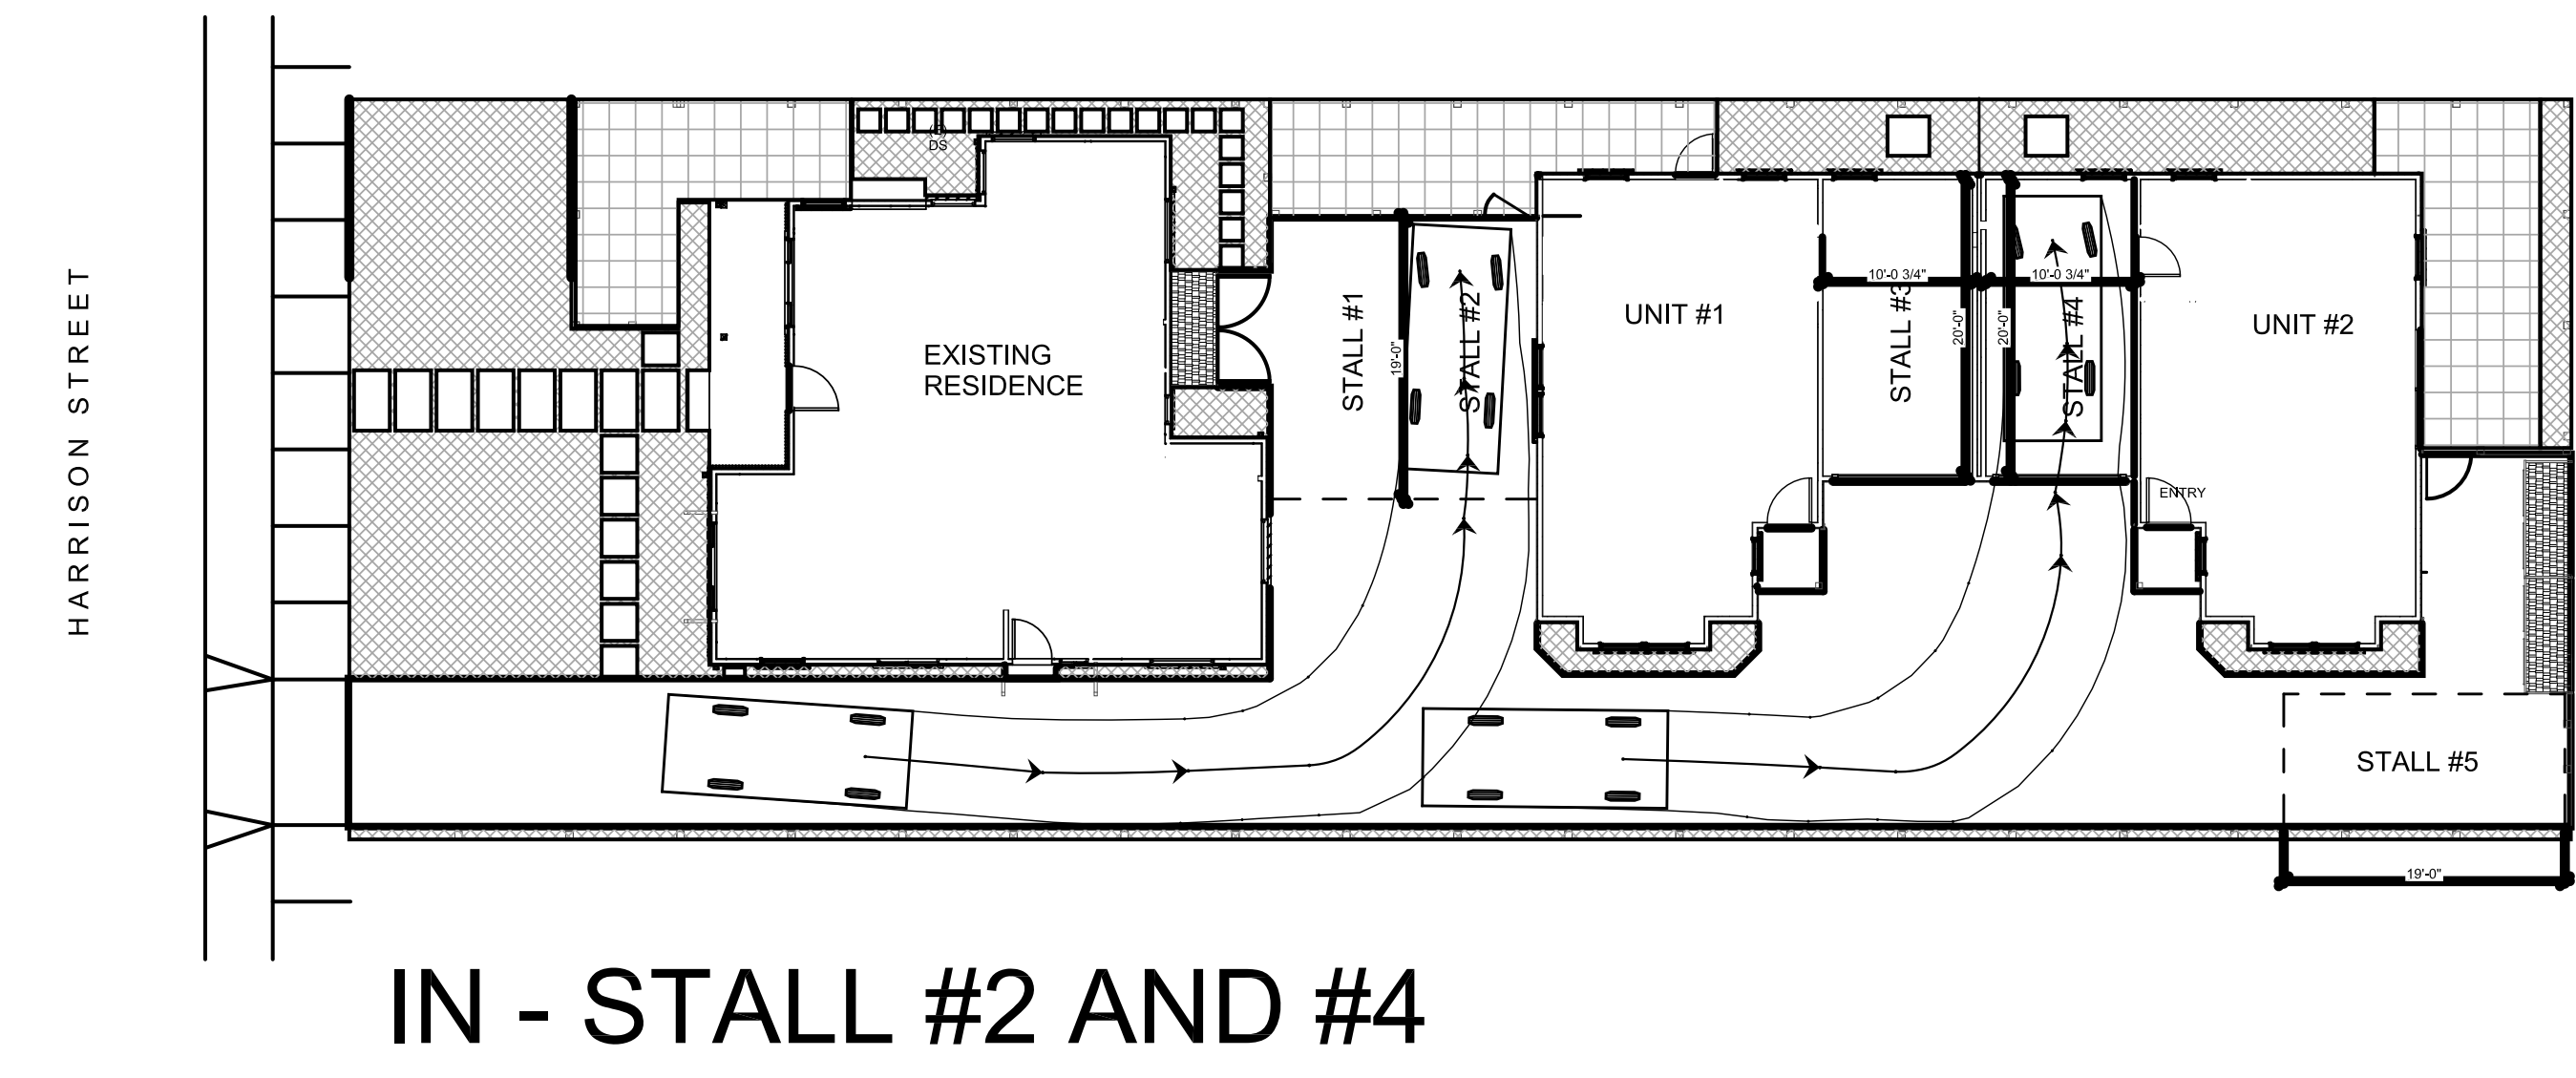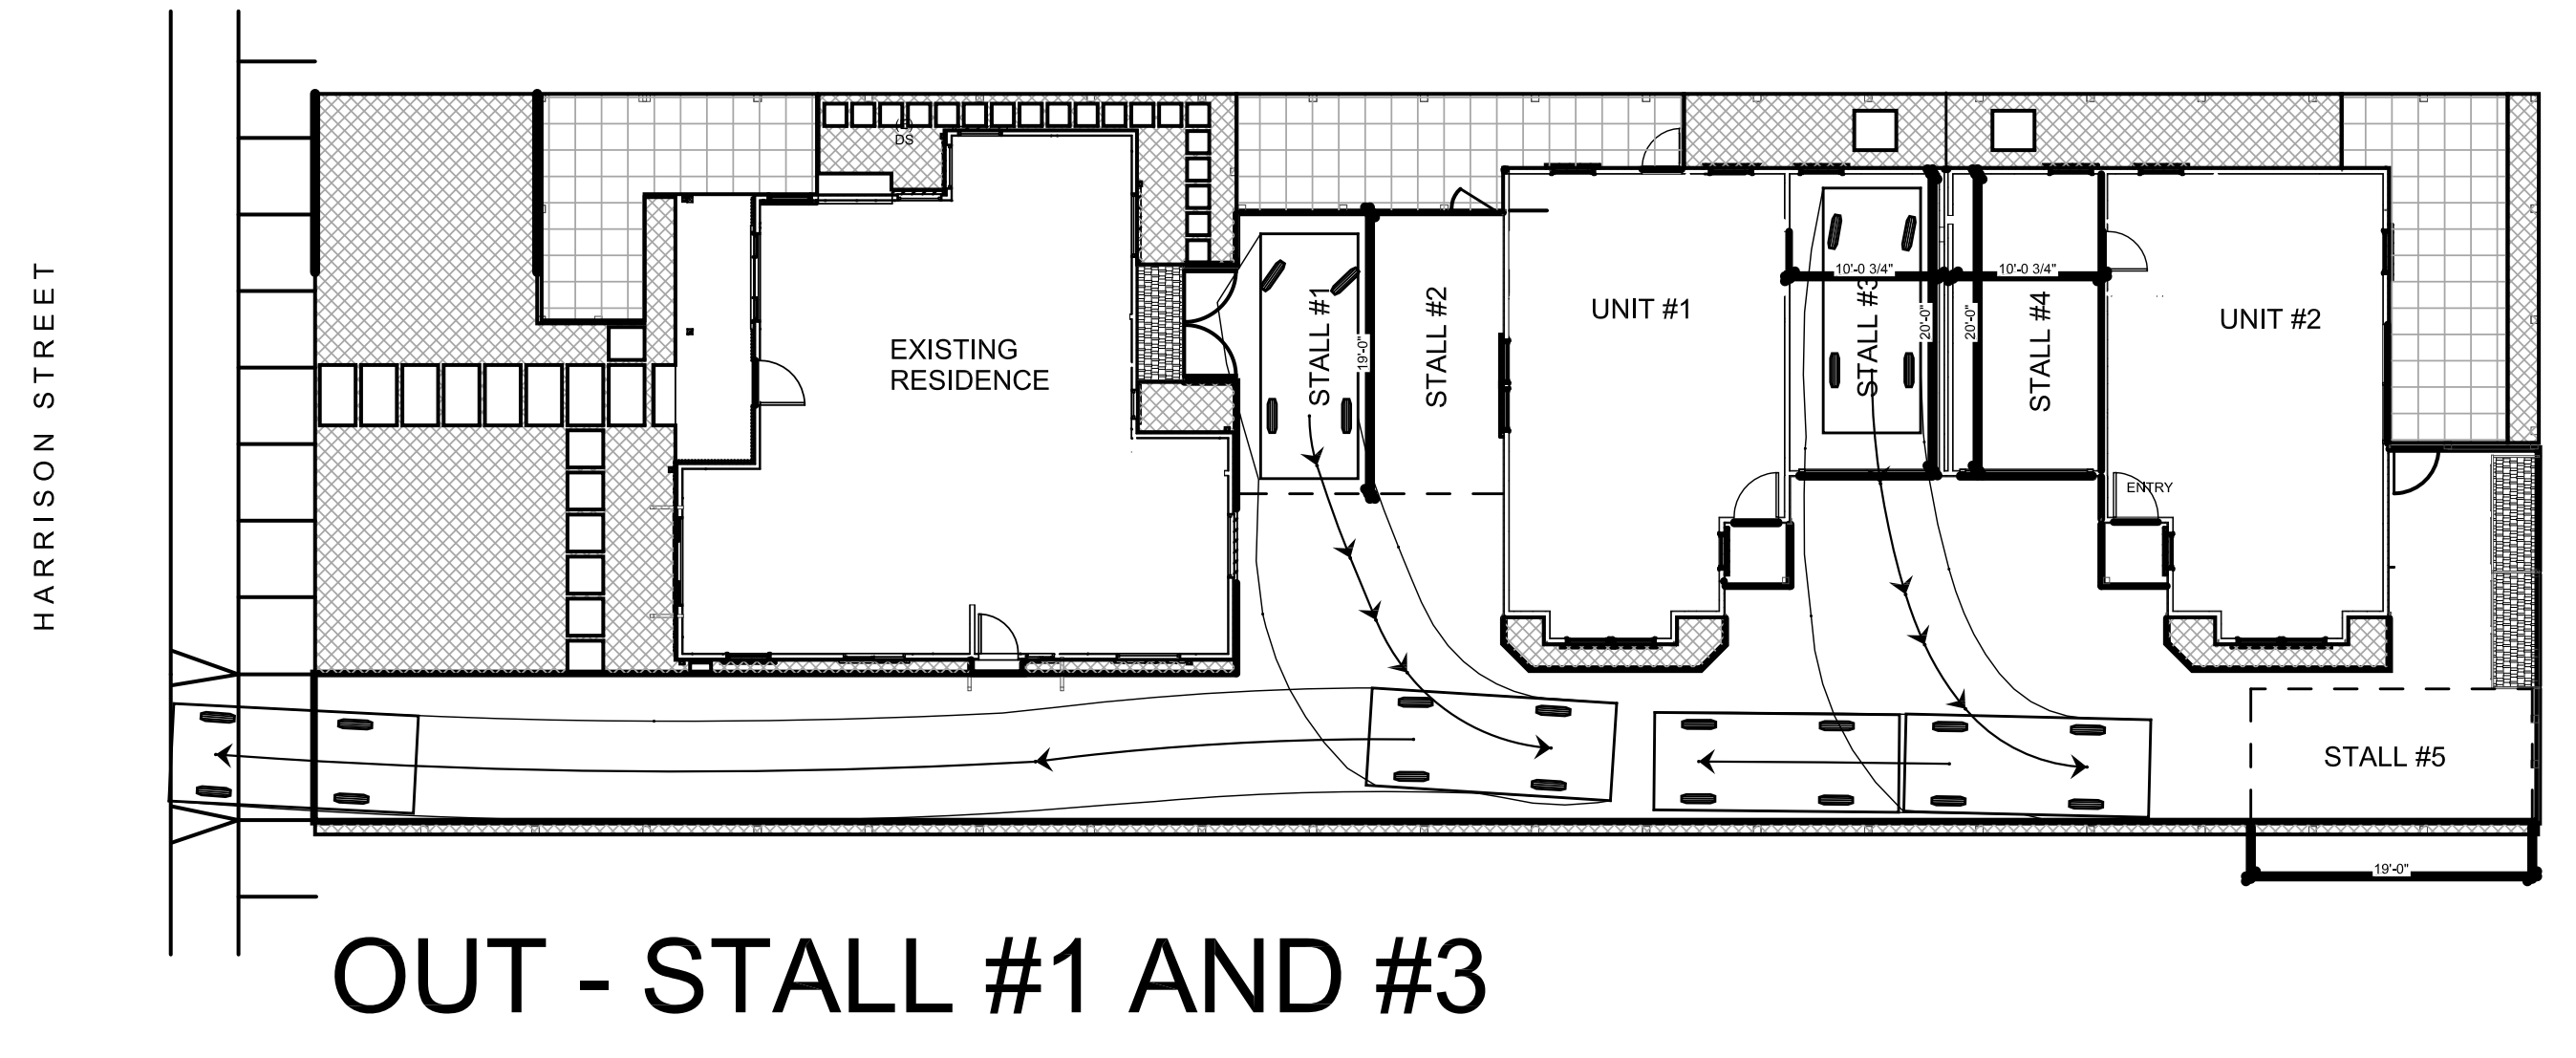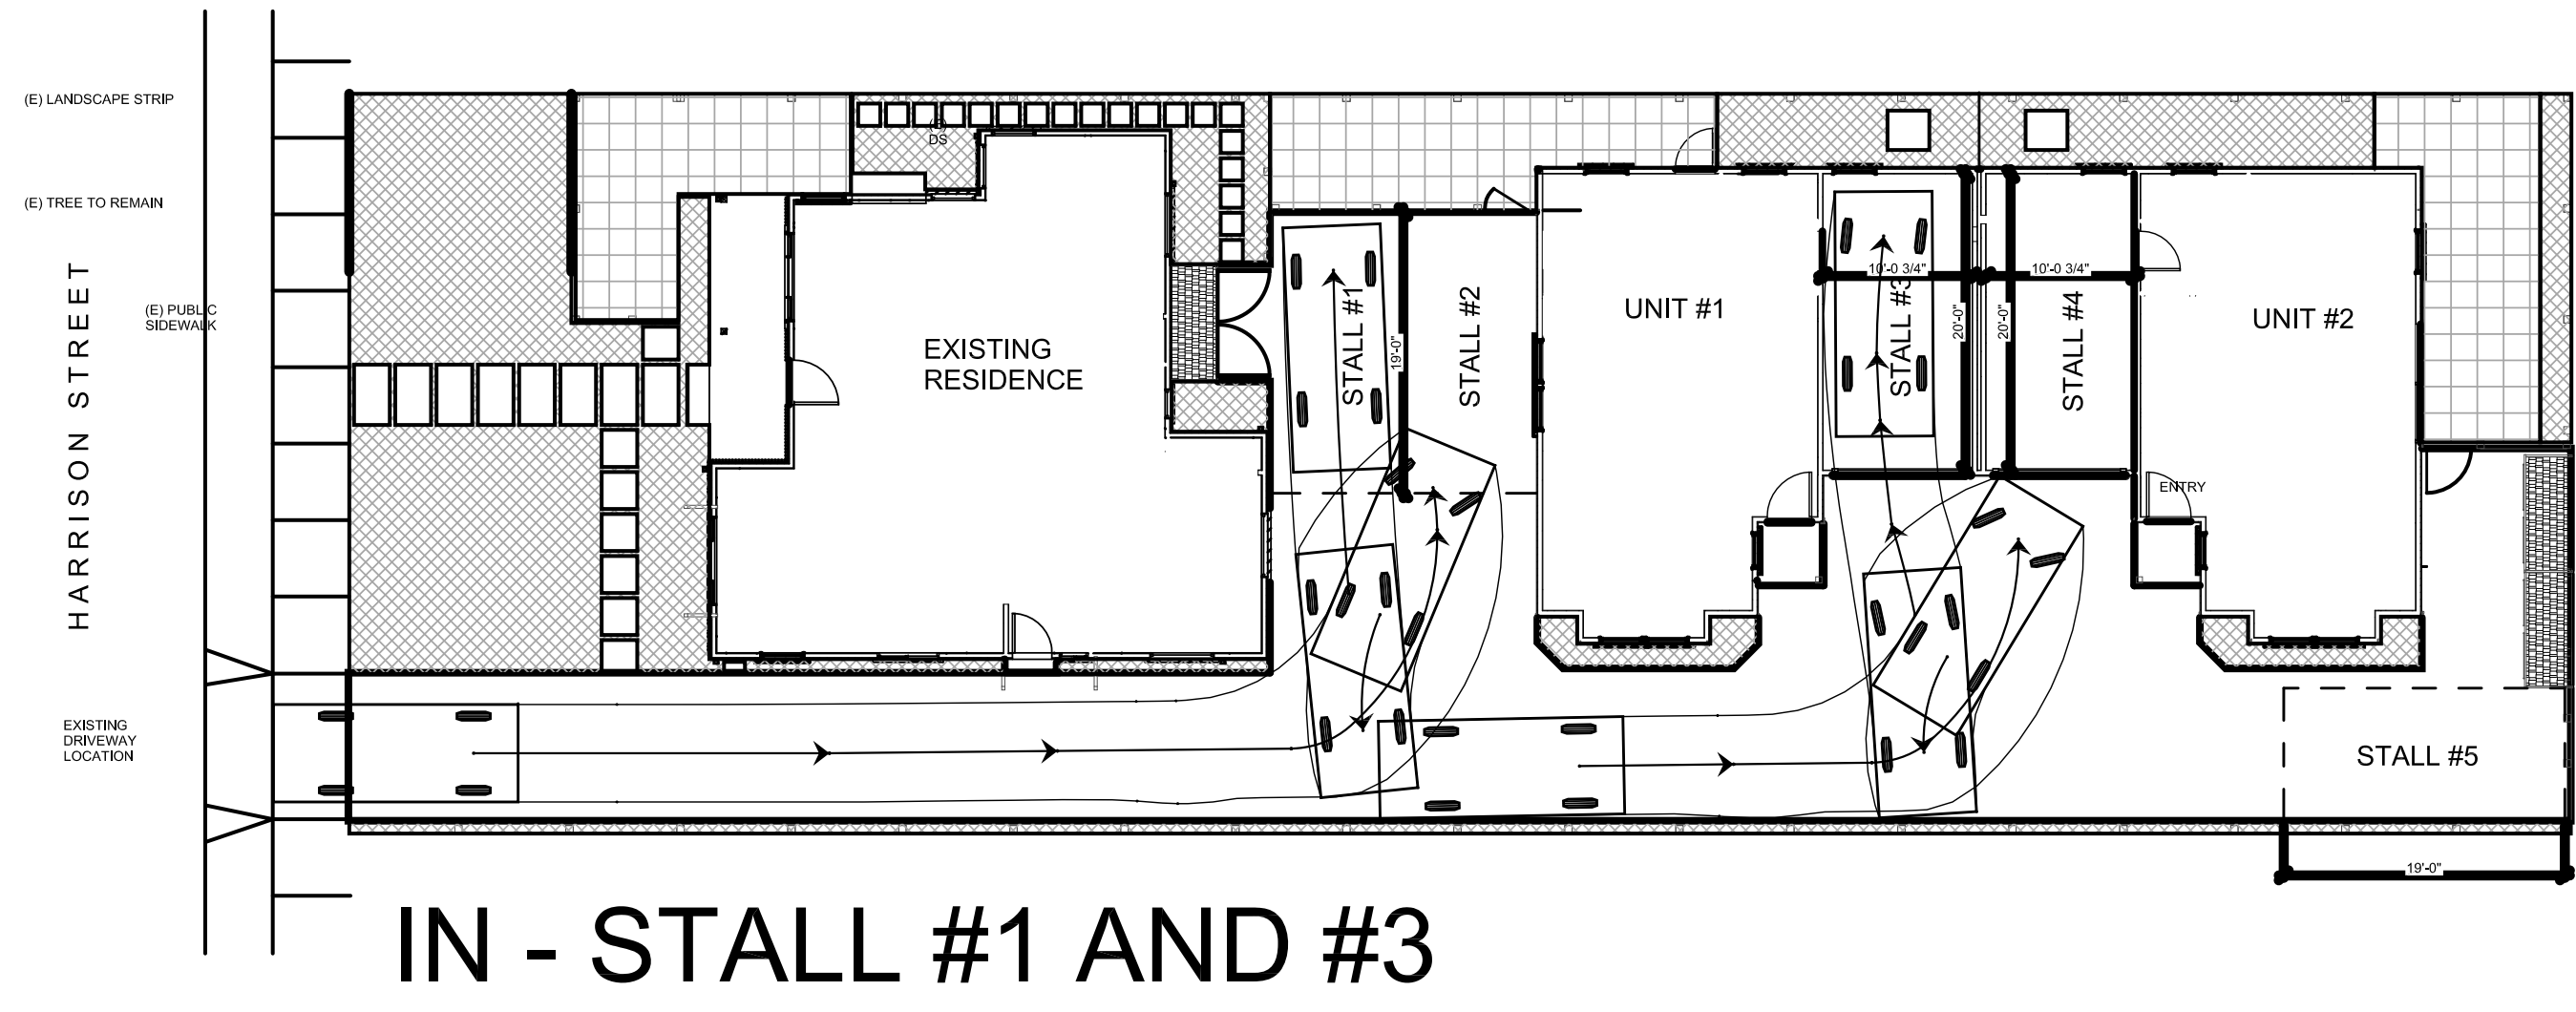


CAR TURNS
 NOT TO SCALE

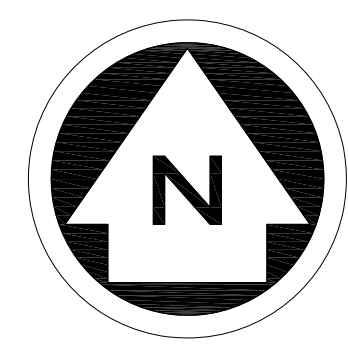


Reference
 North

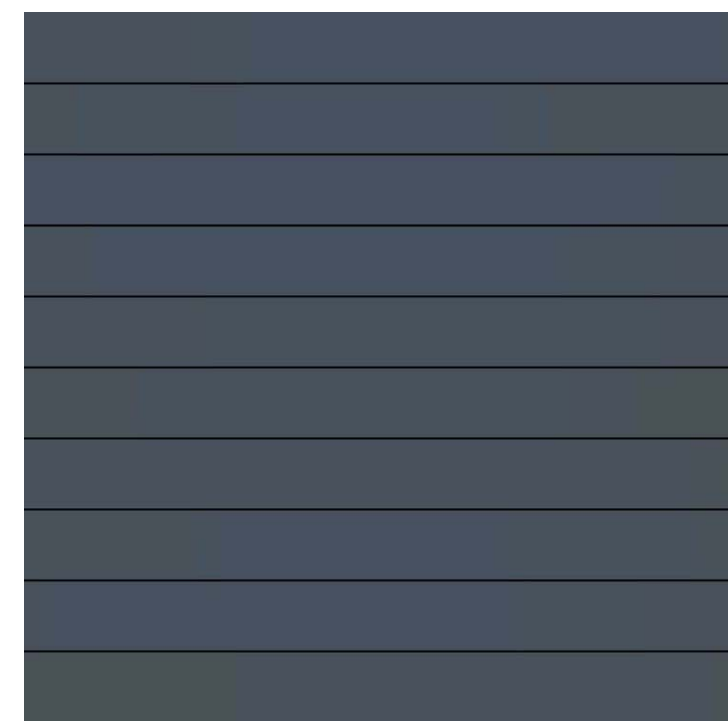

Composite lapped siding
~ smooth texture
Dunn Edwards
DEA189 Black River Falls

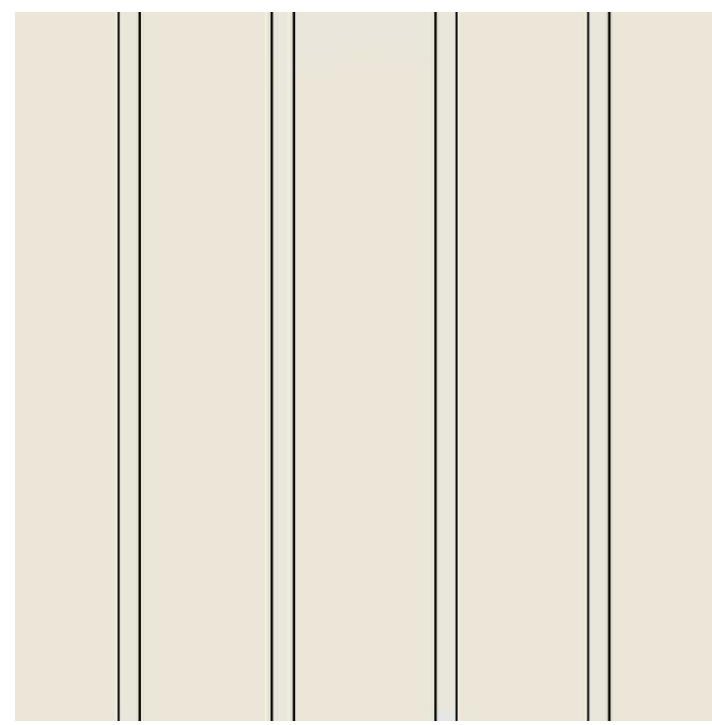

Composite board and batten
siding ~ smooth texture
Dunn Edwards
DEW314 Desert Star

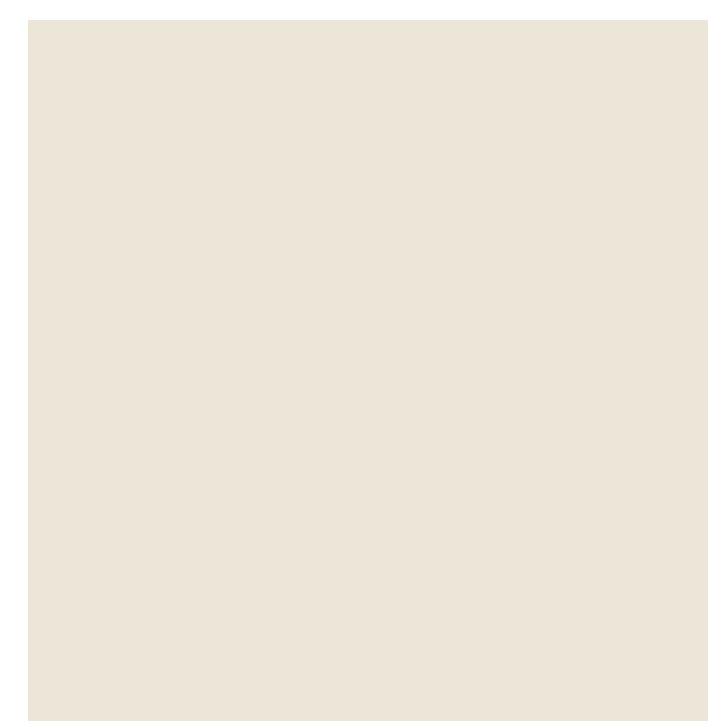


Trim
Dunn Edwards
DEW314 Desert Star



Composition shingle roofing


Color & Materials

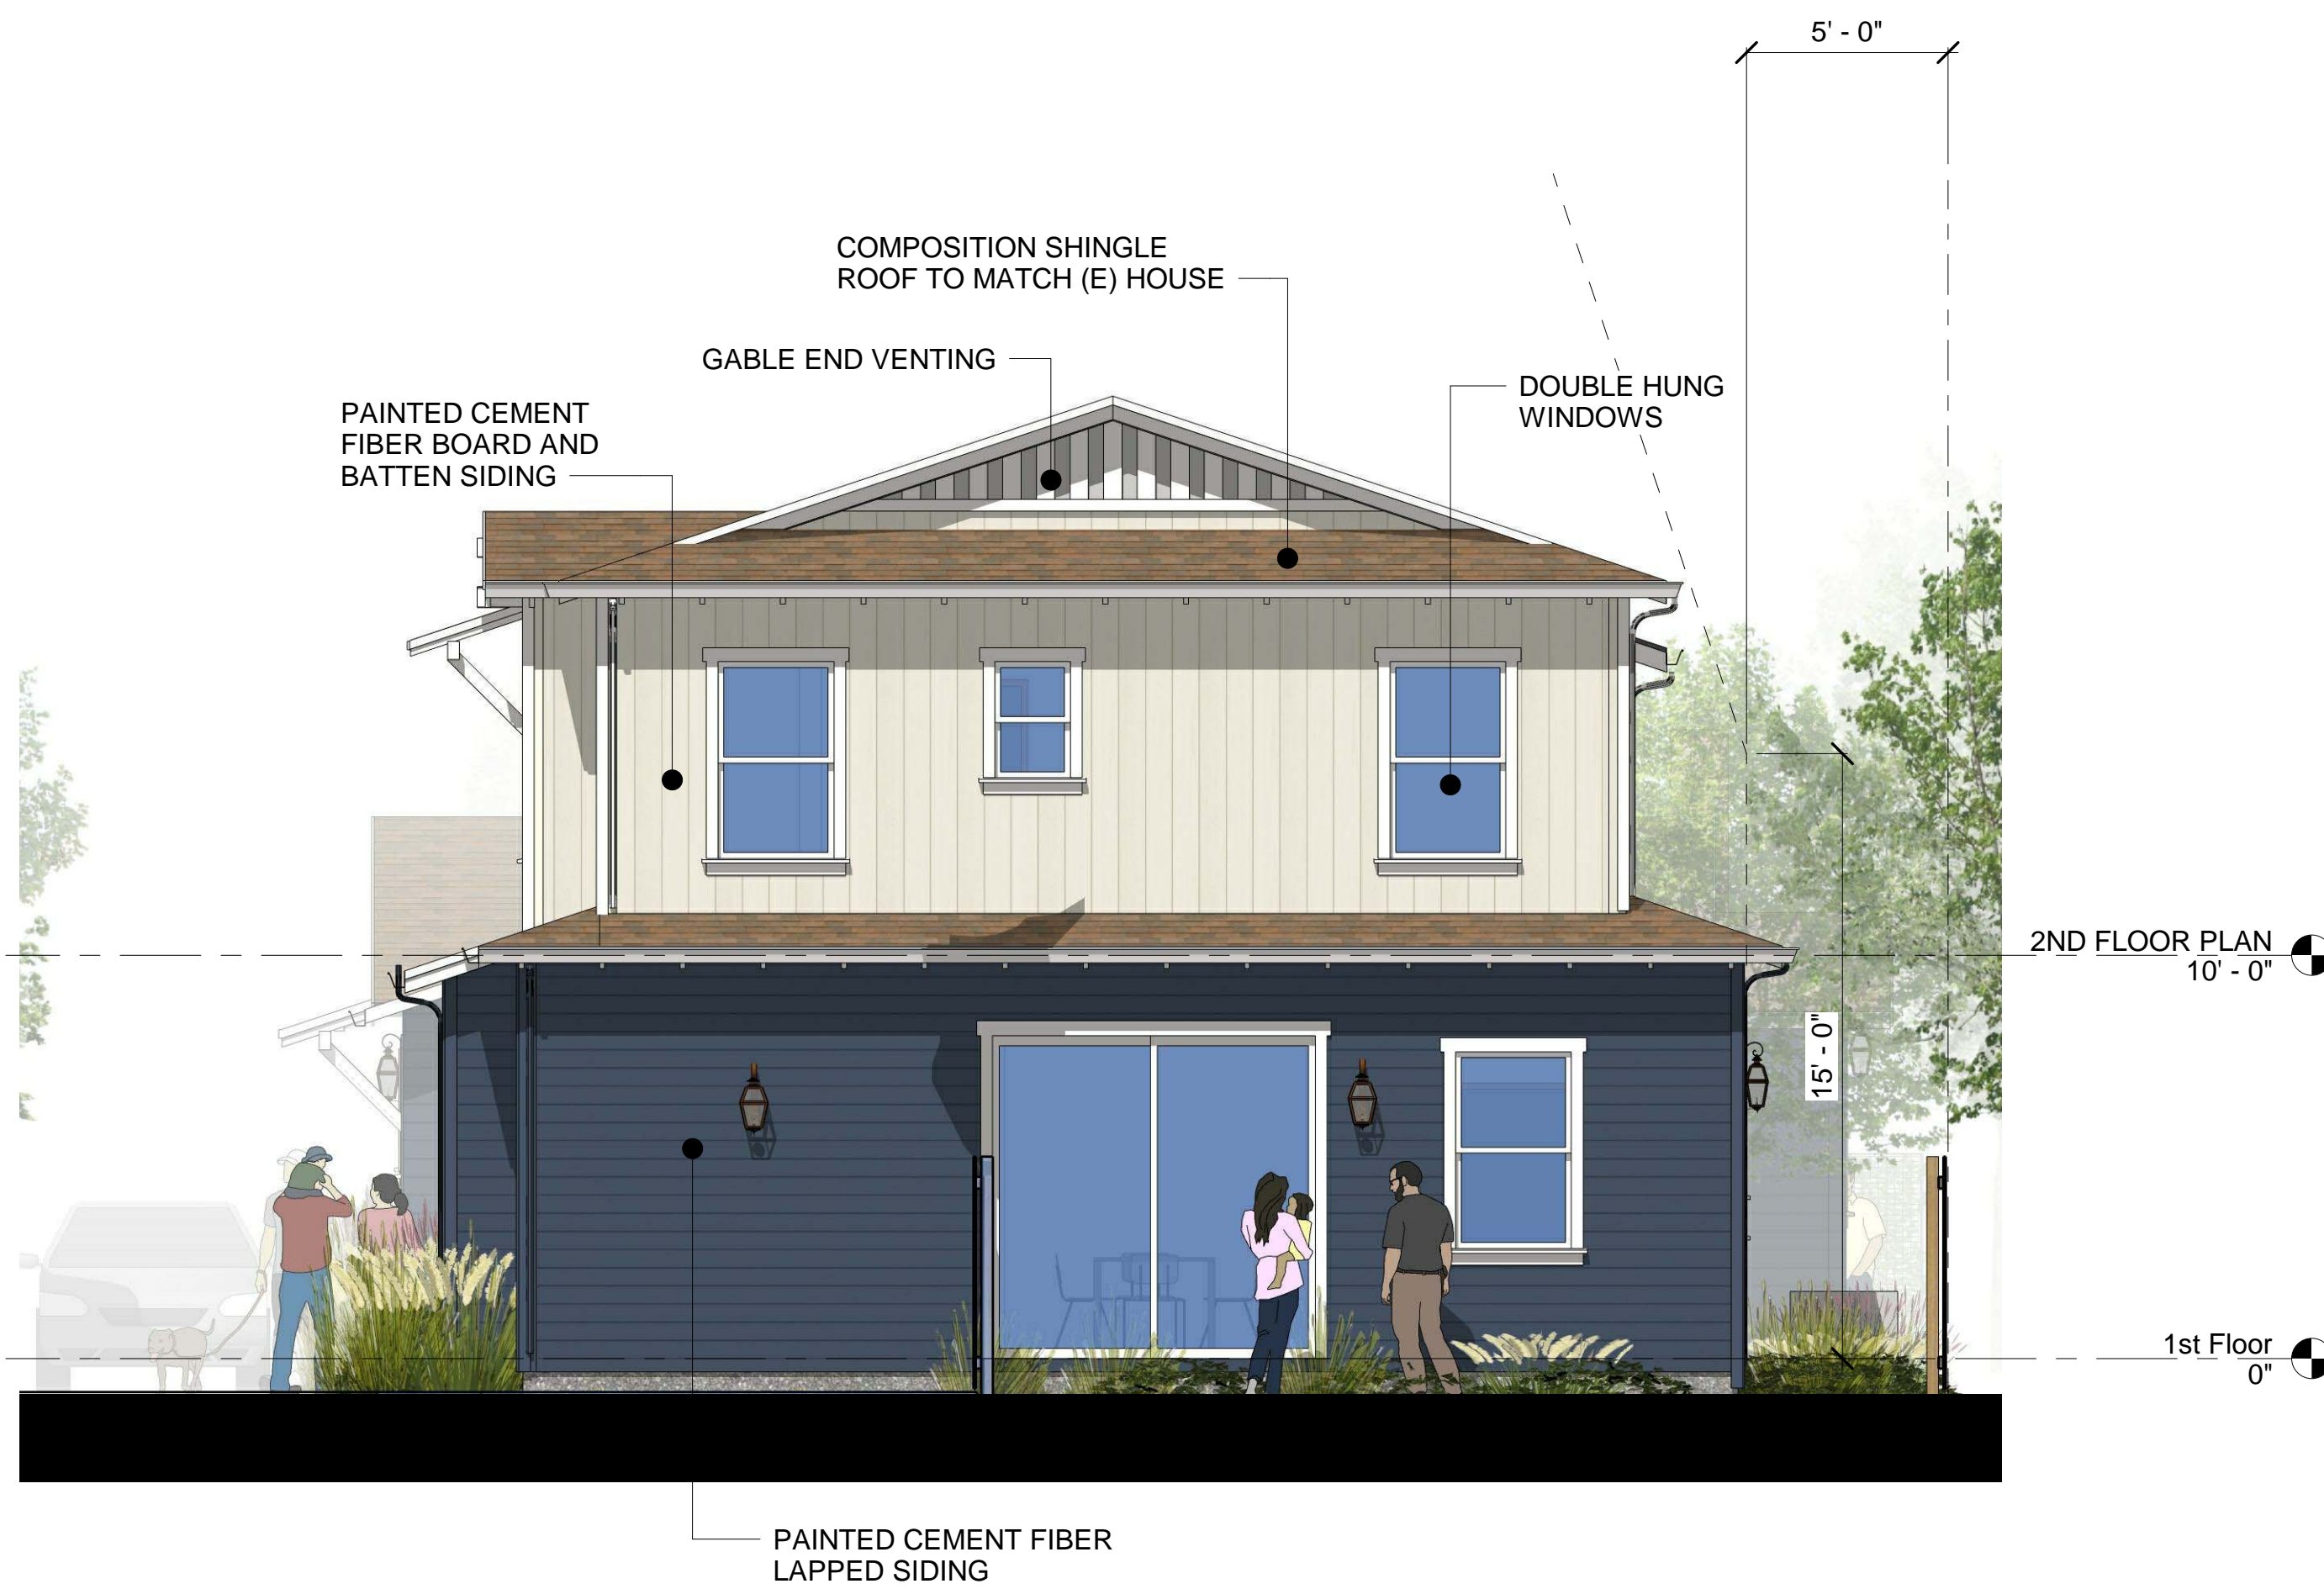

1 EAST ELEVATION
1/4" = 1'-0"



2 PHOTO REAL RENDERING

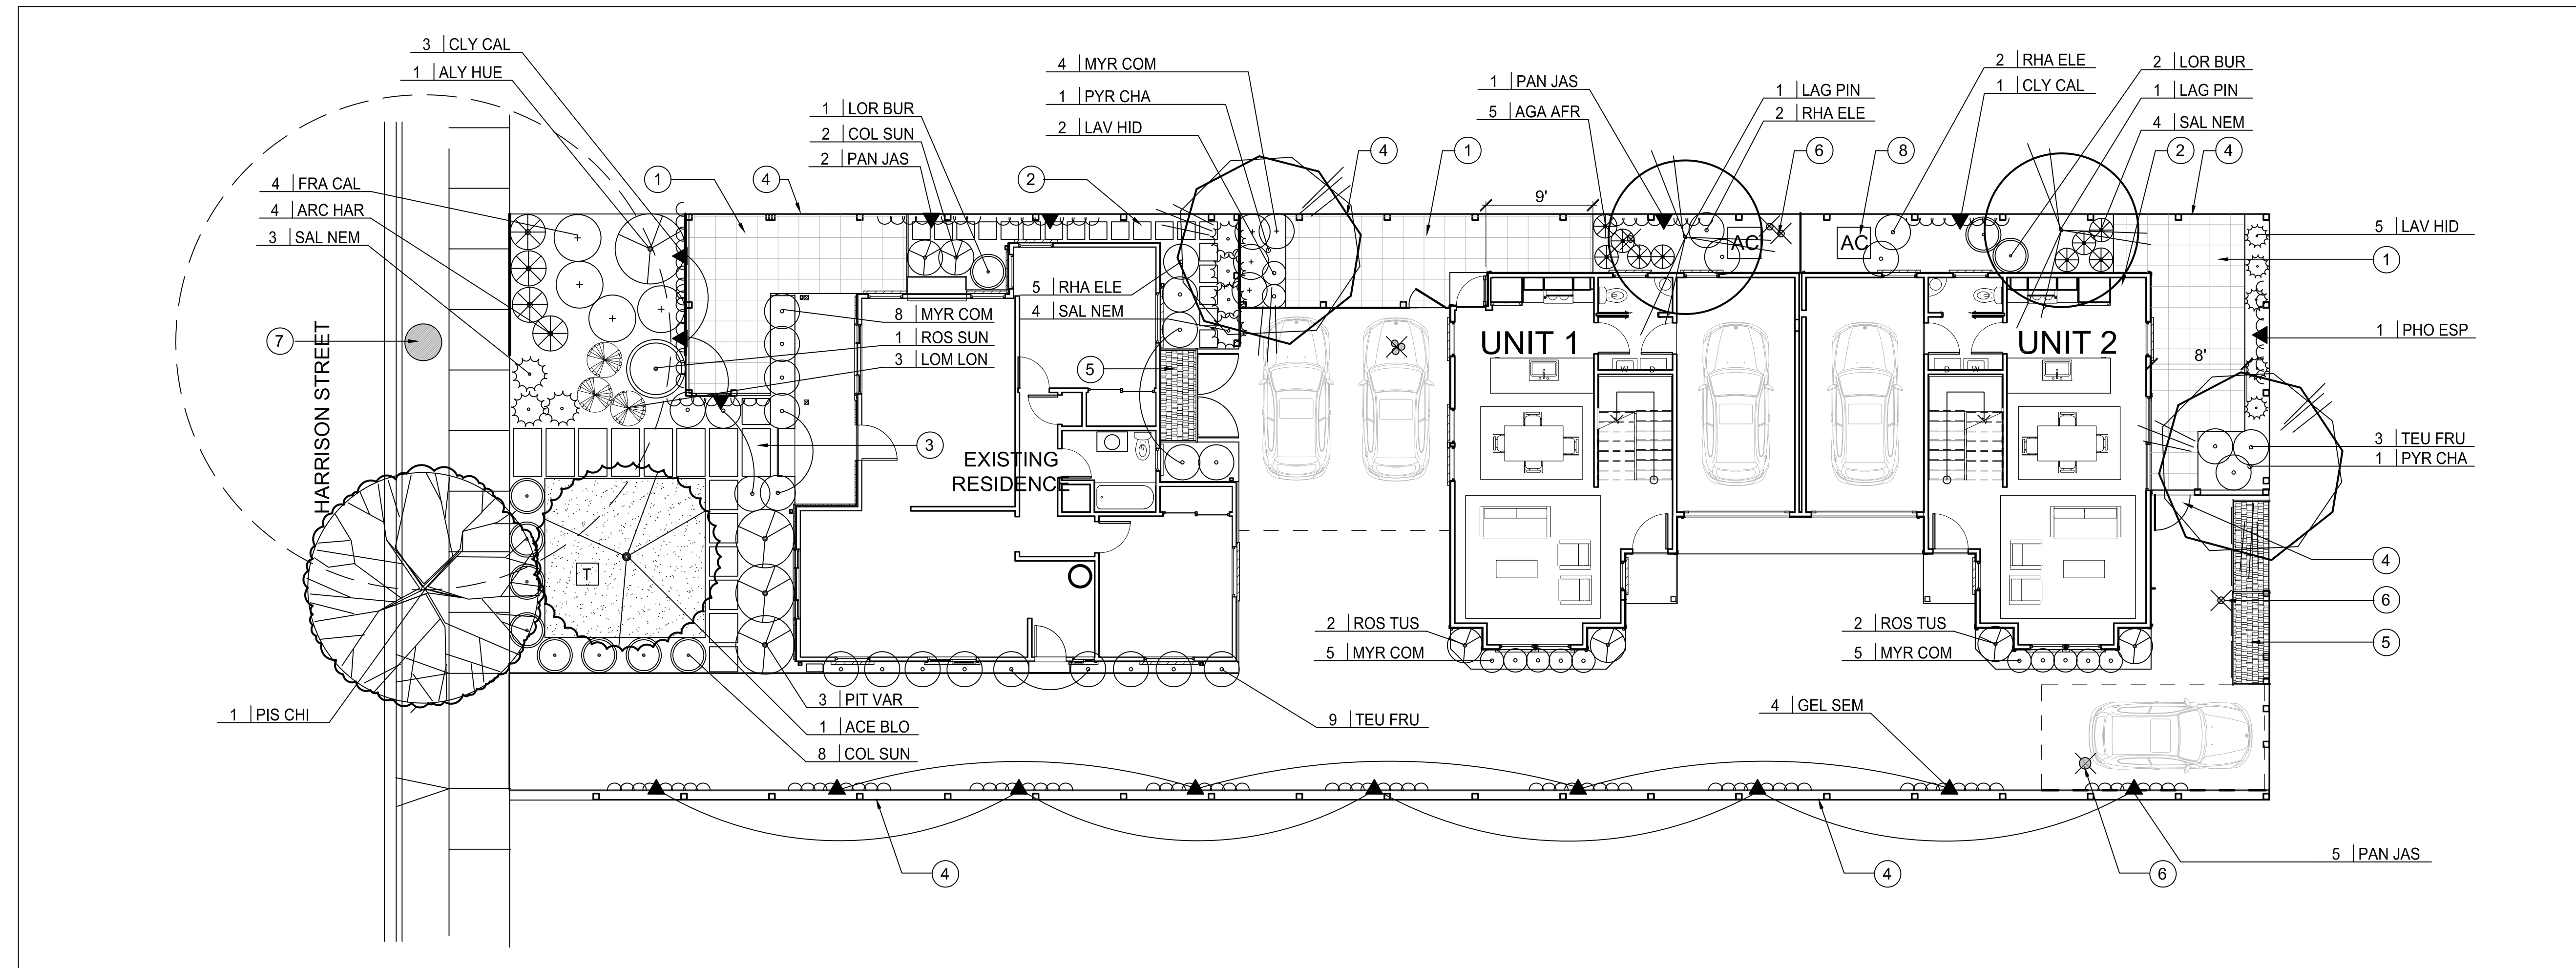


- SITE AMENITIES LIST:**
- ① CONCRETE PAVING: 4" THICK CONCRETE WITH REINFORCING AND BASE MATERIAL PER GEOTECH SOILS REPORT; PROVIDE SAWCUTS (OR 1/4" WIDE x 1/2" DEEP SCORE LINES) AS SHOWN; PROVIDE MEDIUM BROOM FINISH.
 - ② 24" SQ. PRECAST CONCRETE STEPPERS; SEAT SOLID
 - ③ CONCRETE PADS WITH 4" GAPS BETWEEN; PROVIDE REINFORCING AND BASE MATERIAL PER GEOTECH SOILS REPORT PROVIDE; MEDIUM BROOM FINISH.
 - ④ 6 FT. HEIGHT SOLID WOOD FENCE; SEE DETAIL THIS SHEET. PROVIDE HEAVY-DUTY (BLACK METAL) HINGES AND SELF-LATCHING MECHANISM AT 3 FT. WIDE GATES (FENCE DETAIL ON SHEET L2)
 - ⑤ TRASH TOTE ENCLOSURES; REFER TO ARCHITECTURAL DRAWINGS.
 - ⑥ TYPICAL EXISTING TREE TO BE REMOVED; REFER TO ARBORIST REPORT FOR TREE DESCRIPTIONS, TREE REMOVAL/REMAIN STATUS AND ALL TREE PROTECTION MEASURES.
 - ⑦ EXISTING TREE TO REMAIN REFER TO ARBORIST REPORT FOR TREE DESCRIPTIONS, TREE REMOVAL/REMAIN STATUS AND ALL TREE PROTECTION MEASURES.
 - ⑧ PROPOSED A.C. CONDENSER UNITS; ONE FOR EACH PROPOSED RESIDENCE.
 - ⑨ LATTICE SCREEN ON STREET SIDES OF PATIO OF EXISTING RESIDENCE (SEE ARCHITECT'S PLANS)

PLANT MATERIALS

SYMBOL	BOTANICAL NAME	COMMON NAME	SIZE	WATER-USE
TREES:				
ACE BLO	ACER PALMATUM 'BLOODGOOD'	JAPANESE MAPLE	15 GA	MEDIUM
LAG PIN	LAGERSTROEMIA 'PINK VELOUR' (STANDARD)	CRAPE MYRTLE	15 GA	LOW
PIS CHI	PISTACIA CHINENSIS	CHINESE PISTACHE	24" BOX	MEDIUM
PYR CHA	PYRUS CHANTACLEER	FLOWERING PEAR	15 GA	MEDIUM
SHRUBS:				
ALY HUE	ALYOGYNE HUEGII	BLUE HIBISCUS	5 GA	MEDIUM
ARC HAR	ARCTOSTAPHYLOS 'HARMONY'	MANZANITA	5 GA	LOW
COL SUN	COLEONEMA PULCHRUM 'SUNSET GOLD'	BREATH-OF-HEAVEN	5 GA	MEDIUM
FRA CAL	FRANGULA CALIFORNICA 'EVE CASE'	COFFEEBERRY	5 GA	LOW
LOR BUR	LOROPETALUM CHINENSIS 'BURGUNDY'	FRINGE FLOWER	5 GA	LOW
MYR COM	MYRTUS COMMUNIS 'COMPACTA'	DWARF MYRTLE	5 GA	LOW
PIT VAR	PITTOSPORUM T. 'VARIEGATA'	VARIEGATED TOBIRA	5 GA	LOW
RHA ELE	RHAPHIOLEIS INDICA 'ELEANOR TABOR'	INDIAN HAWTHORN	5 GA	LOW
ROS SUN	ROSA 'SUNNY KNOCK OUT' (STANDARD)	ROSE	5 GA	MEDIUM
ROS TUS	ROSMARINUS 'TUSCANY'	TUSCAN BLUE ROSEMARY	5 GA	LOW
SAL NEM	SALVIA NEMEROSA 'OSTFRIESLAND'	PURPLE SAGE	5 GA	LOW
PERENNIALS & GRASSES:				
AGA AFR	AGAPANTHUS AFRICANUS	LILY-OF-THE-NILE	1 GA	MEDIUM
LAV HID	LAVANDULA A. 'HIDCOTE'	ENGLISH LAVENDER	1 GA	LOW
LOM LON	LOMANDRA LONGIFOLIA 'BREEZE'	MAT RUSH	1 GA	LOW
TEU FRU	TEUCRIUM FRUTICANS 'COMPACTUM'	DWARF GERMANDER	1 GA	LOW
ESPALEERS:				
CLY CAL	CLYTOSTOMA CALLESTEGIOIDES	LAVENDER TRUMPET VINE	5 GA	MEDIUM
GEL SEM	GELSEMIUM SEMPERVIRENS	CAROLINA JESSAMINE	5 GA	LOW
PAN JAS	PANDOREA JASMINOIDES	BOWER VINE	5 GA	MEDIUM
PHO ESP	PHOTINIA FRASERI	PHOTINIA	5 GA	MEDIUM
T	DWARF TALL FESCUE SOD	ROLLS		HIGH

- GENERAL NOTES:**
1. ALL PLANTING TO BE IRRIGATED BY A SINGLE, FULLY AUTOMATIC, WATER-CONSERVING IRRIGATION SYSTEM, BASED ON WEATHER-OPERATION, CONNECTED TO DOMESTIC WATER SUPPLY; APPLICATION TO BE DRIP AND BUBBLERS.
 2. ALL PROPOSED PLANTED AREAS ARE TO RECEIVE A 3" LAYER OF FIRBARK MULCH DRESSING.
 3. REFER TO ARBORIST REPORT AND CIVIL DRAWINGS FOR ALL EXISTING TREE DESCRIPTIONS, EXISTING TREE REMOVAL/REMAIN STATUS, AND ALL EXISTING TREE PROTECTION MEASURES.

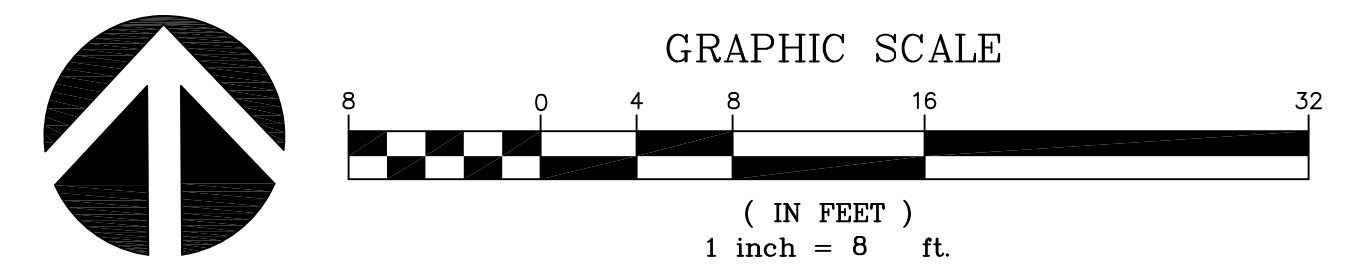

REFER TO SHEET L2 FOR DETAILS AND IRRIGATION CALCS

REVISIONS

Thomas Baak & Associates, LLP
 Landscape Architects
 1620 North Main Street, Suite 4
 Walnut Creek, CA 94596
 Ph: 925.933.2583

NEW APARTMENTS
 4722 HARRISON STREET
 PLEASANTON, CALIFORNIA

PRELIMINARY
 LANDSCAPE
 PLAN

DESIGNED: RS	DRAWN: KD
CHECKED:	JOB NO:
DATE 03-19-18	
SCALE NOTED	

SHEET
 L1
 OF 2 SHEETS

WATER EFFICIENT LANDSCAPE WORKSHEET-EXISTING RESIDENCE

REFERENCE EVAPOTRANSPIRATION (Eto): 46.2

HYDROZONE / PLANTING DESCRIPTION	PLANT FACTOR (PF)	IRRIGATION METHOD	IRRIGATION EFFICIENCY (IE)	ETAF (PF / IE)	LANDSCAPE AREA (sq. ft.)	ETAF x AREA	ESTIMATED TOTAL WATER USE (ETWU)
REGULAR LANDSCAPE AREAS:							
LOW WATER USE	0.3	DRIP	0.81	0.3703703	479	177.4073737	5081.7
MEDIUM WATER USE	0.5	DRIP	0.81	0.6172839	222	137.0370258	3925.3
MEDIUM WATER USE	0.5	BUBBLER	0.81	0.6172839	18	11.1111102	318.3
HIGH WATER USE	0.7	SPRAY	0.75	0.9333333	176	164.2666608	4705.3
TOTALS:					895	490	
SPECIAL LANDSCAPE AREAS:							
REC. AREA				0	0	0	0
WATER FEATURE 1				0	0	0	0
WATER FEATURE 2				0	0	0	0
TOTALS:					0	0	
						ETWU TOTAL:	14,030
MAXIMUM ALLOWED WATER ALLOWANCE (MAWA):							14,100

ETAF CALCULATIONS:

REGULAR LANDSCAPE AREAS:

TOTAL ETAF x AREA	490
TOTAL LANDSCAPE AREA	895
AVERAGE ETAF	0.55

NOTE: AVERAGE ETAF FOR REGULAR LANDSCAPE AREAS MUST BE 0.55 OR BELOW FOR RESIDENTIAL AREAS, AND 0.45 OR BELOW FOR NON-RESIDENTIAL AREAS.

ALL LANDSCAPE AREAS:

TOTAL ETAF x AREA	490
TOTAL LANDSCAPE AREA	895
SITEWIDE ETAF	0.55

WATER EFFICIENT LANDSCAPE WORKSHEET-UNIT 1 & 2

REFERENCE EVAPOTRANSPIRATION (Eto): 46.2

HYDROZONE / PLANTING DESCRIPTION	PLANT FACTOR (PF)	IRRIGATION METHOD	IRRIGATION EFFICIENCY (IE)	ETAF (PF / IE)	LANDSCAPE AREA (sq. ft.)	ETAF x AREA	ESTIMATED TOTAL WATER USE (ETWU)
REGULAR LANDSCAPE AREAS:							
LOW WATER USE	0.3	DRIP	0.81	0.3703703	288	106.666464	3055.4
MEDIUM WATER USE	0.5	DRIP	0.81	0.6172839	98	60.4938222	1732.8
MEDIUM WATER USE	0.5	BUBBLER	0.81	0.6172839	36	22.2222204	636.5
TOTALS:					422	189	
SPECIAL LANDSCAPE AREAS:							
REC. AREA				0	0	0	0
WATER FEATURE 1				0	0	0	0
WATER FEATURE 2				0	0	0	0
TOTALS:					0	0	
						ETWU TOTAL:	5,425
MAXIMUM ALLOWED WATER ALLOWANCE (MAWA):							6,648

ETAF CALCULATIONS:


REGULAR LANDSCAPE AREAS:

TOTAL ETAF x AREA	189
TOTAL LANDSCAPE AREA	422
AVERAGE ETAF	0.45

NOTE: AVERAGE ETAF FOR REGULAR LANDSCAPE AREAS MUST BE 0.55 OR BELOW FOR RESIDENTIAL AREAS, AND 0.45 OR BELOW FOR NON-RESIDENTIAL AREAS.

ALL LANDSCAPE AREAS:

TOTAL ETAF x AREA	189
TOTAL LANDSCAPE AREA	422
SITEWIDE ETAF	0.45

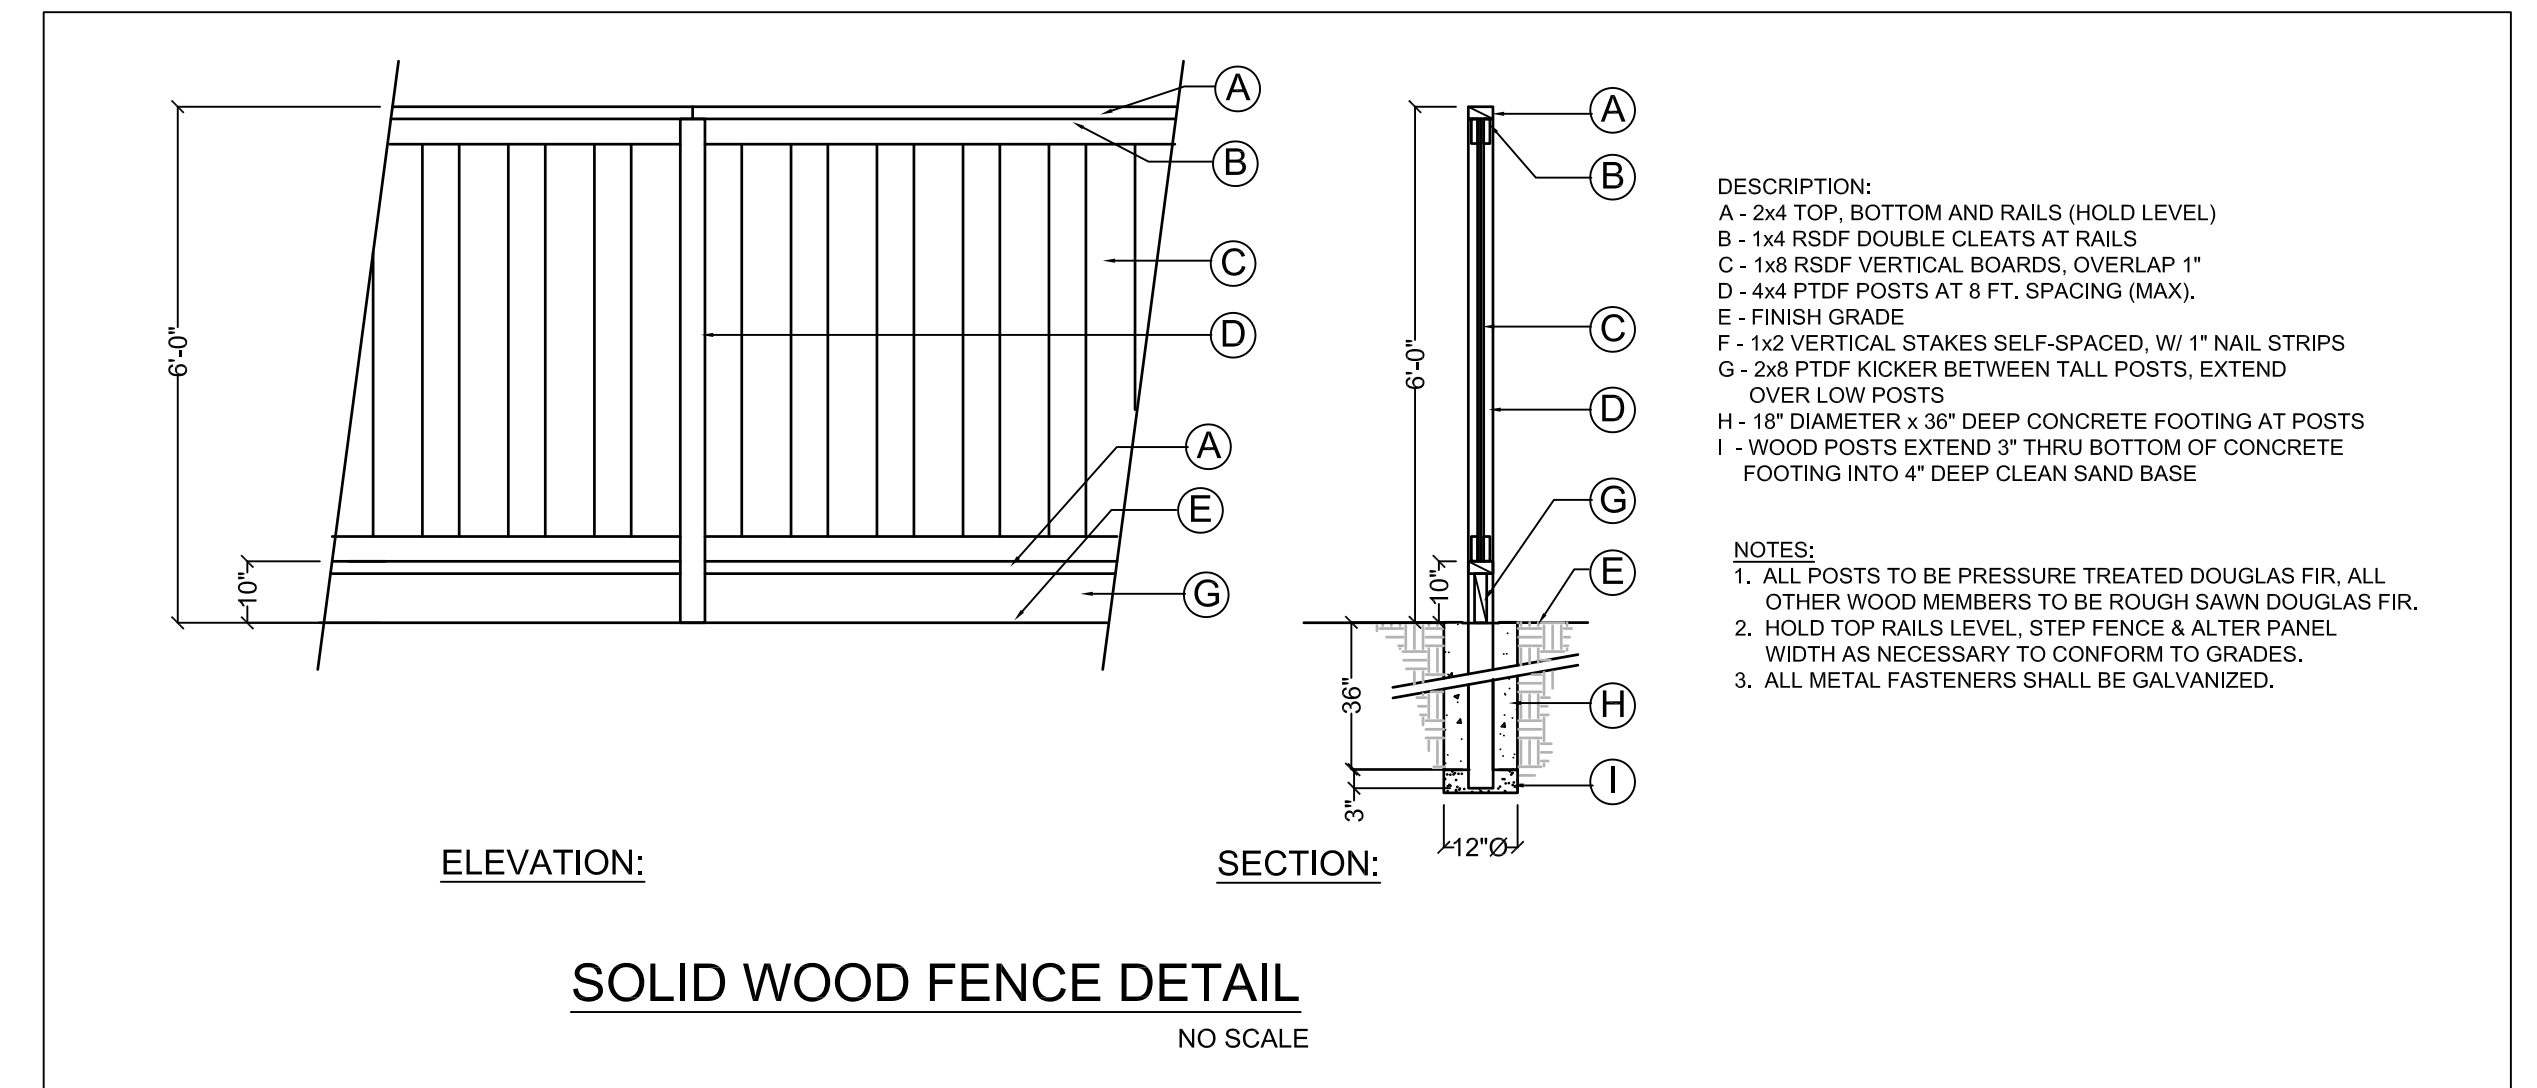

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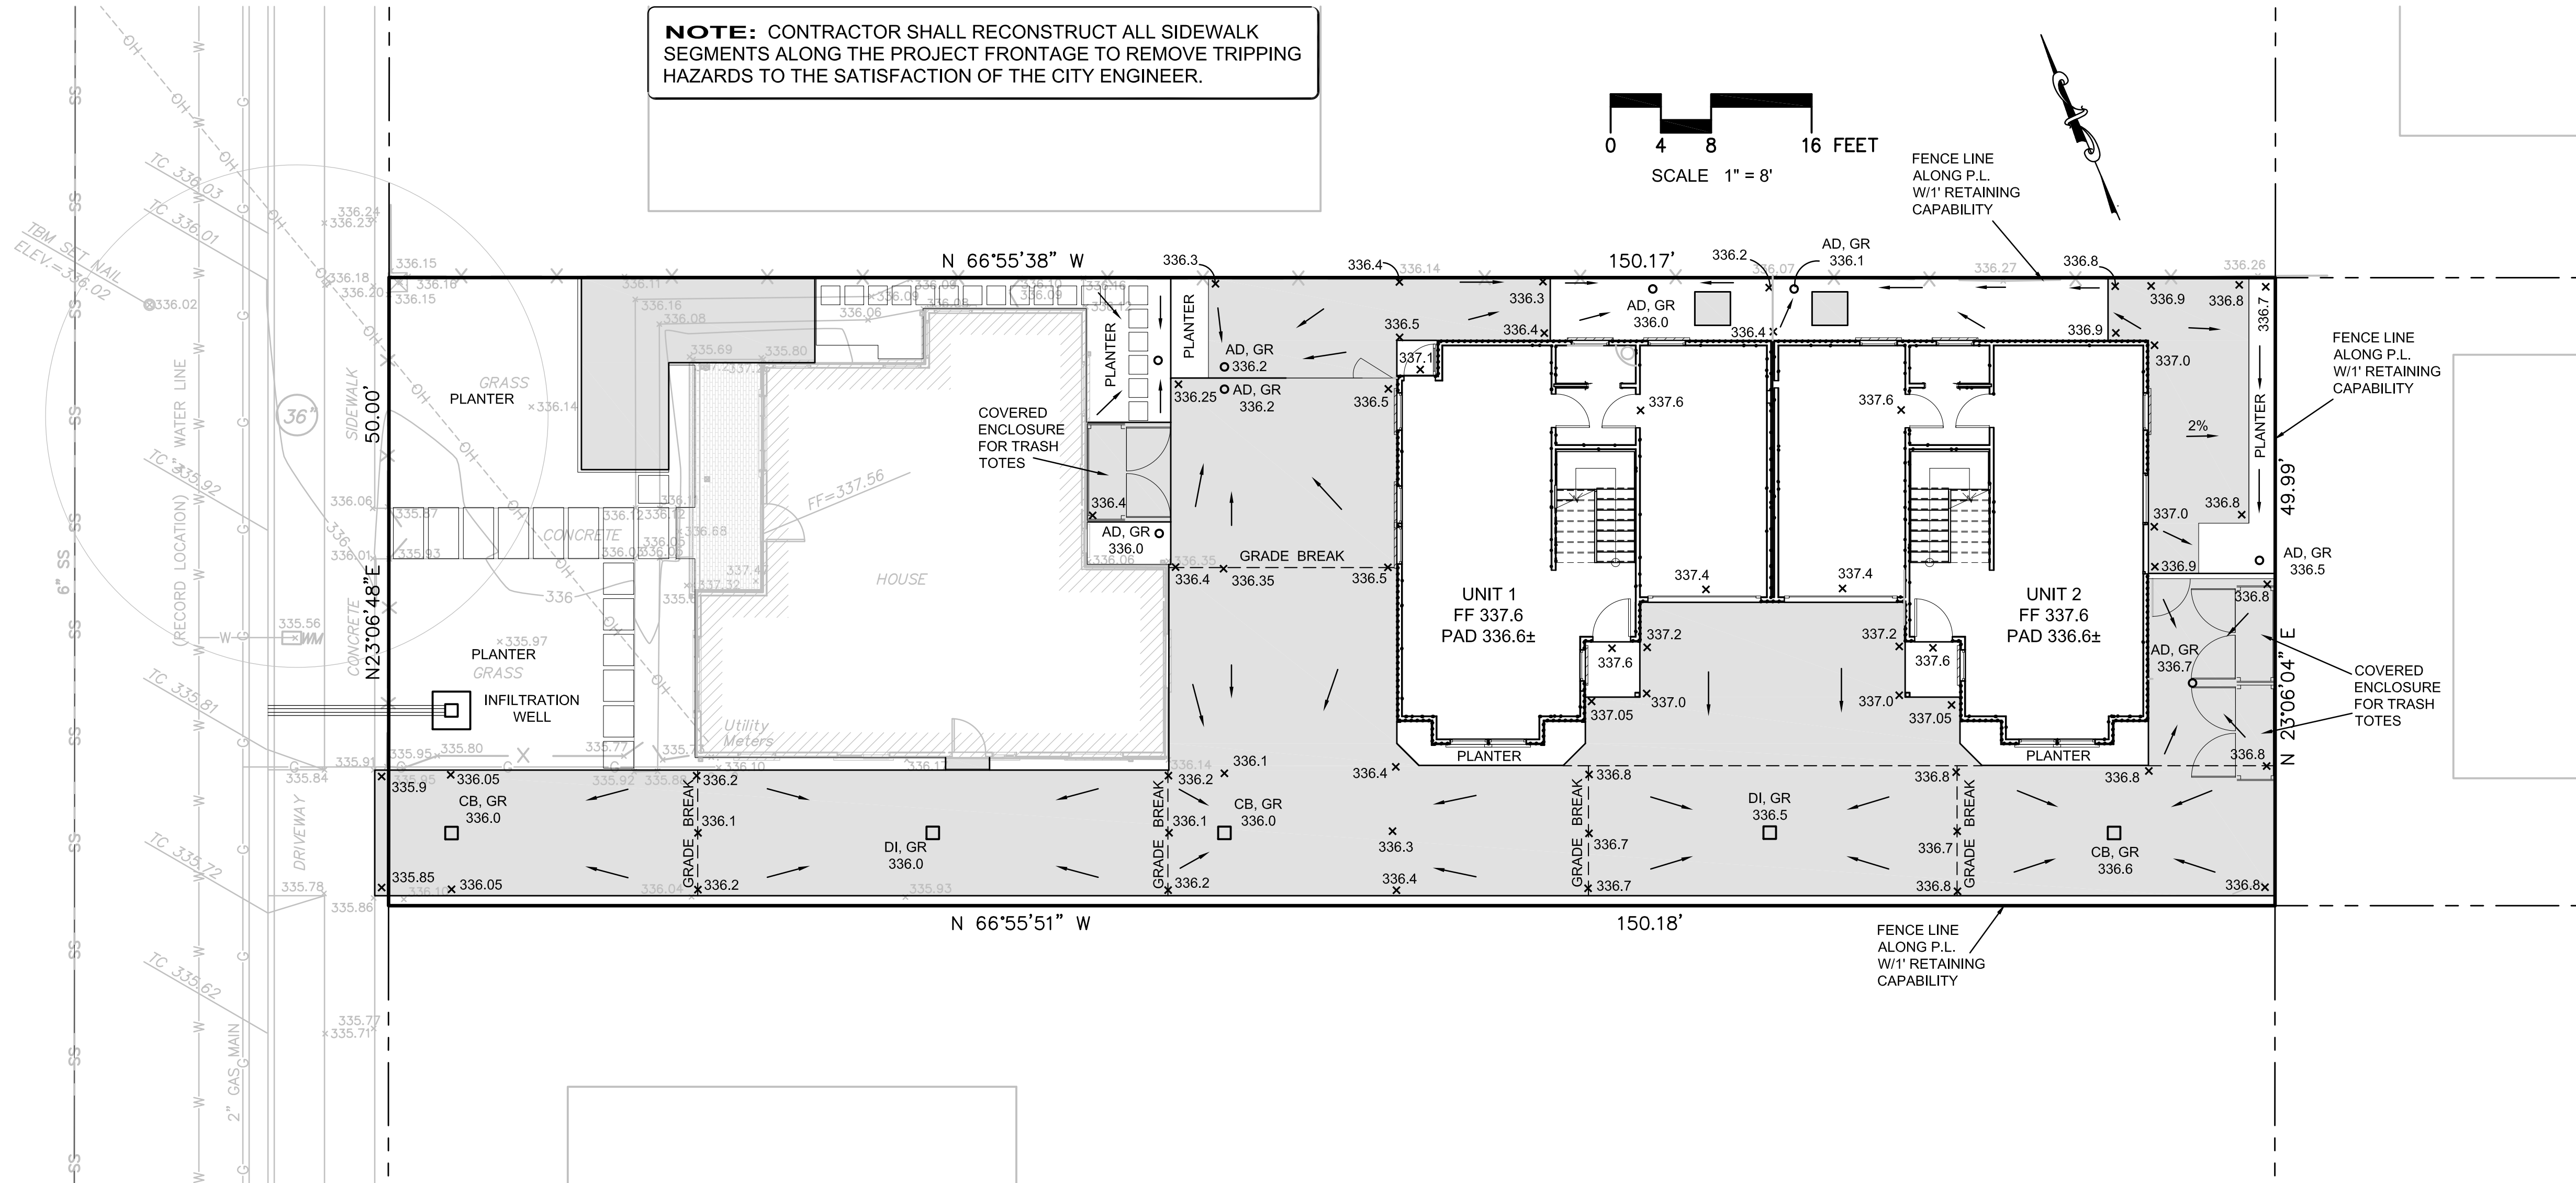
NEW APARTMENTS
 4722 HARRISON STREET
 PLEASANTON, CALIFORNIA

DETAILS AND
 CALCULATIONS


DESIGNED: RS	DRAWN: KD
CHECKED:	JOB NO:
DATE 03-19-18	
SCALE NOTED	

SHEET
L2
 OF 2 SHEETS

HARRISON STREET
50.0' R/W



NOTE: CONTRACTOR SHALL RECONSTRUCT ALL SIDEWALK SEGMENTS ALONG THE PROJECT FRONTAGE TO REMOVE TRIPPING HAZARDS TO THE SATISFACTION OF THE CITY ENGINEER.


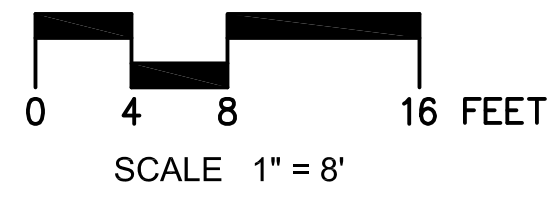


LEGEND

EXISTING	PROPOSED	DESCRIPTION
—	—	PROPERTY LINE
—	—	JOINT POLE
—SS—	—SS—	SANITARY SEWER LINE
—SD—	—SD—	STORM DRAIN LINE
—W—	—W—	STORM DRAIN TIE TO DOWNSPOUT
—	—	WATER LINE
—JT—	—JT—	JOINT TRENCH
—	—	DRAIN INLET/CATCH BASIN
—	—	FIRE HYDRANT
—	—	FORCED MAIN
—	—	JOINT TRENCH
—	—	WATER MAIN & GATE VALVE
—	—	SPOT ELEVATION
—	—	OVERHEAD UTILITY
—	—	SIGN
—	—	EXISTING TREE
—	—	STANDARD CITY MONUMENT
—	—	WATER SERVICES & METER
—	—	ELECTRIC BOX
—	—	STREET LIGHT
—	—	PG&E BOX
—	—	CABLE TELEVISION BOX

ABBREVIATIONS

AB	AGGREGATE BASE	LD	LANDSCAPE DRAIN
AC	ASPHALT CONCRETE	LG	LIP OF GUTTER
AD	AREA DRAIN	LP	LOW POINT
APPROX	APPROXIMATE	LT	LEFT
BC	BEGINNING OF CURVE	MH	MANHOLE
BCC	BEGIN OF COMPOUND CURVE	MON	MONUMENT
BFP	BACKFLOW PREVENTOR	N.T.S.	NOT TO SCALE
BJT	BOTTOM JOINT TRENCH ELEV.	PCC	PORTLAND CEMENT CONCRETE
BM	BENCH MARK	PERF	PERFORATED SUBDRAIN
BO	BLOWOFF	PRC	POINT OF REVERSE CURVE
BOV	BLOWOFF VALVE	PROP	PROPOSED
BVC	BEGIN VERTICAL CURVE	PT	POINT
BW	BOTTOM OF WALL ELEVATION	PUE	PUBLIC UTILITY EASEMENT
BWK	BACK OF WALK	PVC	POLYVINYL CHLORIDE
CB	CATCH BASIN	PVI	POINT OF VERTICAL INTERSECTION
CL	CENTERLINE	R	RADIUS
CO	CLEANOUT	RCP	REINFORCED CONCRETE PIPE
CONC	CONCRETE	RIM	RIM ELEVATION
DI	DRAIN INLET	RP	REDUCED PRESSURE
DGD	DOUBLE CHECK DETECTOR	RT	RIGHT
DWY	DRIVEWAY	RW	RIGHT OF WAY
E	ELECTRIC	SD	STORM DRAIN
EC	END OF CURVE	SHT	SHEET
EF	ENTRY FINISH FLOOR	SL	STREET LIGHT
ELEV	ELEVATION	SRV	SERVICE
EP	EDGE OF PAVEMENT	SS	SANITARY SEWER
EVC	END VERTICAL CURVE	SSE	SANITARY SEWER EASEMENT
EX	EXISTING	ST	STREET
FC	FACE OF CURB	STA	STATION
FD	FLOOR DRAIN	STD	STANDARD
FF	FINISHED FLOOR ELEVATION	SW	SIDEWALK
FG	FINISHED GRADE	T	TELEPHONE
FH	FIRE HYDRANT	TC	TOP OF CURB
FL	FLOW LINE	TEMP	TEMPORARY
FS	FINISHED SURFACE	TJT	TOP OF JOINT TRENCH UTILITY ELEV.
G	GAS	TS	TOP OF SOIL
GB	GRADE BREAK	TW	TOP OF WALL ELEVATION
HC	HANDICAP	TYP	TYPICAL
HP	HIGH POINT	VC	VERTICAL CURVE
INV	INVERT	W	WATER LINE
IRR	IRRIGATION	WM	WATER MAIN
JT	JOINT TRENCH	WV	WATER VALVE

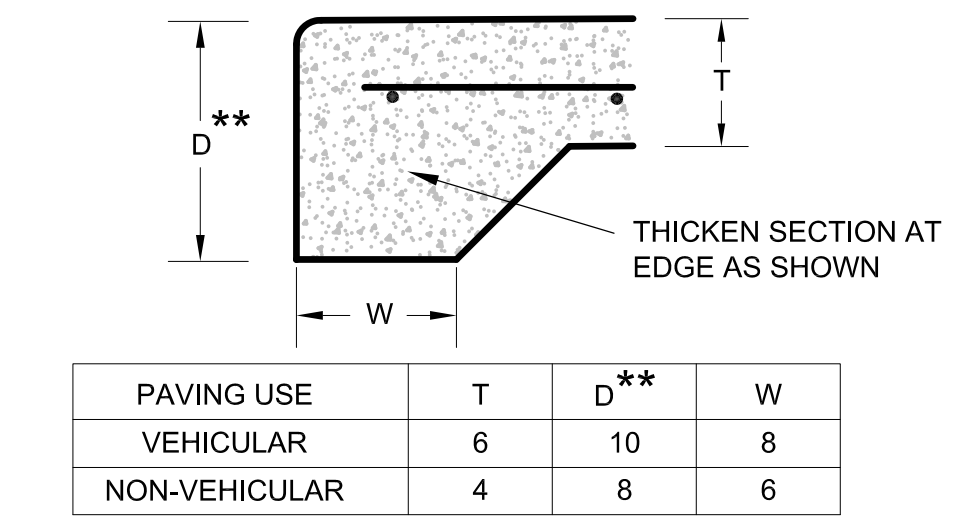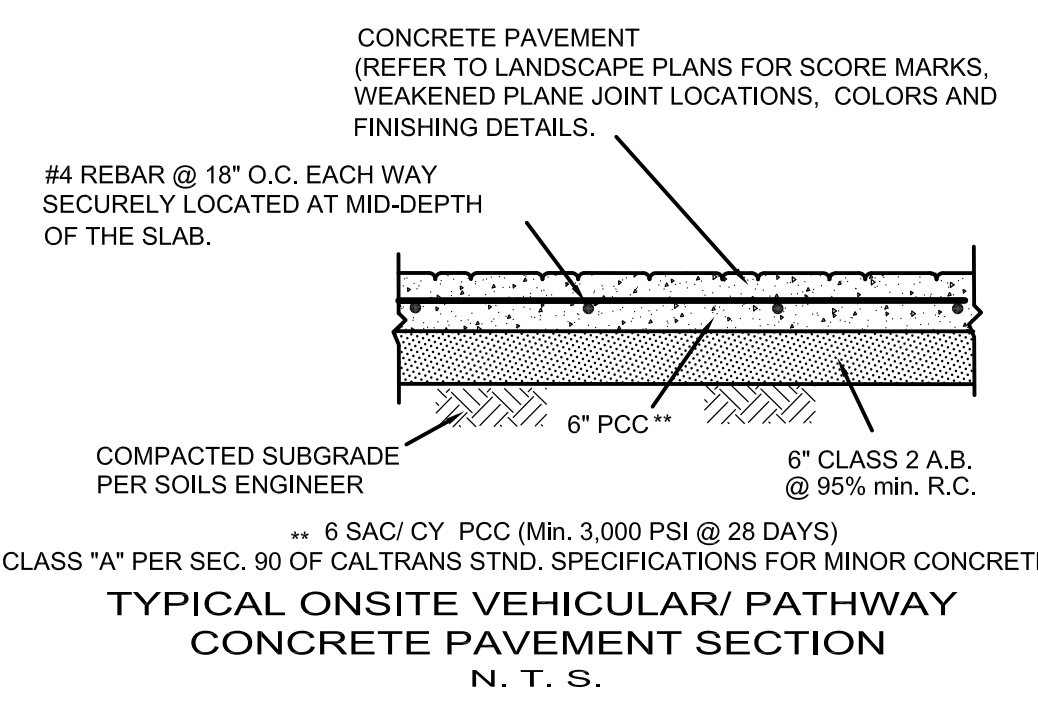

EARTH QUANTITIES:
EARTH QUANTITIES TO BE VERIFIED BY CONTRACTOR
CUT 20± CU. YDS.
FILL 25± CU. YDS.

AREA DISTURBED:
4,800± SF (±0.11 ACRE)

** UNLESS OTHERWISE NOTED ON PLANS
THICKENED CONCRETE PAVING EDGE
N. T. S.



PRELIMINARY GRADING AND DRAINAGE PLAN
WINSLOW PROPERTY
APN 094-0155-020 - LOT 83 (10 M 60)
4722 HARRISON STREET
PLEASANTON CALIFORNIA

HUMANN COMPANY INC.
ENGINEERING - SURVEYING
10000 W. 14TH AVE., SUITE 200
DENVER, CO 80202
PH (303) 255-5000 FAX (303) 255-8576

REVISIONS


SCALE	DATE	ENGINEER	H. N.	JOB NO.
1"=8"	02/21/18			17090

SHEET **C01**
OF 4 SHEETS

IZZAT S. NASHASHIBI R.C.E. 29528

JOB NO. 17090

HARRISON STREET
50.0' R/W

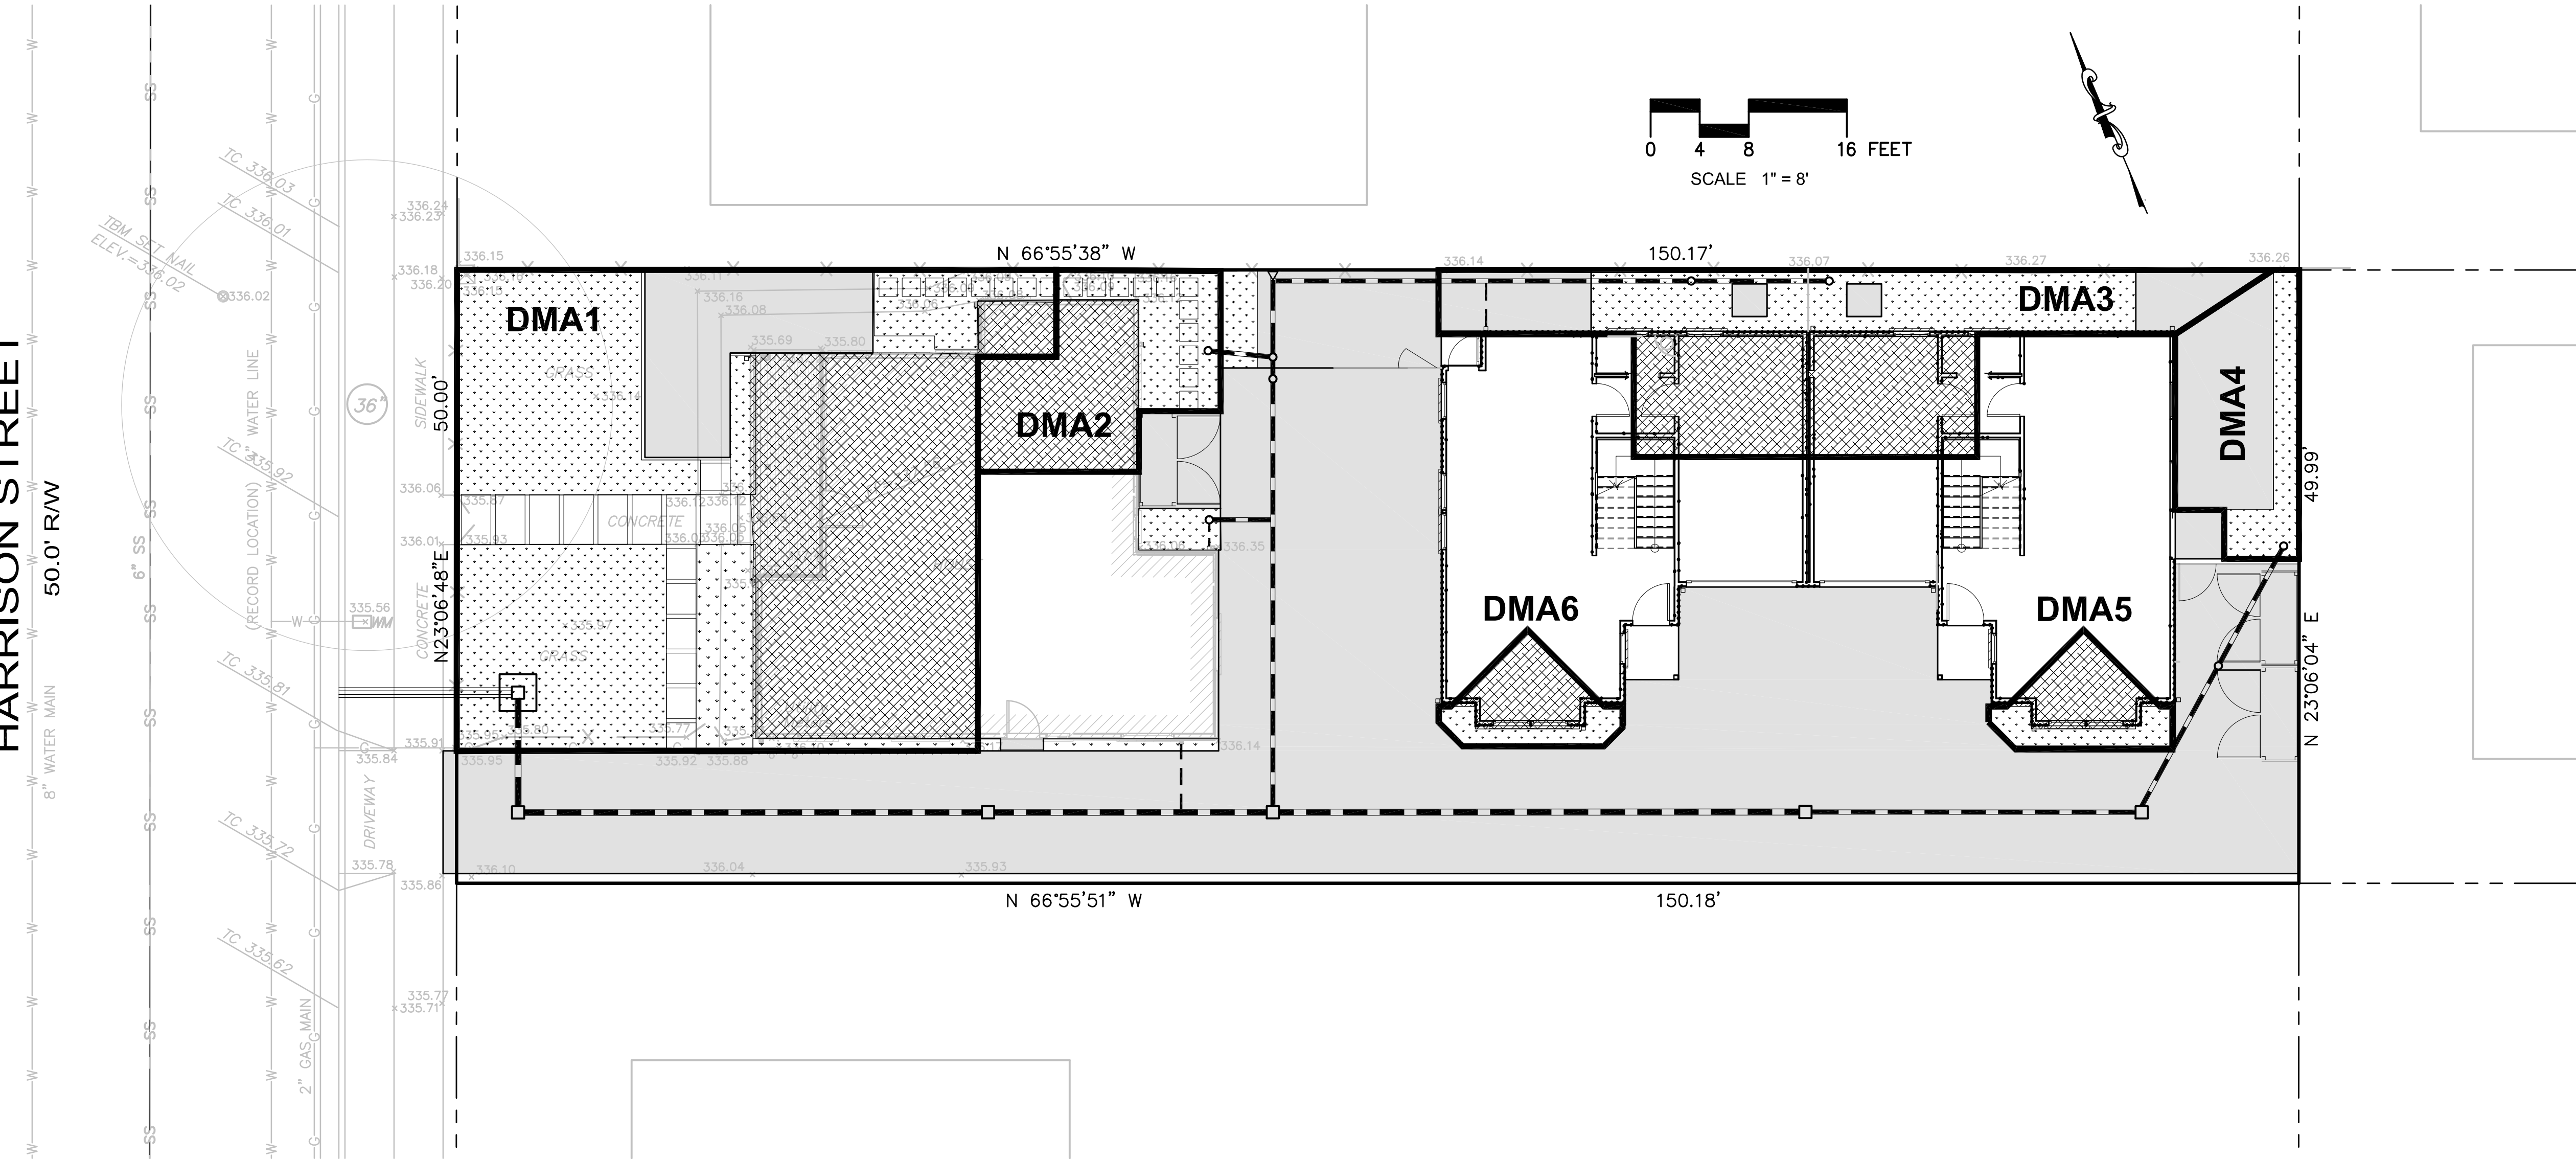

LEGEND

- STORM DRAIN LINE
- DOWNSPOUT TIE TO STORM DRAIN
- ROOFS
- NEW CONCRETE DRIVEWAY/ PAVING
- RECEIVING LANDSCAPE
- DMA DRAINAGE MANAGEMENT AREA
- DRAINAGE MANAGEMENT AREA LIMITS

TREATMENT AREA SCHEDULE:

DMA#	ROOF AREA	PAVEMENT AREA	TOTAL IMPERVIOUS AREA	REQUIRED LANDSCAPE AREA	PROVIDED RECEIVING LANDSCAPE AREA
1	630	275	1,005	503	737
2	155	25	180	90	92
3	280	110	396	198	218
4	-	134	134	67	68
5	55	-	55	28	34
6	55	-	55	28	30



IZZAT S. NASHASHIBI R.C.E. 29528




PRELIMINARY SMALL PROJECT C.3.i PLAN
WINSLOW PROPERTY
 APN 094-0155-020 - LOT 85 (10 M 60)
 4722 HARRISON STREET
 PLEASANTON CALIFORNIA

HUMANN COMPANY INC.
 ENGINEERING - SURVEYING
 10500 WILSON AVENUE, SUITE 200
 PH (925) 263-5000 FAX (925) 263-8576

SHEET **C03**
 OF 4 SHEETS

JOB NO. 17090

REVISIONS	SCALE	DATE	ENGINEER	H. N.	JOB NO.
1	1"=8'	02/21/18			17090

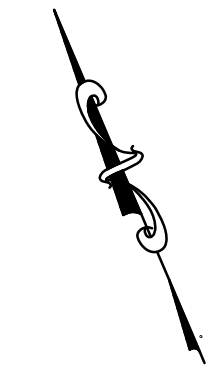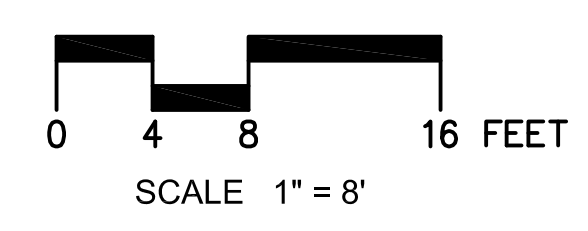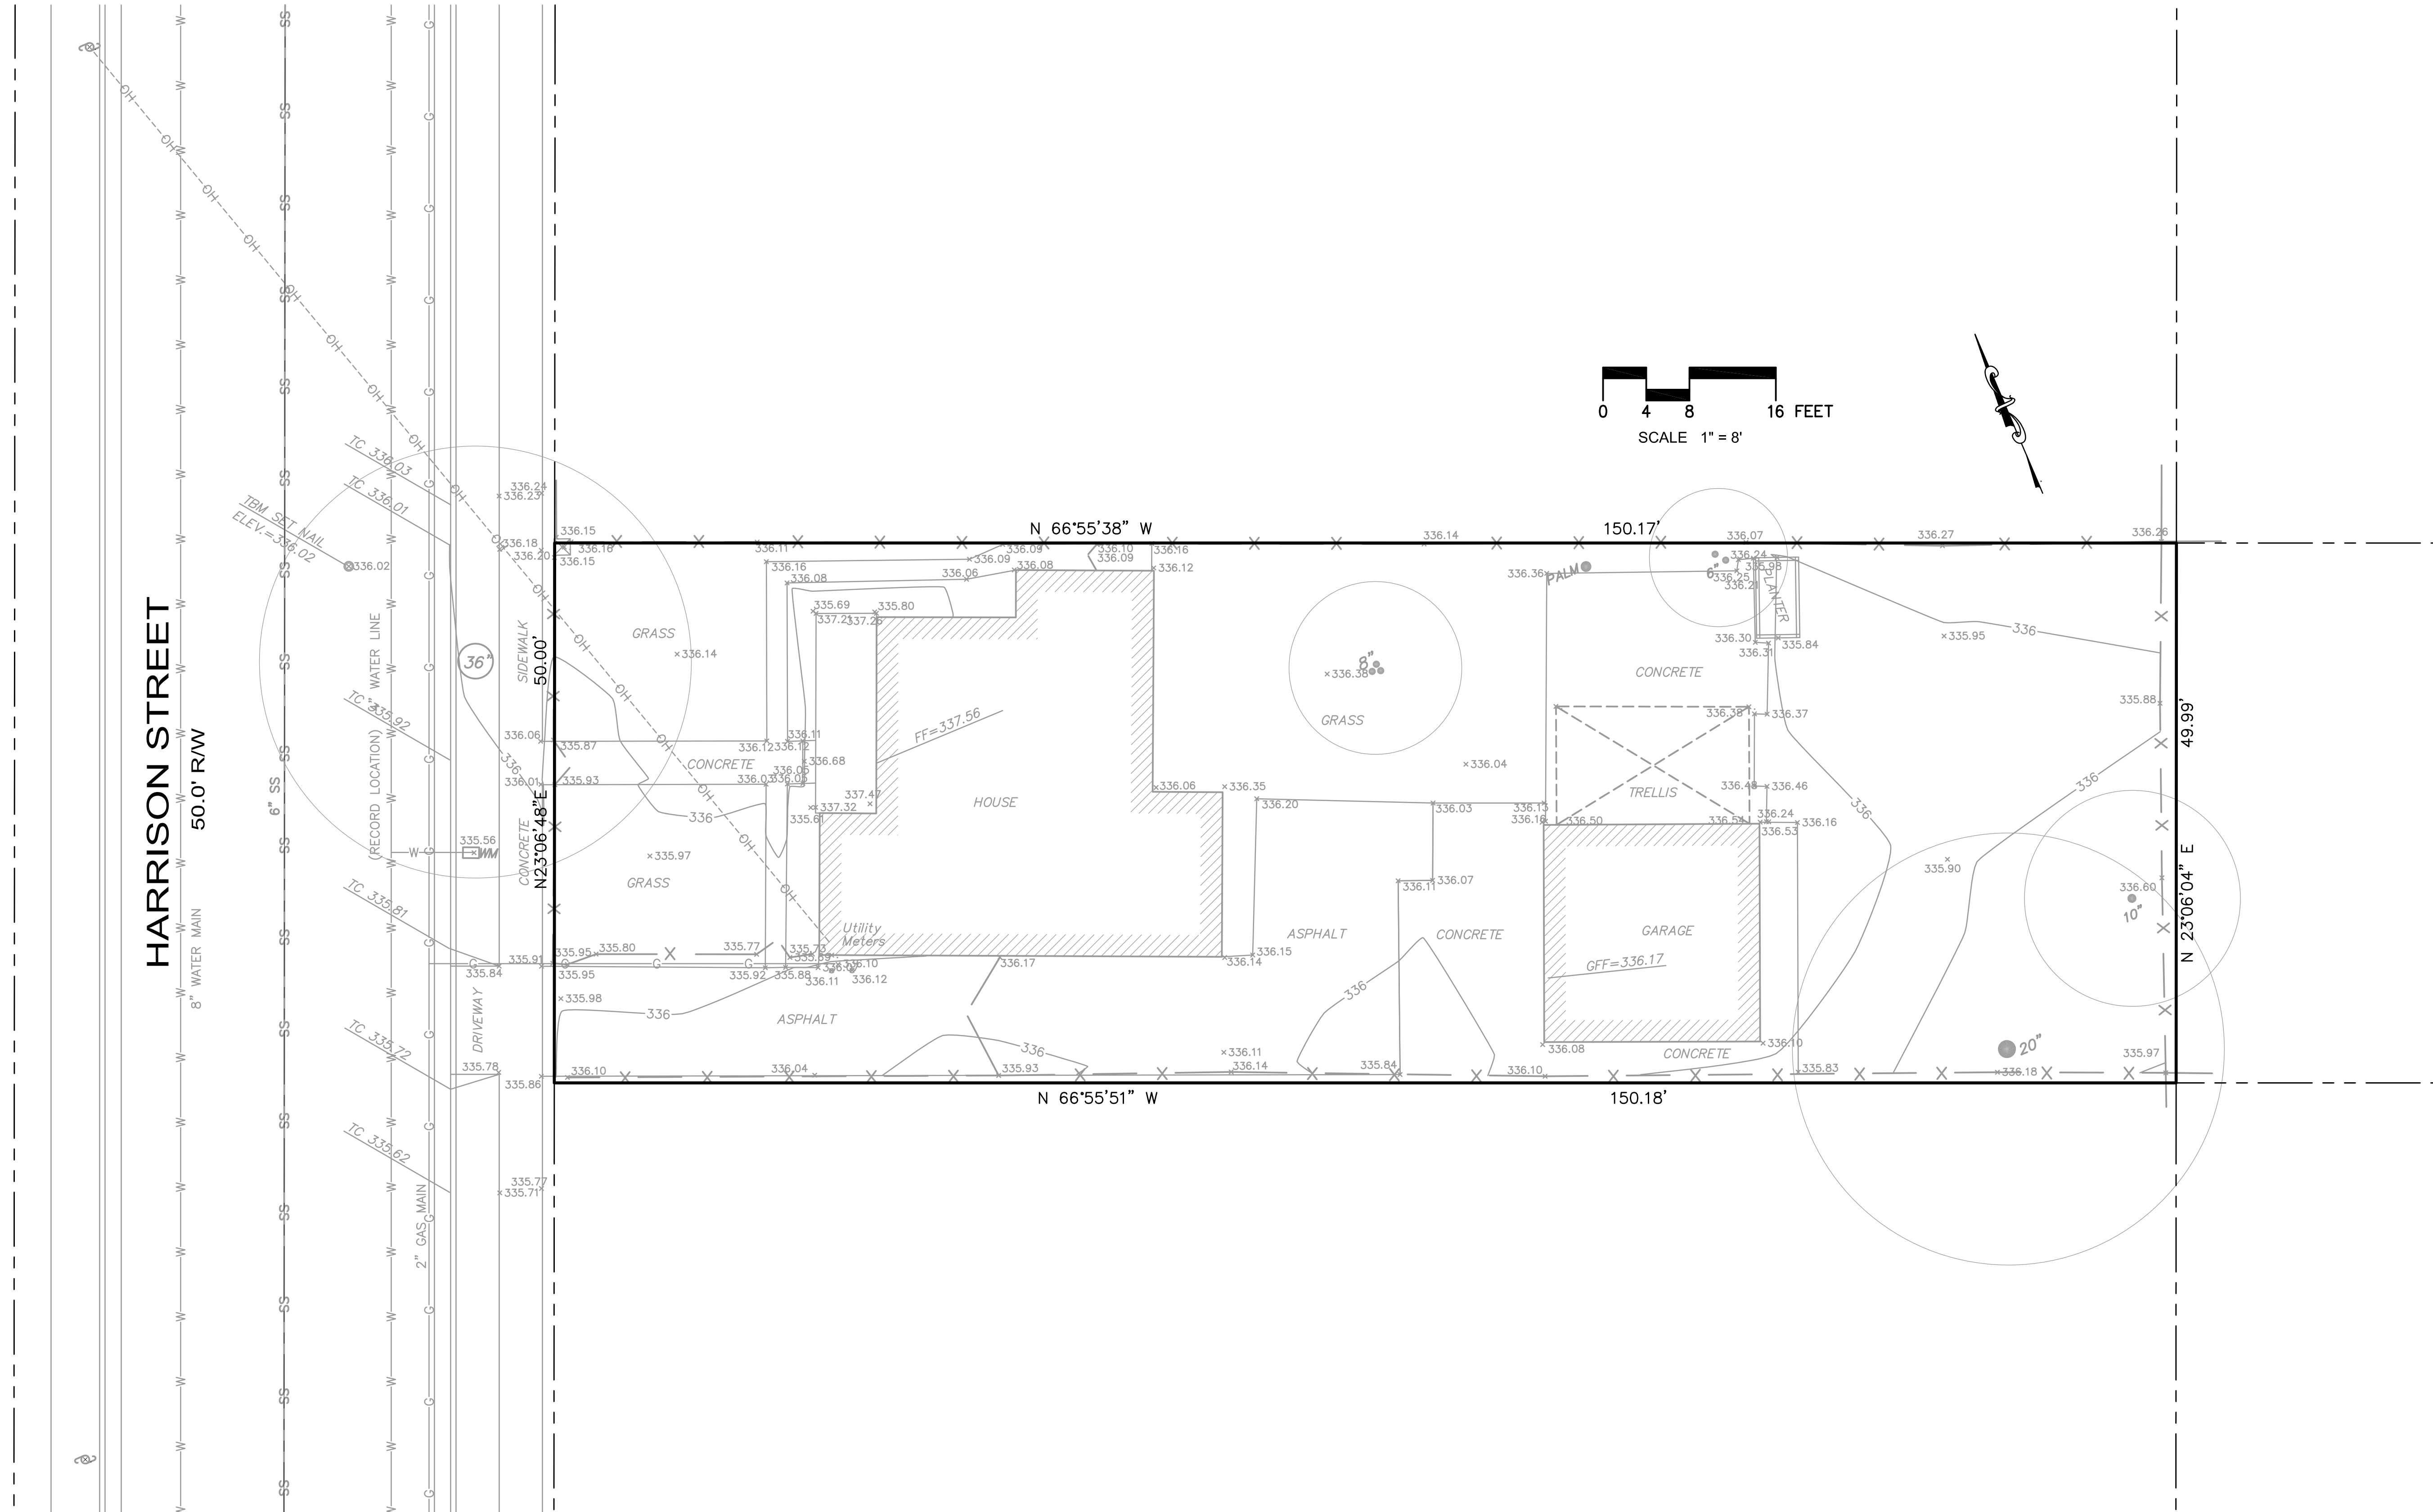

BENCHMARK:
 ELEVATIONS SHOWN HEREON ARE BASED UPON CITY OF CITY OF PLEASANTON DATUM. TBM SET NAIL ELEV.=336.02

TOPOGRAPHIC INFORMATION NOTE:
 EXISTING TOPOGRAPHIC INFORMATION SHOWN HEREON PROVIDED BY ALEXANDER & ASSOCIATES INC., JOB No.16324, DATED DECEMBER 10, 2016.



IZZAT S. NASHASHIBI R.C.E. 29528

SCALE	DATE	ENGINEER	JOB NO.
1"=8'	09/21/18	H. N.	17090

EXISTING CONDITIONS
WINSLOW PROPERTY
 APN 094-0155-020 - LOT 83 (10 M 60)
 4722 HARRISON STREET
 PLEASANTON CALIFORNIA

HUMANN COMPANY INC.
 ENGINEERING - SURVEYING
 10000 W. HAYWARD AVE., SUITE 200
 HAYWARD, CA 94541
 PH (925) 285-5000 FAX (925) 285-8576

SHEET **C04**
 OF 4 SHEETS
 JOB NO. 17090