#### **EXHIBIT B**

# NARRATIVE FOR CONDITIONAL USE PERMIT / DEVELOPMENT REVIEW EMPIRE MONTESSORI PRESCHOOL P19-0048 (CUP) / P19-0049 (DR)

5950 Stoneridge Drive, Pleasanton

RECEIVED
February 25, 2019
CITY OF PLEASANTON
PLANNING DIVISION

#### 1. INTRODUCTION

The subject property, 5950 Stoneridge Drive, Pleasanton (**BLDG-1**), is one of two buildings of what is known as the Dutra Plaza. Dutra Plaza is on a 2+ acre parcel of land at the intersection of Chabot and Stoneridge Drive. The subject property has Extended Stay America Suites as a neighbor towards its South, Crossroads Shopping Center across from Chabot Drive towards its West and Stoneridge Drive towards its North. Chabot Canal flows all along the Southern perimeter. There are no residential neighbors.

Pleasanton Bilingual Montessori, which will be a sister school, is located at 5724 West Las Positas and was approved to operate a preschool for 156 children in November 2012 by the City of Pleasanton. It has served a diverse community while maintaining a good standing with the city since they opened for business in February 2014. Due to the popularity of our programs we are completely sold out for the current year, have a long waiting list, and are only entertaining applications for 2019. Pleasanton Bilingual Montessori intends to address the growing need of the diverse population of the city by opening a second preschool by the name of Empire Montessori Preschool at the subject location.

The purpose of this document is to provide all information required by the city and Hacienda Owners Association for approval of a Conditional Use Permit (CUP) and a Site Development Review for operating a preschool at the subject location.

#### 2. BUILDING DETAILS

Dutra Plaza consists of two (2) two-story structures with elevators and has approximately 7,000 Square Feet space on each floor. Both buildings, built in 1993, are zoned PUD-I/C-O. The subject building is vacant and available for rent as of this writing while 5960 Stoneridge Drive (BLDG-2) is occupied as an office. The Plaza has a total of 113 dedicated parking stalls for its use surrounding 3 sides of the building.

Empire Montessori Preschool intends to occupy **BLDG-1** and share the parking with BLDG-2. Attached is a Site Plan with the proposed area to be occupied by the preschool highlighted in grey.

Empire Montessori Preschool plans to utilize the first floor of the building for a preschool program while the second floor will be utilized as Administrative offices for the preschool and be accessible to adults only. Each floor will have independent and separate entrances. **Kids will not have access to the 2<sup>nd</sup> Floor.** The outside play area for the children will be wrapped around the building facing Stoneridge and Chabot Drives, as shown on the attached Site Plan.

There are currently two restroom cores in the building, one on each floor. Smaller restrooms are planned to be built within the classrooms for children's use on the first floor. The planned layout of the Floor Plan is attached.

#### 3. ABOUT US - THE PROPOSED TENANT

We specialize in providing bilingual services for preschool children and operate similar successful preschool bilingual programs in 5 other locations in and around the Bay Area, including the one at 5724 West Las Positas Boulevard in Pleasanton. As with all the other preschools operated by us, this preschool will be licensed by Community Care Licensing which is the state regulatory agency for childcare services.

The population of Tri-valley and surrounding cities is growing and this preschool will provide the much-needed service of bilingual education. Many parents in the tri-valley drive their children to Fremont for such services and would welcome such a service in Pleasanton.

#### 4. BUILDING USEAGE

Both floors of the building are proposed to be rented by Empire Montessori Preschool. The first floor will be used as a preschool and the second floor will remain as an office use.

#### FIRST FLOOR (PRESCHOOL USE)

- · Lobby for reception and registration
- Six preschool classrooms
- Bathrooms for children within the classrooms
- Staff bathrooms

#### SECOND FLOOR (PRESCHOOL ADMIN OFFICE USE)

- Office and conference room space
- Adult bathrooms

#### 5. PLAY STRUCTURE VISIBILITY

The outside play area for the children will be enclosed with a decorative tubular black metal fence. The applicant is acutely aware of the City's desire to keep colorful play structures associated with preschool play areas obscured from streets. The applicant's remedies shall include, but not limited to, the following.

 Use of landscaping. The two streets that the play structure could be visible from are Stoneridge and Chabot Drives. Both streets have 3 ft – 3.5 ft of existing berms and 2 ft – 2.5 ft of landscaping hedges. Using the planting guidelines of Hacienda Owners Association, hedges and new tall plants will be used to obscure the play structure from being visible from the streets.

- Use of a low-height 6 feet tall play structure. This will further reduce the possibility of the play structure being visible from the streets. The metal fence surrounding the play area is 6 ft high.
- The play structure selected shall be of muted natural colors that would blend with the surrounding landscaping.

#### **OPERATIONAL PLAN**

#### 6. CAPACITIES

#### Preschool (First Floor)

The preschool is requesting a maximum capacity of 120 children of 18 months to 5 years of age with the following breakdown:

(i) Children between 18 and 24 months =	20
(ii) Children between 2 and 5 years =	100
Total capacity =	120

#### 7. HOURS OF OPERATION

#### Preschool

The preschool will operate Monday through Friday, excluding holidays. The preschool will offer the following programs. The drop-off times for these programs will vary between 7:30AM and 9:30AM.

(i) School-day program (7:30 AM – 3:00 PM):	Pick-up time – 3:00 PM
(ii) Full-day program (8:30 AM – 6:30 PM):	Pick-up time – 6:15 PM to 6:30 PM
(iii) Half-day program (9:30 AM – 12:00 Noon):	Pick-up time – 12:00 Noon

Each program is expected to have one-third of the full capacity of children, i.e., 40 children.

The staggered pick-up and drop-off times will make a minimum impact on parking and traffic.

#### 8. PRESCHOOL PLANNED ACTIVITIES

The following table shows the planned activities for the preschool (Monday – Friday).

	Childcare	Childcare	Childcare	Childcare	Childcare	Childcare
	Room #1	Room #2	Room #3	Room #4	Room #5	Room #6
Usage	Pre-school	Pre-school	Pre-school	Pre-school	Pre-school	Pre-school
Dimensions	21'-9"x57'-	21-9"′x57′-	19'x25'-10"	34'-10"x30'-	34-10'x30'	60'-3"x2''-
	9"	9"		3"		10"
Occupancy	20	20	20	20	20	20
Area	840 SF	819 SF	543 SF	860 SF	860 SF	860 SF
Days of Use	Mon - Fri	Mon - Fri	Mon - Fri	Mon - Fri	Mon - Fri	Mon - Fri
Student-	1:12	1:12	1:12	1:12	1:12	1:12
Teacher						
Ratio						
Hours of	7:30AM –	7:30AM -	7:30AM –	7:30AM -	7:30AM –	7:30AM -
Use	6:30PM	6:30PM	6:30PM	6:30PM	6:30PM	6:30PM
Drop-off	7:30AM –	7:30AM –	7:30AM –	7:30AM –	7:30AM –	7:30AM –
	9AM	9AM	9AM	9AM	9AM	9AM
Morning	7:30AM -	7:30AM -	7:30AM –	7:30AM -	7:30AM –	7:30AM -
Greeting	9AM	9AM	9AM	9AM	9AM	9AM
Morning	9AM-	9AM-	9AM-	9AM-	9AM-	9AM-
Circle Time	9:30AM	9:30AM	9:30AM	9:30AM	9:30AM	9:30AM
Montessori	9:30AM-	9:30AM-	9:30AM-	9:30AM-	9:30AM-	9:30AM-
Work	11AM	11AM	11AM	10:30 AM	11AM	11AM
Outdoors	11AM-	11AM-	11AM-	11AM -	11AM-	11AM-
Time	12Noon	12Noon	12Noon	12Noon	12Noon	12Noon
Half Day	12 Noon –	12 Noon –	12 Noon –	12 Noon –	12 Noon –	12 Noon –
Pickup	12:30PM	12:30PM	12:30PM	12:30PM	12:30PM	12:30PM
Lunch &	12 Noon –	12 Noon –	12 Noon –	12 Noon –	12 Noon –	12 Noon –
Nap	3PM	3PM)	3PM)	3PM)	3PM)	3PM
School Day	3PM -	3PM -	3PM -	3PM -	3PM -	3PM –
Pickup	3:30PM	3:30PM	3:30PM	3:30PM	3:30PM	3:30PM
Snack &	3PM – 5PM	3PM – 5PM	3PM – 5PM	3PM – 5PM	3PM – 5PM	3PM – 5PM
Montessori						
Summers						
Outdoors	5PM – 6PM	5PM—6PM	5PM – 6PM	5PM – 6PM	5PM – 6PM	5PM – 6PM
Summers						
Outdoors -	3PM – 4PM	3PM – 4PM	3PM – 4PM	3PM – 4PM	3PM – 4PM	3PM-4PM
Winters						
Snack &	4PM – 6PM	4PM – 6PM	4PM – 6PM	4PM – 6PM	4PM – 6PM	4PM – 6PM
Montessori						
Winters						
Full Day	6:15PM –	6:15PM –	6:15PM –	6:15PM –	6:15PM –	6:15PM –
Pickup	6:30PM	6:30PM	6:30PM	6:30PM	6:30PM	6:30PM

Note: The outside play-time for the children will be adjusted according to daylight hours between summer and winter such that the total outside play time for the children remains the same.

#### 9. PRESCHOOL PICKUP / DROP-OFF POLICY

The Preschool will follow this pickup and drop-off policy:

All children will be dropped-off and picked up by an authorized parent/guardian only. The entrance to the school will have an electronic security system, which can be opened by an electronic card key issued to each parent/guardian. The drop-off requires the following 3 steps:

- a. Park his/her car and walk the child to the entry door to the lobby
- b. Open the door with the card key to enter the lobby
- c. Check-in the child electronically on a computer in the lobby and depart

The process is quite streamlined for quick drop-offs and pickups and on an average takes about 2 minutes.

#### 10. PRESCHOOL SPACE REQUIREMENT

Community Care Licensing, the State regulatory agency that licenses preschools, and the City require 35 Square Feet of classroom space per student and access to an open play area for the preschool children. The play area requirement is 75 Square Feet per child, excluding infants and toddlers.

#### **Preschool Classrooms:**

Permit application (Number of children) =	120
Minimum classroom space requirement for 120 children (35 SF/child) =	4,200 SF
Net space of 6 preschool classrooms provided =	4,782 SF

Hence the classroom space exceeds the minimum requirement.

#### **Outside Play area:**

Outside play area provided =	4,217 SF
Number of children in the play area at any one time (75 SF/child) =	56

The play-time for 120 children will be staggered so that the maximum number of children in the play area do not exceed 56.

#### 11. PARKING ANALYSIS

Dutra Plaza has a total of 113 parking stalls. The following analysis shows that the parking stalls available are more than sufficient for the proposed uses.

Standard car stalls	67 (59.3%)
Compact car stalls	42 (37.2%)
ADA Cars	4 (3%)
Preferential Parking stalls	6
EV Charging stations	2
Bike Racks (Total bikes – 8)	4

#### **BLDG-1 & 2 COMBINED**

Gross Square Footage of BLDG-1 and BLDG-2	28,027
Total parking available at Dutra Plaza	113
Required parking @ 3.33 cars/1000 SF	93
Excess parking stalls	20

#### PARKING FOR BLDG-2 (OFFICE USE)

Gross Square Footage of BLDG-2 13,571
Required parking @ 3.33 cars/1000 SF 45

#### PARKING FOR BLDG-1 (PRESCHOOL & OFFICE USE)

Parking available for BLDG-1 (113 - 45) = 68

#### PARKING FOR BLDG-1 (SECOND FLOOR – OFFICE USE)

Gross Square Footage of BLDG-1, Second Floor 7,228
Required parking @ 3.33 cars/1000 SF 24

Since Empire Montessori Preschool is leasing all of BLDG-1 (both first and second floor), the parking requirement for the Second Floor will always be restricted to 24 Parking stalls.

#### PARKING FOR BLDG-1 (PRESCHOOL)

Parking stalls available for Preschool (113 - 45 - 24) = 44

Employee parking 18

Parking stalls available for circulation (Pick-up / Drop/off) 44 - 18 = 26

The following table summarizes the maximum number of cars at the facility at any one time during the day. The analysis was done keeping in view the following:

Preschool Capacity: 120 Staff: 18

Hours of Operation: 7:30 AM – 6:30 PM

The check-in and check-out times shown in the Parking Analysis table below are based on a check-in / check-out log from the sister school, Pleasanton Bilingual Montessori Preschool, which had an enrollment of 108 children on that day (see Appendix C). Since the capacity of the new proposed preschool is 120, the additional 12 children were added evenly.

The check-in / check-out log referenced above is attached as Attachment 1. The log shows that students are dropped off at different times and are processed efficiently. For our analysis, we have allocated 5 minutes for each pickup / drop-off. Our observation at Pleasanton Bilingual Montessori Preschool has been that the use of stalls for pick-up and drop-off (circulation) do not exceed 15.

#### **PARKING ANALYSIS**

TIME WINDOW	_	CHOOL FLOOR)	ACTIVITY	MAX STALLS IN USE	MAX STALLS AVAILABLE
	STAFF	STUDENTS			
7:00 – 7:30 AM	2	0	Check-in	2	44
7:30 – 8:00 AM	2	4	Check-in	8	44
8:00 – 8:30 AM	6	6	Check-in	11	44
8:30 – 9:00 AM	8	18	Check-in	22	44
9:00 – 9:30 AM	0	36	Check-in	26	44
9:30 – 10:00 AM	0	38	Check-in	26	44
10:00 – 10:30 AM	0	13	Check-in	21	44
10:30 – 11:00 AM	0	5	Check-in	19	44
11:00 – 11:30 AM	0	0	No Change	18	44
11:30 – 12:00 N	0	0	No Change	18	44
12:00 – 12:30 PM	(-2)	(-16)	Check-out	20	44
12:30 – 1:00 PM	(-1)	(-10)	Check-out	17	44
1:00 – 1:30 PM	0	0	Check-out	15	44
1:30 – 2:00 PM	0	0	Check-out	15	44
2:00 – 2:30 PM	0	0	Check-out	15	44
2:30 – 3:00 PM	0	0	Check-out	15	44
3:00 – 3:30 PM	0	0	Check-out	15	44
3:30 – 4:00 PM	(-2)	(-20)	Check-out	17	44
4:00 – 4:30 PM	0	(-8)	Check-out	15	44
4:30 – 5:00 PM	0	(-6)	Check-out	15	44
5:00 – 5:30 PM	0	(-8)	Check-out	15	44
5:30 – 6:00 PM	(-1)	(-14)	Check-out	15	44
6:00 – 6:30 PM	(-12)	(-38)	Check-out	20	44

The analysis shows that the 44 available stalls for the Preschool are more than sufficient as the maximum stalls used by Staff and for Pickup / Drop-off does not exceed 26. There are 18 extra stalls available in case a high number of parents show up simultaneously for Pickup or Drop-off.

#### 12. CO-EXISTENCE WITH EXISTING TENANTS

The existing tenants in Building 2 generally use the driveway on Chabot Drive for entrance and exit and park in the section opposite their building as well as the section opposite the Extended Stay America Suites towards the south. The preschool parents would enter the parking lot from Stoneridge Drive as it is closest to the preschool entrance. This would form a natural flow of traffic for Dutra Plaza.

While this would generally be the pattern that would develop because of the proximity of the entrances to their respective buildings, there should not be any need to designate and enforce any change in the entrance or exits for the occupants of the two buildings. There is no Cross Access Agreement with neighboring tenants and none of the parking is shared with neighbors.

#### 13. SECURITY

The applicant's vast experience in childcare dictates a very high priority for Security of the children. As with other preschools of the applicant, Empire Montessori Preschool shall implement the following:

- All entry and exit doorways shall have controlled access (Card-key or code) and shall be video-monitored at all times.
- The play area and all outside walkways shall be fenced using tubular metal material.
- All parents/guardians shall be required to check-in and check-out their children.

#### **Attachment 1**

#### **PLEASANTON BILINGUAL MONTESSORI**

5724 West Las Positas Boulevard Pleasanton, CA 94588

Capacity:

141

**Enrollment:** 

108

Staff:

20

Date:

11/7/18

Hours:

7:30 AM - 6:30 PM

CHECK-IN/CHECK-OUT LOG

#### CHECK-IN:


Time Window	Number
7:00 - 7:30 AM	0
7:30 - 8:00 AM	3
8:00 - 8:30 AM	- 5
8:30 - 9:00 AM	15
9:00 - 9:30 AM	35
9:30 - 10:00 AM	37
10:00 - 10:30 AM	10
10:30 - 11:00 AM	3


#### **CHECK-OUT:**


12:00 - 12:30 PM	16
12:30 - 1:00 PM	8
1:00 - 1:30 PM	0
1:30 - 2:00 PM	17
2:00 - 2:30 PM	0
3:00 - 3:30 PM	0
3:30 - 4:00 PM	18
4:00 - 4:30 PM	6
4:30 - 5:00 PM	4
5:00 - 5:30 PM	e 6
5:30 - 6:00 PM	12
6:00 - 6:30 PM	38


Director:

Lena Guan

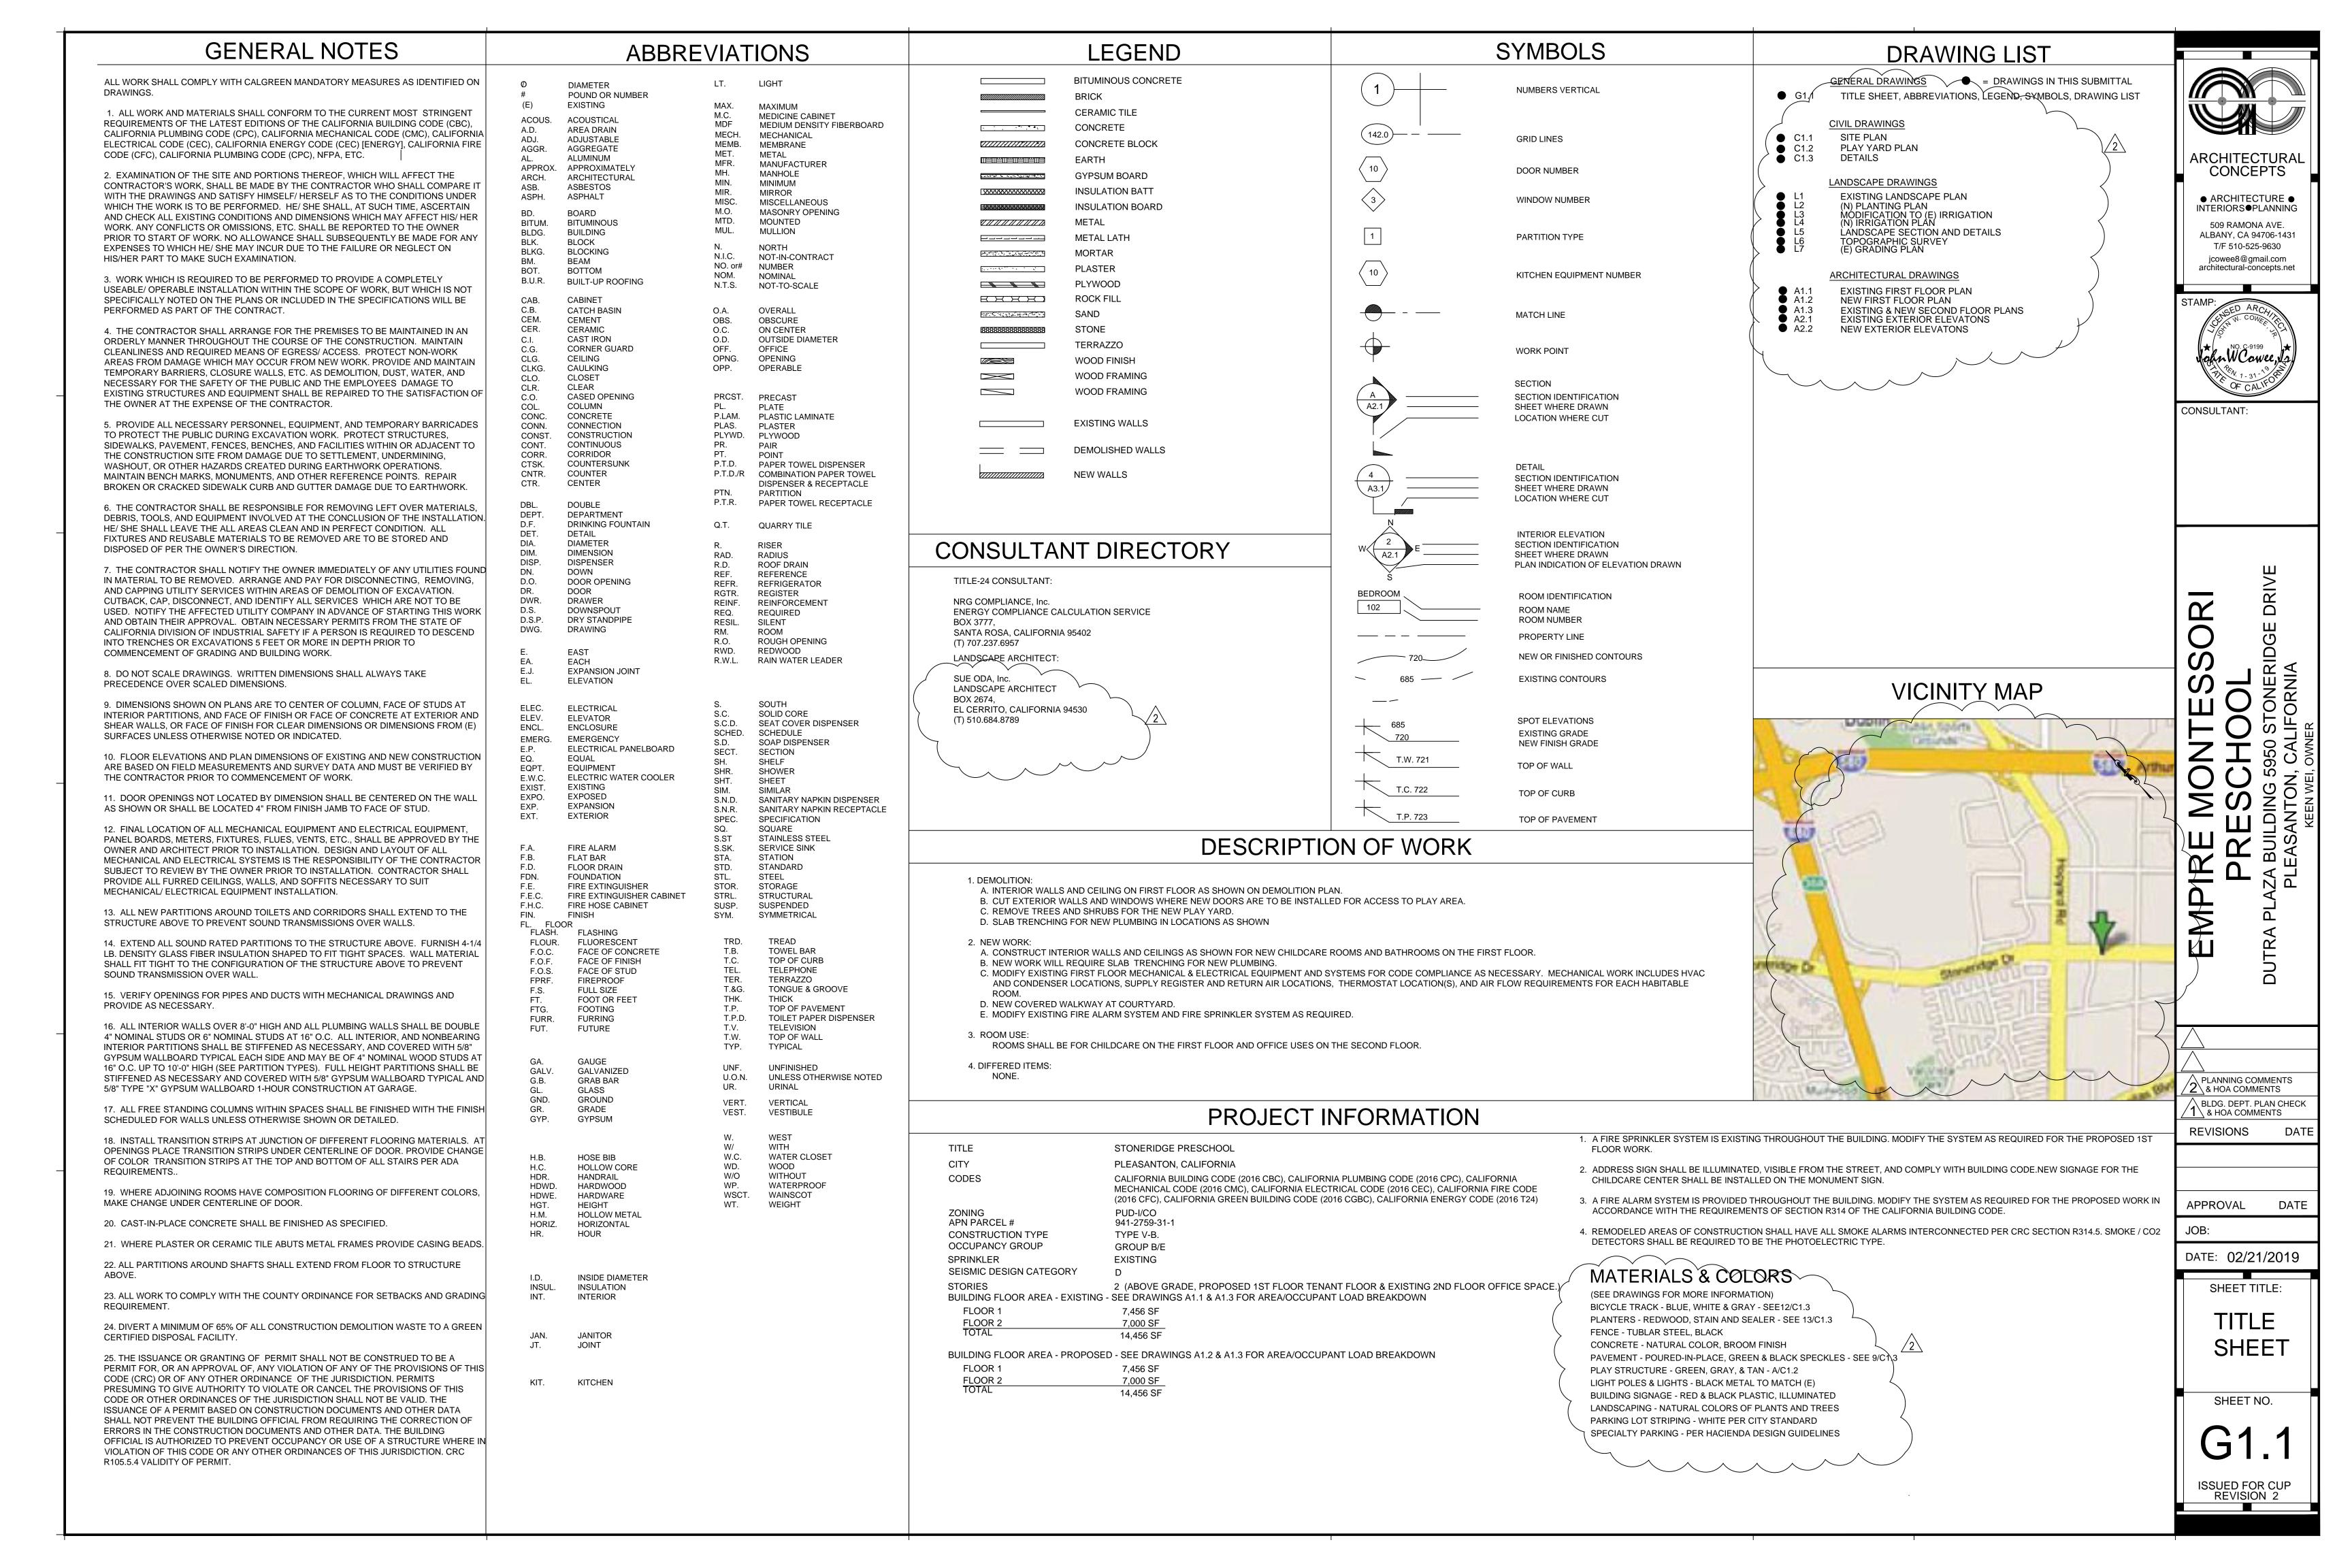

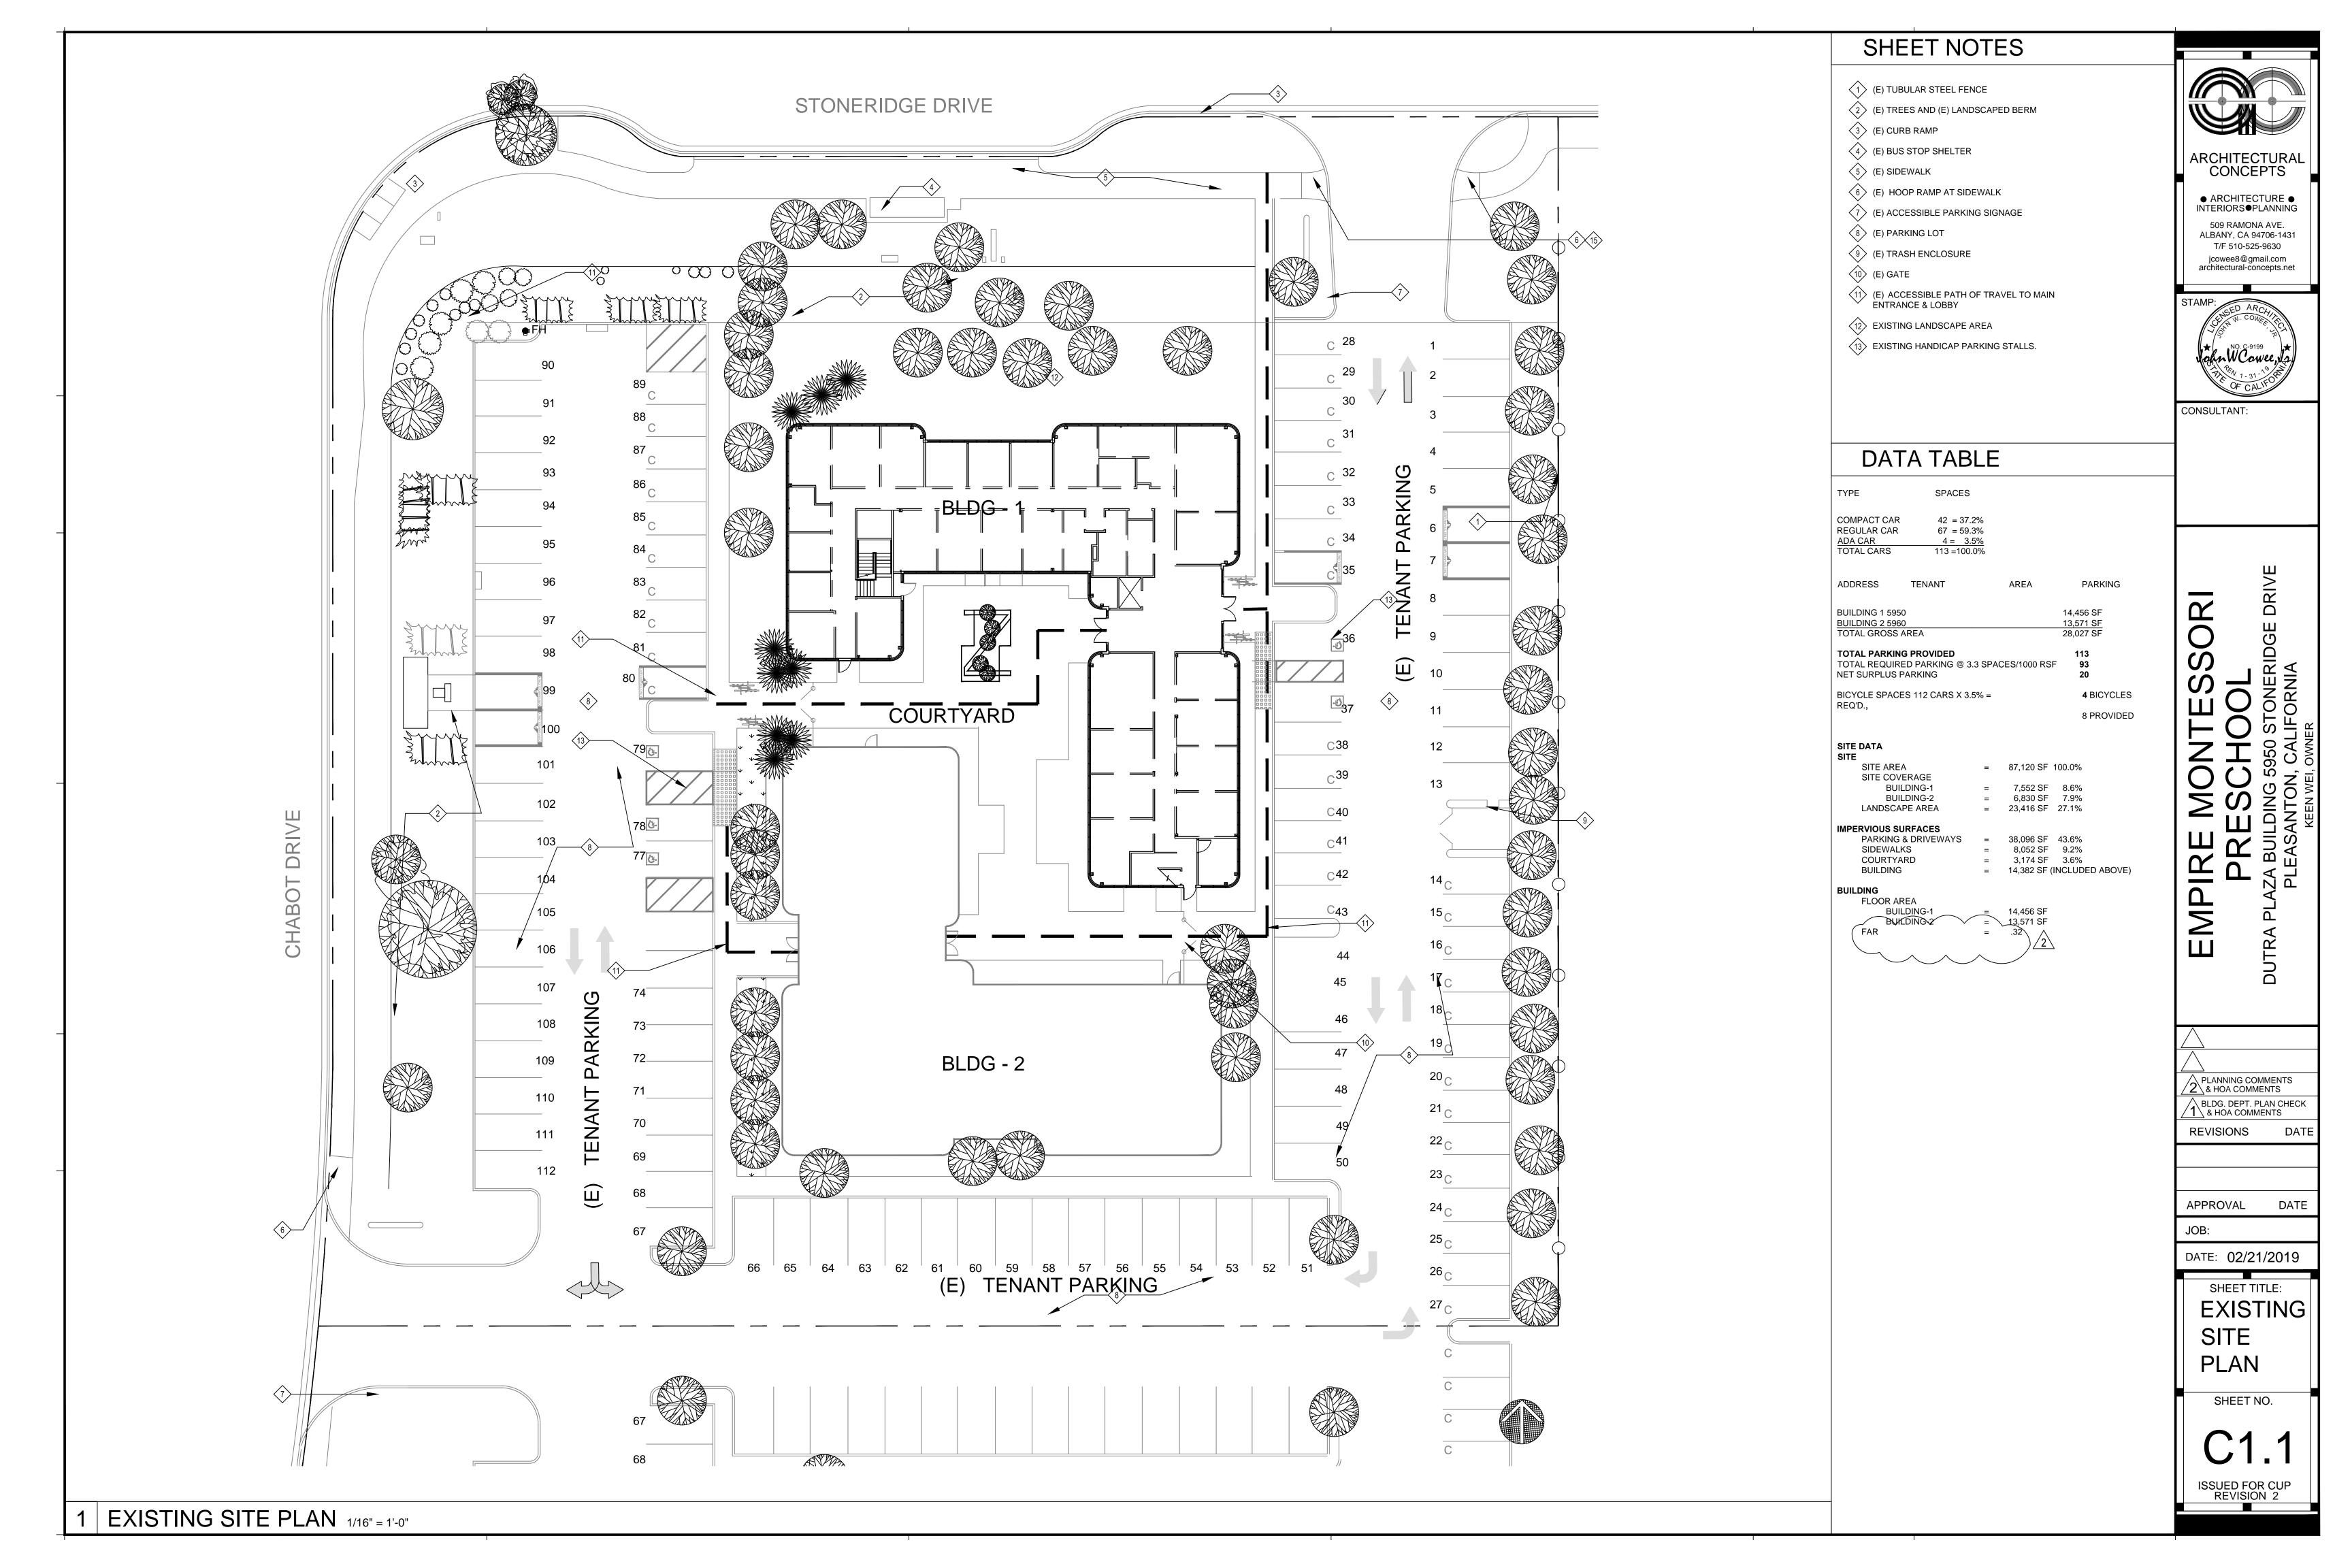

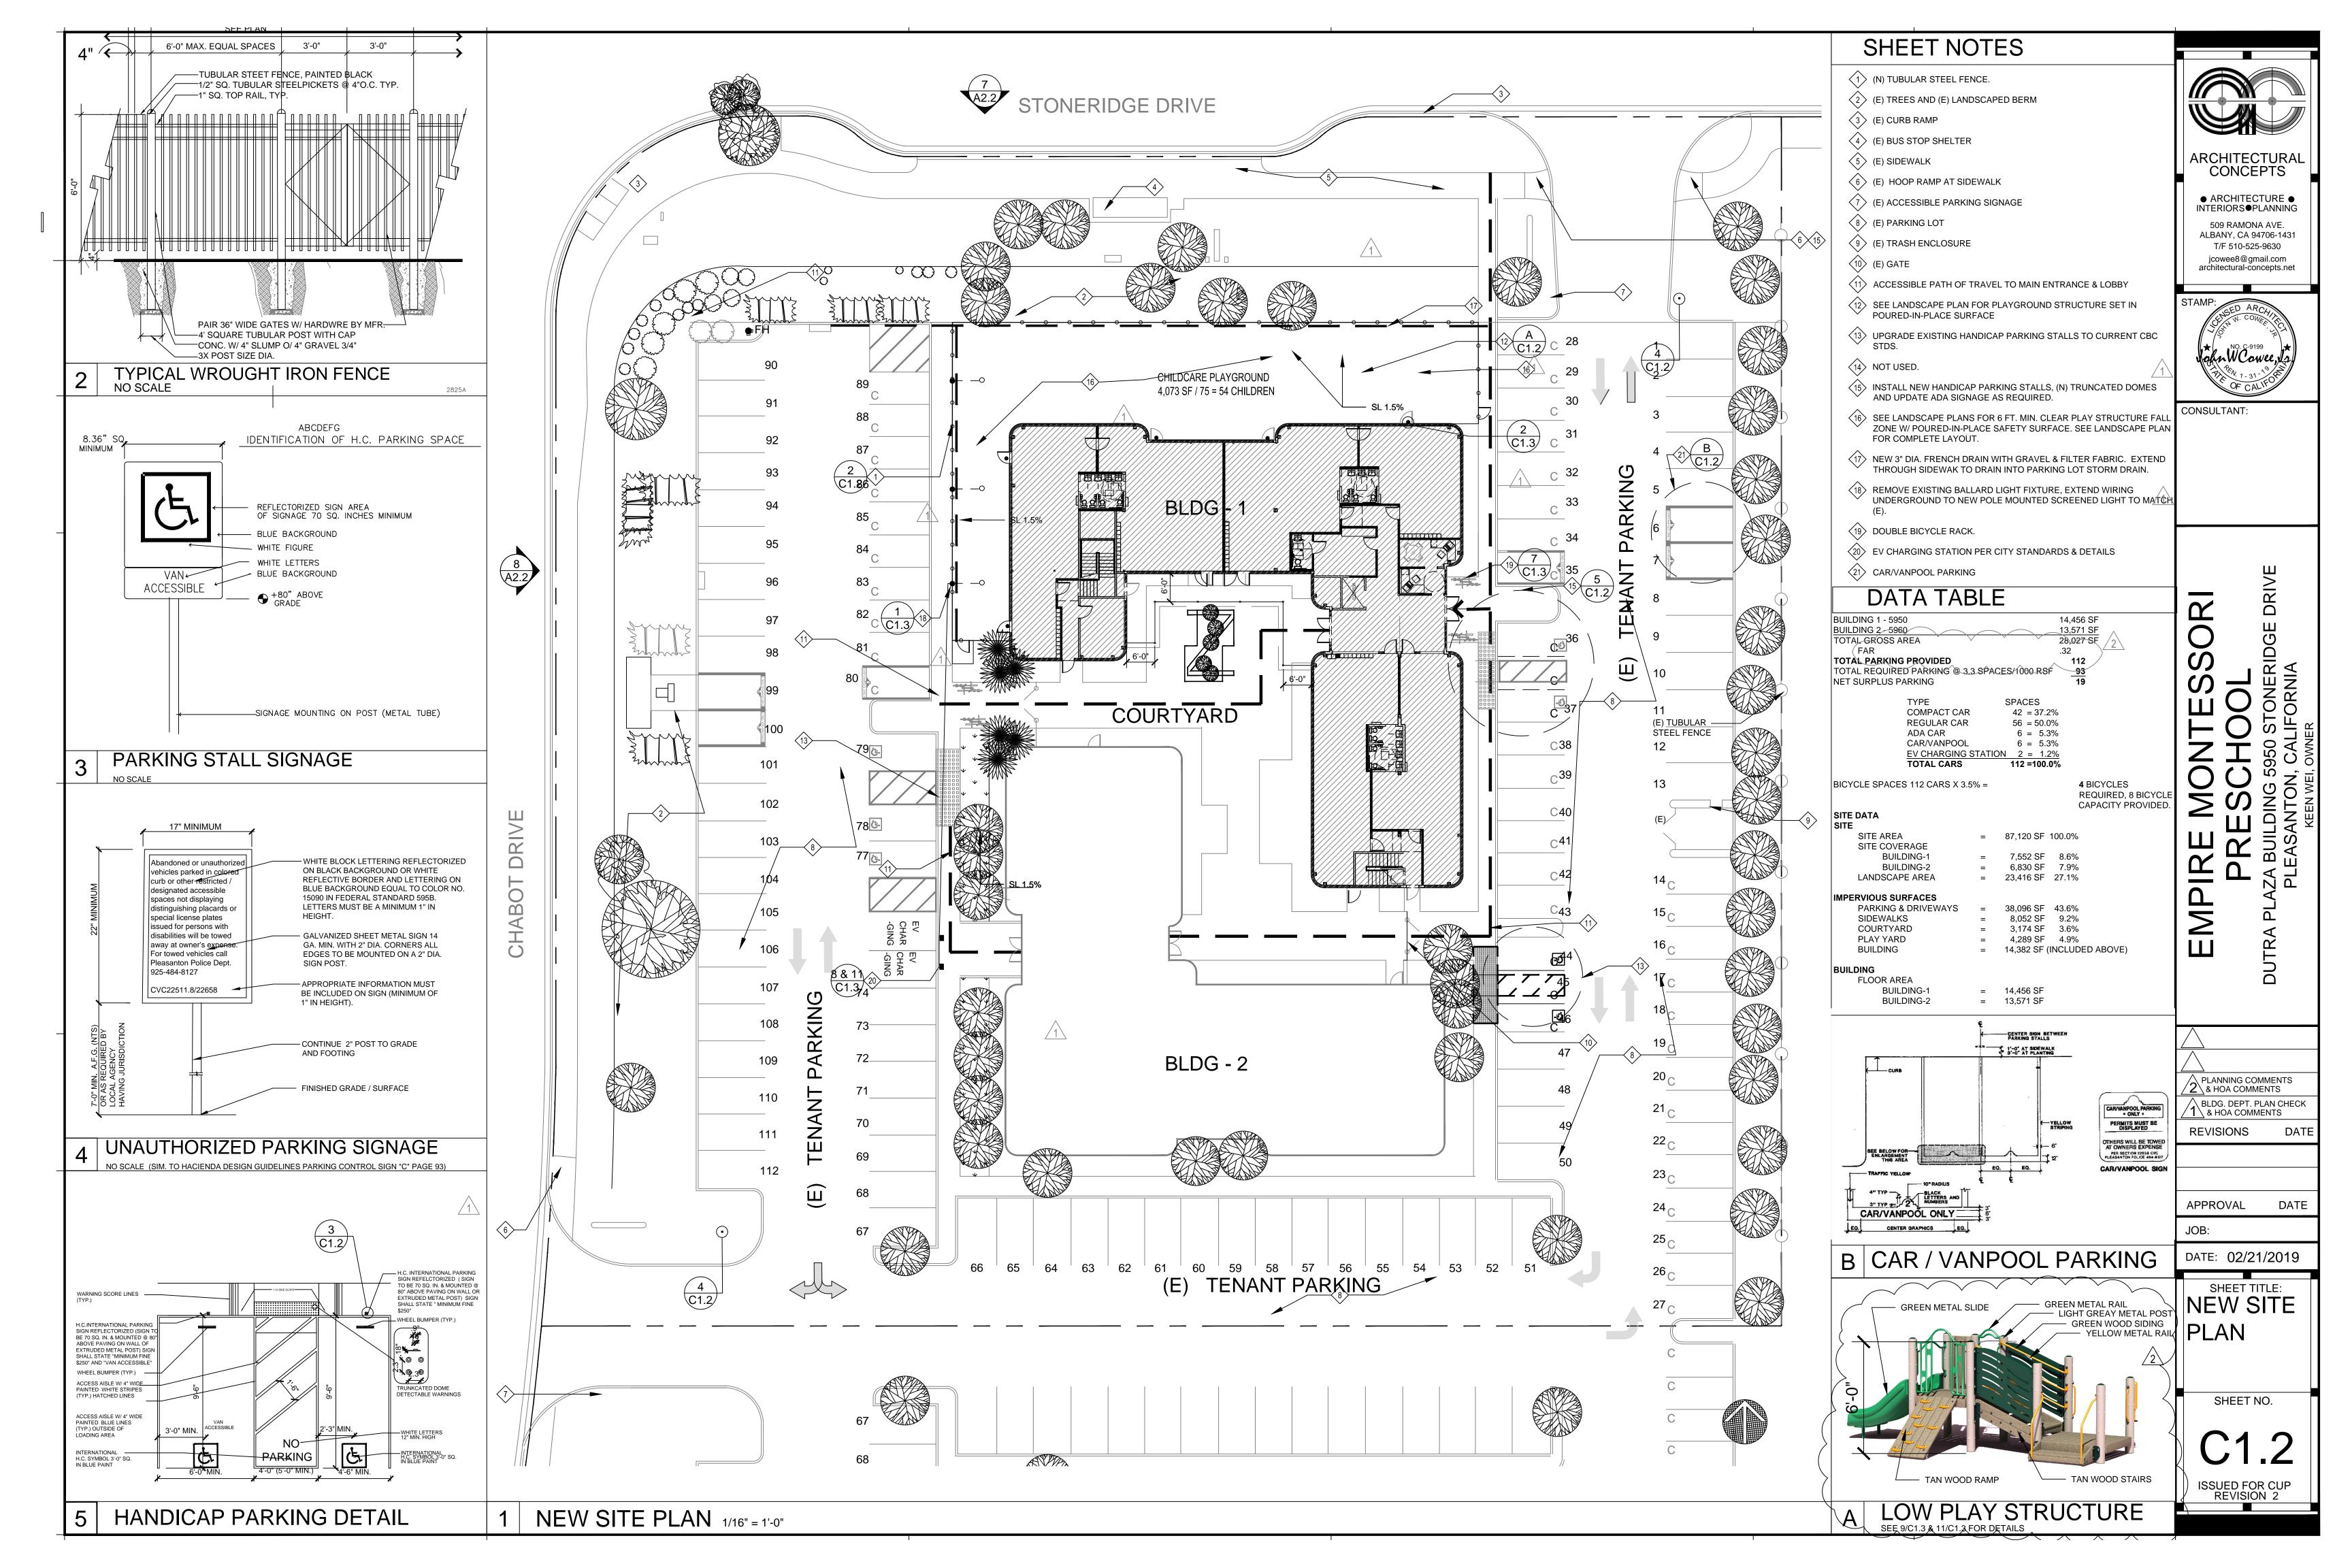

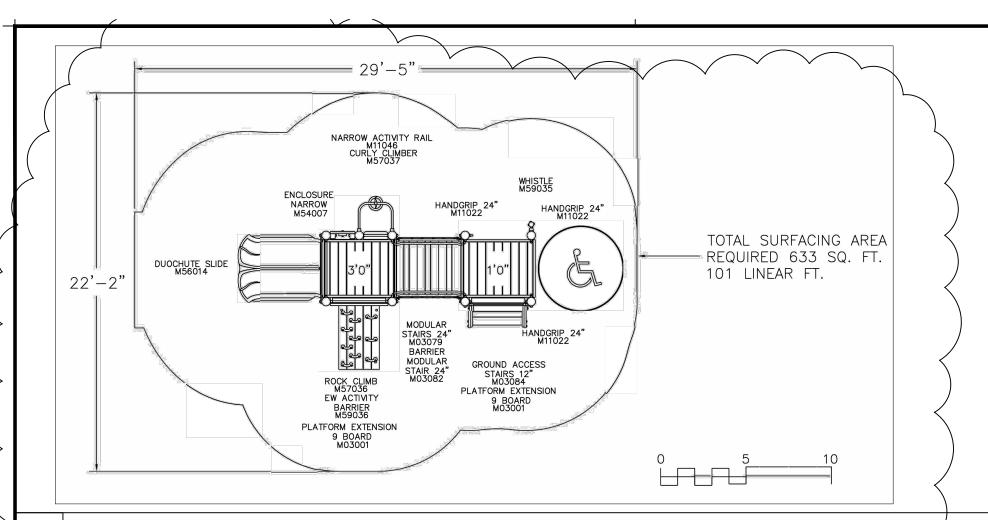

## PLAY EQUIPMENT PLAN NO SCALE (SEE A/C1.2)

ProLuxe Finishes Color Ideas Zone

STORE LOCATOR

Dealer near you:

Search for State

Search for City

Or search by Postal

POSTAL CO

STATE

Miles 25 MILES

Transparent Finishes Home Color ideas / Transparent Stains



PRACTICAL MULTI-PORT CHARGING FOR COMMERCIAL PARKING FACILITIES MODEL EVSE-RS SINGLE, DUAL AND QUAD

**ELECTRIC VEHICLE CHARGING STATION CONFIGURATIONS** 

# **FEATURES**

- Industry standard SAE-J1772 connector • Underwriters Laboratory (UL) listed
- Outdoor rated enclosure
- Americans with Disabilities Act (ADA)
- compliant installation • Auto restart in event of power outage or ground fault
- Breakaway safety cable

(EVSE-RS+)

• Integrated cable stowage • Optional network communication module

#### SERVICE AND INSTALLATION • Expanding network of independent

- certified, trained electricians
- Convenient customer site assessments and installation
- 24-hour response time during business hours

SPECIFICATION	EVSE-RS
Connector	SAE J1772 compliant
Voltage	208VAC to 240VAC
Frequency	60/50Hz
Output Current	30A max
Input Current	40A max
Operating Temperature	-22°F to 122°F -30°C to 50°C
Enclosure	NEMA 3R
Regulatory Compliance	UL, cUL, CE, CTick listed

Information and specifications subject to change.

POURED-IN-PLACE PAVING NO SCALE

The safe, reliable EVSE-RS Charging Station is available in single port, dual-port and quad-port configurations for higher-traffic commercial and public charging applications. While maintaining the same user friendly design of the single-port unit, the EVSE-RS Dual and Quad systems can simplify the installation and reduce costs by consolidating wiring runs and mounting locations. The attractive, weather-resistant housing provides a polished look that complements professionally maintained properties such as car dealerships, multi-dwelling units, shopping malls, corporate offices, and retail stores.

EVSE-RS multiport systems are compatible with all SAE J1772 compliant electric vehicles (EVs) and plug-in hybrids (PHEVs). Each charge port complies with all features and specifications of the single-port EVSE-RS, and an optional module for Ethernet, WiFi, Zigbee, or cellular communication is available.



AeroVironment™ EV Solutions™ 181 W. Huntington Dr., Suite 202, Monrovia, CA 91016 P. 888. 833.2148 F. 626.359.9628 www.evsolutions.com ev@avinc.com


RESINOUS MATRIX

BLACK CRYSTALS SET W **RESINOUS MATRIX** 

EV CHARGING STATION NO SCALE



# ELECTRIC VEHICLE SIGN NO SCALE

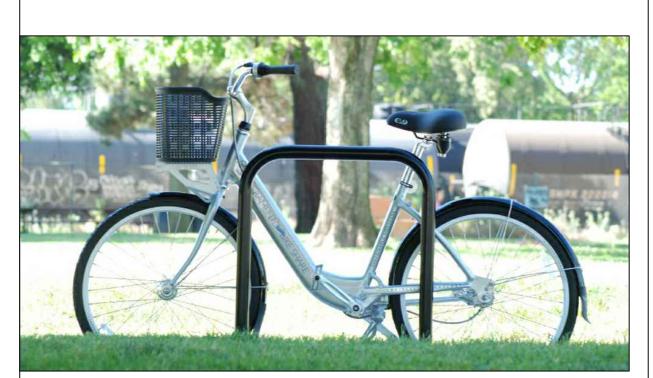

# HOOP RUNNER HR100 SERIES INVERTED U BIKE RACK

Prepared By:

# BICYCLE RACK NO SCALE

Two adjustable 12W LED floodlights. Equivalent to 2x75W BR30/halogen/wide floods. Comes with sensor with 180° detection pattern at up to 30 ft. Weight: 6.8 lbs Color: Bronze

UL Listing: Suitable for wet locations, wall mount only IESNA LM-79 & LM-80 Testing:

results and TM-21 calculation

Housing: Die-cast aluminum housing, lens frame and mounting Semi-specular, vacuum-metalized polycarbonate

Microprismatic diffusion lens for smooth and even light Sensor indicator LED glows red day & night for "on guard" deterrence Surge Protection:

Color Temp: Color Accuracy:

L70 Lifespan:

4000K

84 CRI

100000 2528

Withstands up to 3000 Volts Auto mode starts after 4 minutes of testing. No Manual Override:

momentary power outages. Override resets to auto at dawn. No extra wiring needed. Circuits fully shielded for maximum radio frequency

Photoelectric Control: Time, ambient light & sensitivity


RAB warrants that our LED products will be free from ten (10) years from the date of delivery to the end user,


Page 1 of 2

# American Quartz Restrike (QR) Custom Color (CC) (SF277) Custom Color (CC) (SF240) (SF277) (DF248) (DF240) (DF480) Internal Light Shield \*AME-2 & RAE-4 only (ILS) onvex Glass Lens "AME2 only (VLCG) d Pole Plate Adaptor (RPP)

- 1. POLE BASE IN NATURAL UNDISTURBED SOIL OR APPROVED COMPACTED FILL
- 2. PASSIVE SOIL BEARING ASSUMED TO BE 250 PSF.
- 3. PEDESTAL HEIGHT "P" = 3'-0" MAX.
- 4. POLE MANUFACTURER TO PROVIDE BASE PLATE AND ANCHOR BOLT CALCULATION AND DETAIL FOR THE APPROVAL OF BUILDING AND SAFETY DEPARTMENT PRIOR TO ERECTION OF SHAFT

HEIGHT OF POLE ABOVE BASE	"H" WHERE CONCRETE PAVING OCCURS AT BASE	"H" WHERE A.C. PAVING OR PLANTING OCCURS AT BASE
25' - 30'	5'-0"	6'-0"
20' - 24'	4'-6"	5'-6"
16' - 19'	4'-0"	5'-6"
14' - 15'	4'-0"	5'-0"
10' - 13'	4'-0"	4'-6"
16' – 19' AT BIOSWALE	4'-0"	10'-0"

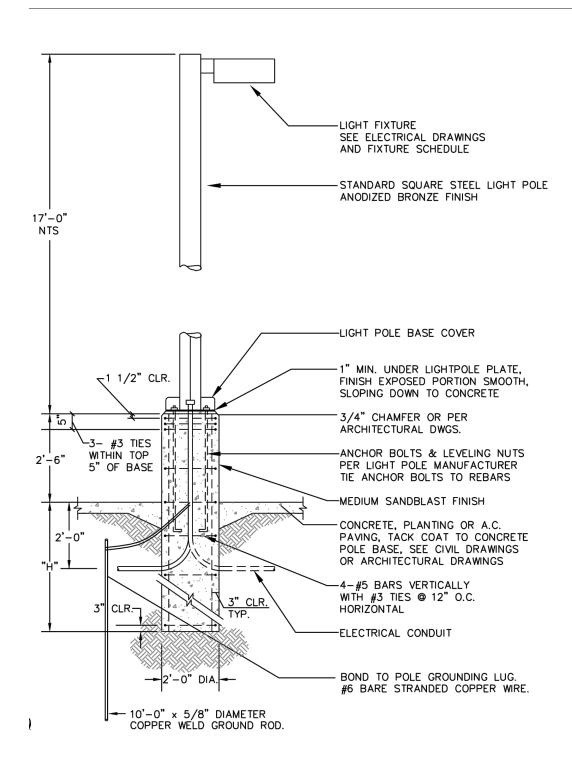

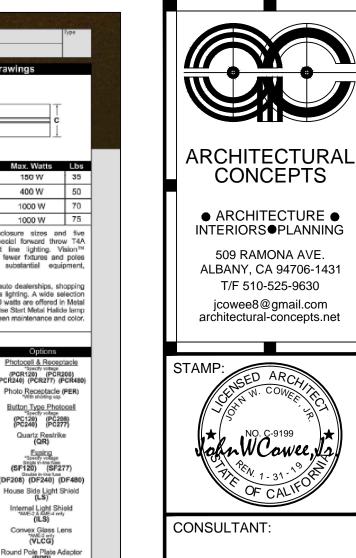



509 RAMONA AVE.

T/F 510-525-9630

# DRIVE

PLANNING COMMENTS 2\ & HOA COMMENTS 🛕 BLDG. DEPT. PLAN CHECK  $^{\prime}$  **1**  $\setminus$  & HOA COMMENTS REVISIONS APPROVAL DATE: 02/21/2019 SHEET TITLE: **EXTERIOR** 

FIXTURES & PANEL BD. **SCHEDULES** 

SHEET NO.

ISSUED FOR CUP REVISION 2

**SMSBULLET2X12NA** 

# **Technical Specifications**

RAB LED luminaries have been tested by an

independent laboratory in accordance with IESNA LM 79 and LM-80, and have been received the Department of Energy "Lighting Facts" label. **LED Characteristics** 

Multi-chip, high-output, long-life LEDs 100,000-Hour LED lifespan based on IES LM-80 Color Stability:

use of VOC or toxic heavy metals. LED color temperature is warrantied to shift no more than 200K in CCT over a 5 year period. Switching Capacity: **Color Uniformity:** 500 Watts of LED BULLET12 floods RAB's range of CCT (Correlated Color Temperature) follows the guidelines of the American National Standard for Specifications for the Chromaticity of Solid State Lighting (SSL) Products, ANSI C78.377-

Thermal Management: Superior heat sinking with external Air-Flow fins

## 120VAC, 60Hz. Sensor Power Consumption (when idle): Time Adjustment: 5 seconds to 15 minutes

Heavy-duty mounting arm with "O" ring seal and

are formulated for high-durability and long-lasting

Mercury and UV free. RoHS compliant components.

Polyester powder coat finish formulated without the

stainless steel screws

Green Technology:

including coverage of light output, color stability, driver performance and fixture finish

Our environmentally friendly polyester powder coatings 
Double flip wall switch logic prevents activation by


13 PLANTERBOX STAIN COLOR NO SCALE

PROPOSED FINISH for

**REDWOOD PLANTER** 

2 PROPOSED FLOOD LIGHTS NO SCALE

PARKING LOT LIGHT NO SCALE

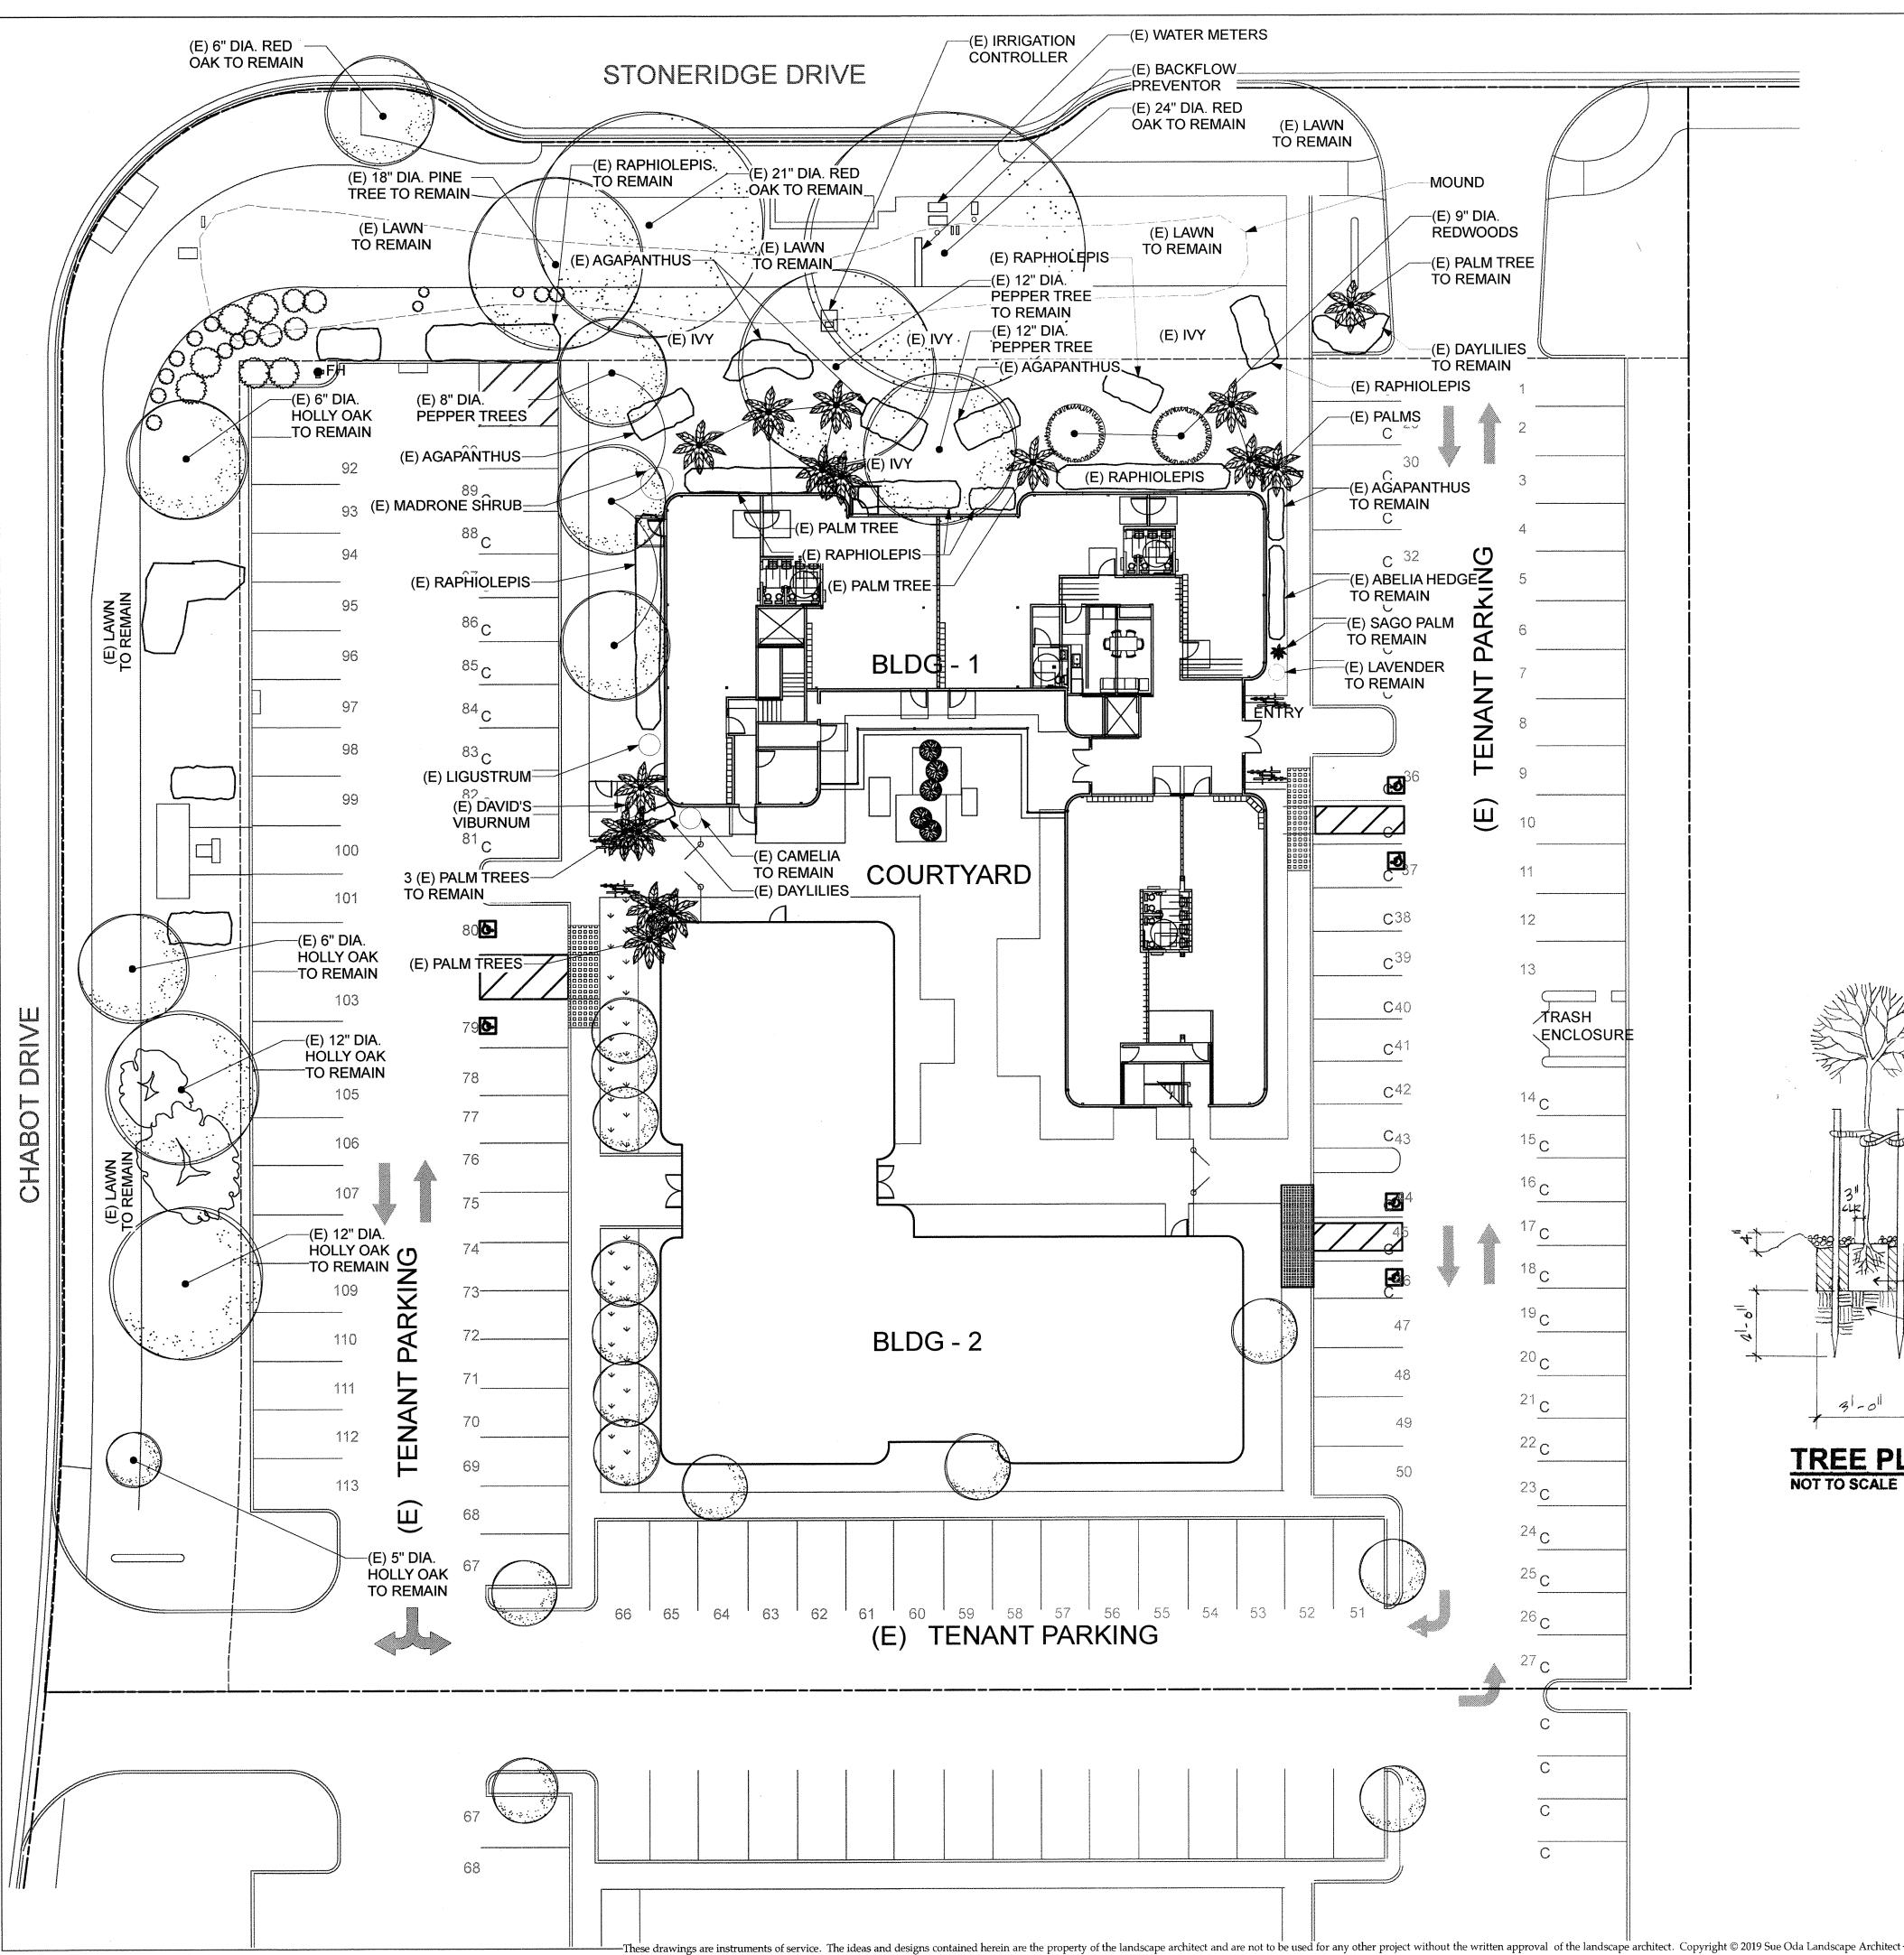

## NOTES

- 1. ALL PLANTINGS IN PLAYGROUND PAVING AREA SHALL BE REMOVED.
- 2. PLAYGROUND AREA SHALL HAVE RUBBER SAFETY FALL SURFACE.
- 3. SEE ARCHITECTURAL PLANS FOR MATERIALS AND FINISHES AT PLAYGROUND.
- 4. EXISTING WALKWAYS SHALL REMAIN.
- 5. EXISTING MOUND (BERM) AT PUBLIC SERVICE EASEMENT SHALL REMAIN.

## **GENERAL LANDSCAPE NOTES**

#### GENERAL


- 1. CONTRACTOR SHALL CONFINE HIS ACTIVITIES WITHIN THE PROJECT SITE.
- DO NOT SCALE THESE DRAWINGS. IF THESE DRAWINGS ARE NOT 24" X 36" THEY HAVE BEEN REDUCED OR ENLARGED.
- 3. ALL OMISSIONS OR CONFLICTS BETWEEN DRAWINGS, SPECIFICATIONS, AND GOVERNING CODES SHALL BE BROUGHT TO THE OWNER'S ATTENTION BEFORE STARTING THE WORK INVOLVED.
- 4. PROTECTION: THE CONTRACTOR SHALL PROTECT ALL EXISTING FEATURES TO BE RETAINED, MATERIALS AND WORK AGAINST INJURY FROM ANY CAUSE AND SHALL PROVIDE AND MAINTAIN ALL NECESSARY SAFEGUARDS FOR THE PROTECTION OF THE PUBLIC. S/HE SHALL REPAIR ANY DAMAGE CAUSED BY, OR DURING THE PERFORMANCE OF HIS WORK AT NO ADDITIONAL COST TO THE OWNER. CONTRACTOR SHALL EXERCISE CARE IN DIGGING AND OTHER WORK SO AS NOT TO DAMAGE EXISTING WORK, INCLUDING UNDERGROUND CABLES AND PIPES. SHOULD SUCH OVERHEAD OR UNDERGROUND OBSTRUCTIONS BE ENCOUNTERED THAT INTERFERE WITH HIS WORK, THE OWNER'S REPRESENTATIVE SHALL BE CONSULTED. THE CONTRACTOR SHALL BE RESPONSIBLE FOR THE IMMEDIATE REPAIR OF ANY DAMAGE CAUSED BY HIS WORK.

#### TREE PROTECTION.

- 1. PROTECT EXISTING TREES DESIGNATED AS REMAINING, FROM CONSTRUCTION ACTIVITIES. DO NOT STORE EQUIPMENT OR MATERIALS UNDER TREES.
- 2. DIRECT ALL DRAIN WATER AWAY FROM THE DRIP LINE AREA. DO NOT ALTER DRAINAGE PATTERNS UNDER DRIPLINE OF TREES TO REMAIN.
- 3. PROTECT TREE ROOTS FROM COMPACTION. NEVER PULL ROOTS WHEN CONTACTED BY CONSTRUCTION EQUIPMENT.
- 4. INSTALL TEMPORARY TREE PROTECTION FENCING AS DETAILED. TREE PROTECTION FENCING SHALL BE INSTALLED AT A MINIMUM DISTANCE FROM THE TRUNK OF THE DRIPLINE OF THE TREE. **DEMOLITION.**
- REMOVE EXISTING PLANTS AND STUMPS OR OLD ROOTBALLS THAT ARE NOT DESIGNATED AS REMAINING. PLANT REMOVAL SHALL INCLUDE ROOTBALL AS WELL AS FOLIAGE. PLANT REMOVAL SHALL BE CONFIRMED WITH OWNER'S REPRESENTATIVE PRIOR TO DEMOLITION.


#### SITE CLEAN-UP.

 REMOVE ALL SURPLUS MATERIAL AND DEBRIS FROM THE SITE UPON COMPLETION OF THE WORK.

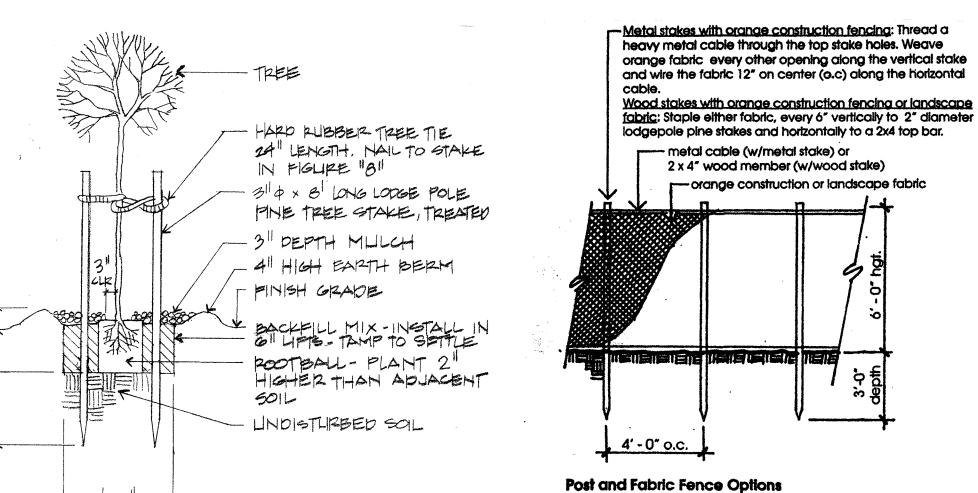

TREE PLANTING
NOT TO SCALE

TREE PROTECTION FENCING SCALE: 1/4" = 1' - 0"

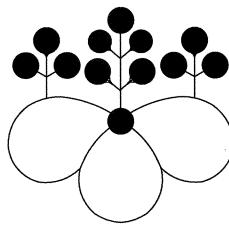

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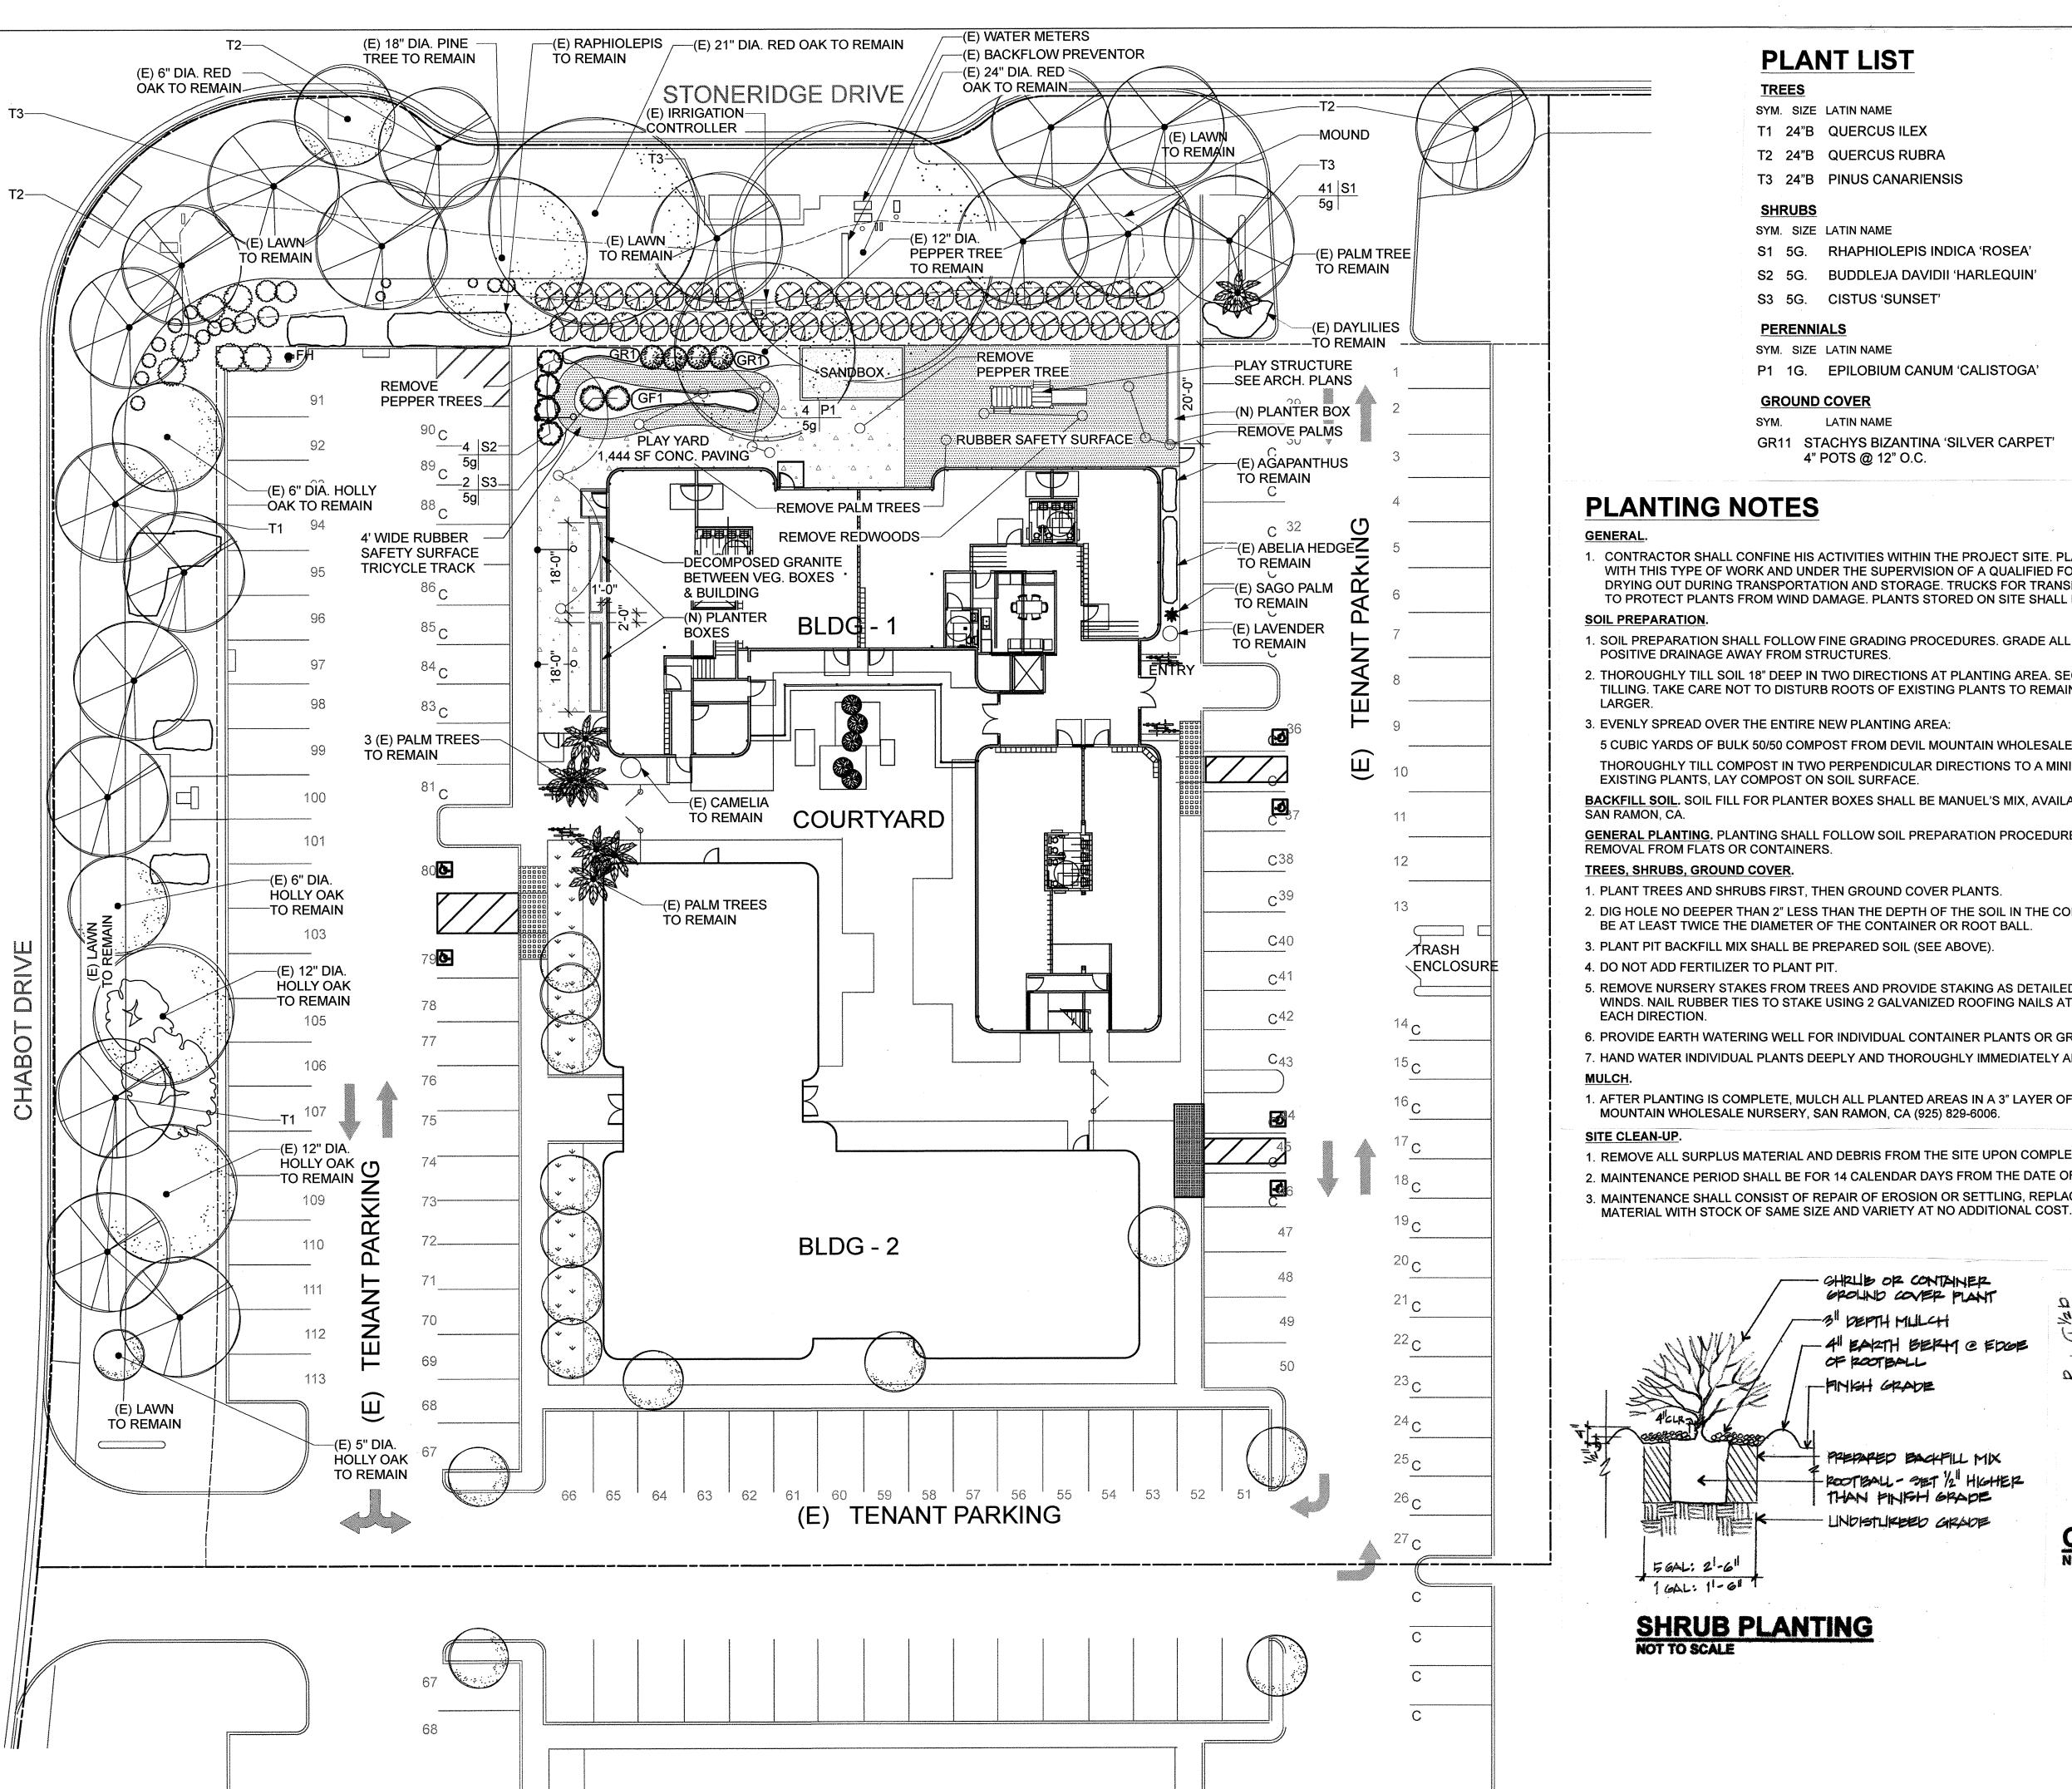
WWW.SUEODA.COM LICENSE #CLA3798

EMPIRE MONTESSORI PRESCHOOL DUTRA PLAZA BUILDING 5950 STONERIDGE DRIVE PLEASANTON, CALIFORNIA

SHEET TITLE
(E) LANDSCAPE PLAN

SCALE 1/16" = 1'-0" DATE 2/7/19

DRAWN NR CHECKED SEO



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## **PLANT LIST**

SYM. SIZE LATIN NAME **COMMON NAME** HT. X WIDTH 30' X 30' T1 24"B QUERCUS ILEX **HOLLY OAK** 60' X 40' RED OAK T2 24"B QUERCUS RUBRA

T3 24"B PINUS CANARIENSIS

SHRUBS

SYM. SIZE LATIN NAME

RHAPHIOLEPIS INDICA 'ROSEA' S2 5G. BUDDLEJA DAVIDII 'HARLEQUIN'

S3 5G. CISTUS 'SUNSET'

**PERENNIALS** 

SYM. SIZE LATIN NAME P1 1G. EPILOBIUM CANUM 'CALISTOGA'

**GROUND COVER** 

LATIN NAME GR11 STACHYS BIZANTINA 'SILVER CARPET'

4" POTS @ 12" O.C.

CALIFORNIA FUCHSIA 2' X 4'

**COMMON NAME** LAMB'S EAR

CANARY ISLAND PINE

INDIAN HAWTHORNE

SUNSET ROCKROSE

**BUTTERFLY BUSH** 

COMMON NAME

COMMON NAME

HT. X WIDTH 8" HIGH

50' X 30'

HT. X WIDTH

6' X 6'

4' X 5'

2' X 6'

HT. X WIDTH

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## **PLANTING NOTES**

1. CONTRACTOR SHALL CONFINE HIS ACTIVITIES WITHIN THE PROJECT SITE. PLANTING SHALL BE PERFORMED BY PERSONS FAMILIAR WITH THIS TYPE OF WORK AND UNDER THE SUPERVISION OF A QUALIFIED FOREMAN. PROTECT PLANTS FROM FREEZING AND DRYING OUT DURING TRANSPORTATION AND STORAGE. TRUCKS FOR TRANSPORTING PLANTS SHALL BE EQUIPPED WITH COVERS TO PROTECT PLANTS FROM WIND DAMAGE. PLANTS STORED ON SITE SHALL BE WATERED DAILY.

#### SOIL PREPARATION.

- 1. SOIL PREPARATION SHALL FOLLOW FINE GRADING PROCEDURES. GRADE ALL PLANTING AREAS FOR SMOOTH TRANSITIONS AND POSITIVE DRAINAGE AWAY FROM STRUCTURES.
- 2. THOROUGHLY TILL SOIL 18" DEEP IN TWO DIRECTIONS AT PLANTING AREA. SECOND TILLING TO BE PERPENDICULAR TO THE FIRST TILLING. TAKE CARE NOT TO DISTURB ROOTS OF EXISTING PLANTS TO REMAIN. BREAK UP OR REMOVE CLODS AND ROCKS 1" OR
- 3. EVENLY SPREAD OVER THE ENTIRE NEW PLANTING AREA:

5 CUBIC YARDS OF BULK 50/50 COMPOST FROM DEVIL MOUNTAIN WHOLESALE NURSERY, SAN RAMON, CA (925) 829-6006. THOROUGHLY TILL COMPOST IN TWO PERPENDICULAR DIRECTIONS TO A MINIMUM DEPTH OF 10". IF TILLING WILL DISTURB ROOTS OF EXISTING PLANTS, LAY COMPOST ON SOIL SURFACE.

BACKFILL SOIL. SOIL FILL FOR PLANTER BOXES SHALL BE MANUEL'S MIX, AVAILABLE AT DEVIL MOUNTAIN WHOLESALE NURSERY, SAN RAMON, CA.

**GENERAL PLANTING.** PLANTING SHALL FOLLOW SOIL PREPARATION PROCEDURES. PLANT AND WATER WITHIN 30 MINUTES OF REMOVAL FROM FLATS OR CONTAINERS.


#### TREES, SHRUBS, GROUND COVER.

- 1. PLANT TREES AND SHRUBS FIRST, THEN GROUND COVER PLANTS
- 2. DIG HOLE NO DEEPER THAN 2" LESS THAN THE DEPTH OF THE SOIL IN THE CONTAINER OR DEPTH OF SOIL BALL. THE HOLE SHALL BE AT LEAST TWICE THE DIAMETER OF THE CONTAINER OR ROOT BALL.
- 3. PLANT PIT BACKFILL MIX SHALL BE PREPARED SOIL (SEE ABOVE).
- 4. DO NOT ADD FERTILIZER TO PLANT PIT.
- 5. REMOVE NURSERY STAKES FROM TREES AND PROVIDE STAKING AS DETAILED. LOCATE STAKES PERPENDICULAR TO PREVAILING WINDS. NAIL RUBBER TIES TO STAKE USING 2 GALVANIZED ROOFING NAILS AT EACH END OF TIE. ALLOW MINIMUM 4" OF PLAY IN
- 6. PROVIDE EARTH WATERING WELL FOR INDIVIDUAL CONTAINER PLANTS OR GROUP MASSING.
- 7. HAND WATER INDIVIDUAL PLANTS DEEPLY AND THOROUGHLY IMMEDIATELY AFTER PLANTING.

1. AFTER PLANTING IS COMPLETE, MULCH ALL PLANTED AREAS IN A 3" LAYER OF BULK BLACK MINI-BARK MULCH AVAILABLE AT DEVIL MOUNTAIN WHOLESALE NURSERY, SAN RAMON, CA (925) 829-6006.

## SITE CLEAN-UP.

- 1. REMOVE ALL SURPLUS MATERIAL AND DEBRIS FROM THE SITE UPON COMPLETION OF THE WORK.
- 2. MAINTENANCE PERIOD SHALL BE FOR 14 CALENDAR DAYS FROM THE DATE OF COMPLETION AND OWNER'S ACCEPTANCE.
- 3. MAINTENANCE SHALL CONSIST OF REPAIR OF EROSION OR SETTLING, REPLACING DEAD OR DYING OR DISEASED PLANT

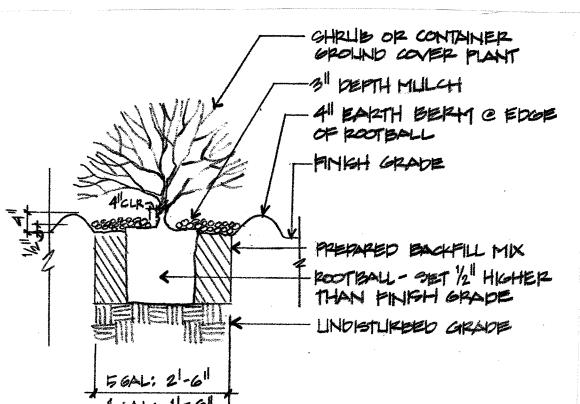


- CUPB, WALK, BUILDING, OF PLANTING EDGE D= SPACING DISTANCE SPECIFIED

**GROUND COVER PLANTING** 


SHRUB PLANTING
NOT TO SCALE

EMPIRE MONTESSORI PRI DUTRA PLAZA BUILDING 5950 STONERIDGE DRIVE PLEASANTON, CALIFORNIA SHEET TITLE (N) PLANTING PLAN

1/16" = 1'-0" DATE 2/19/19 HEET L2

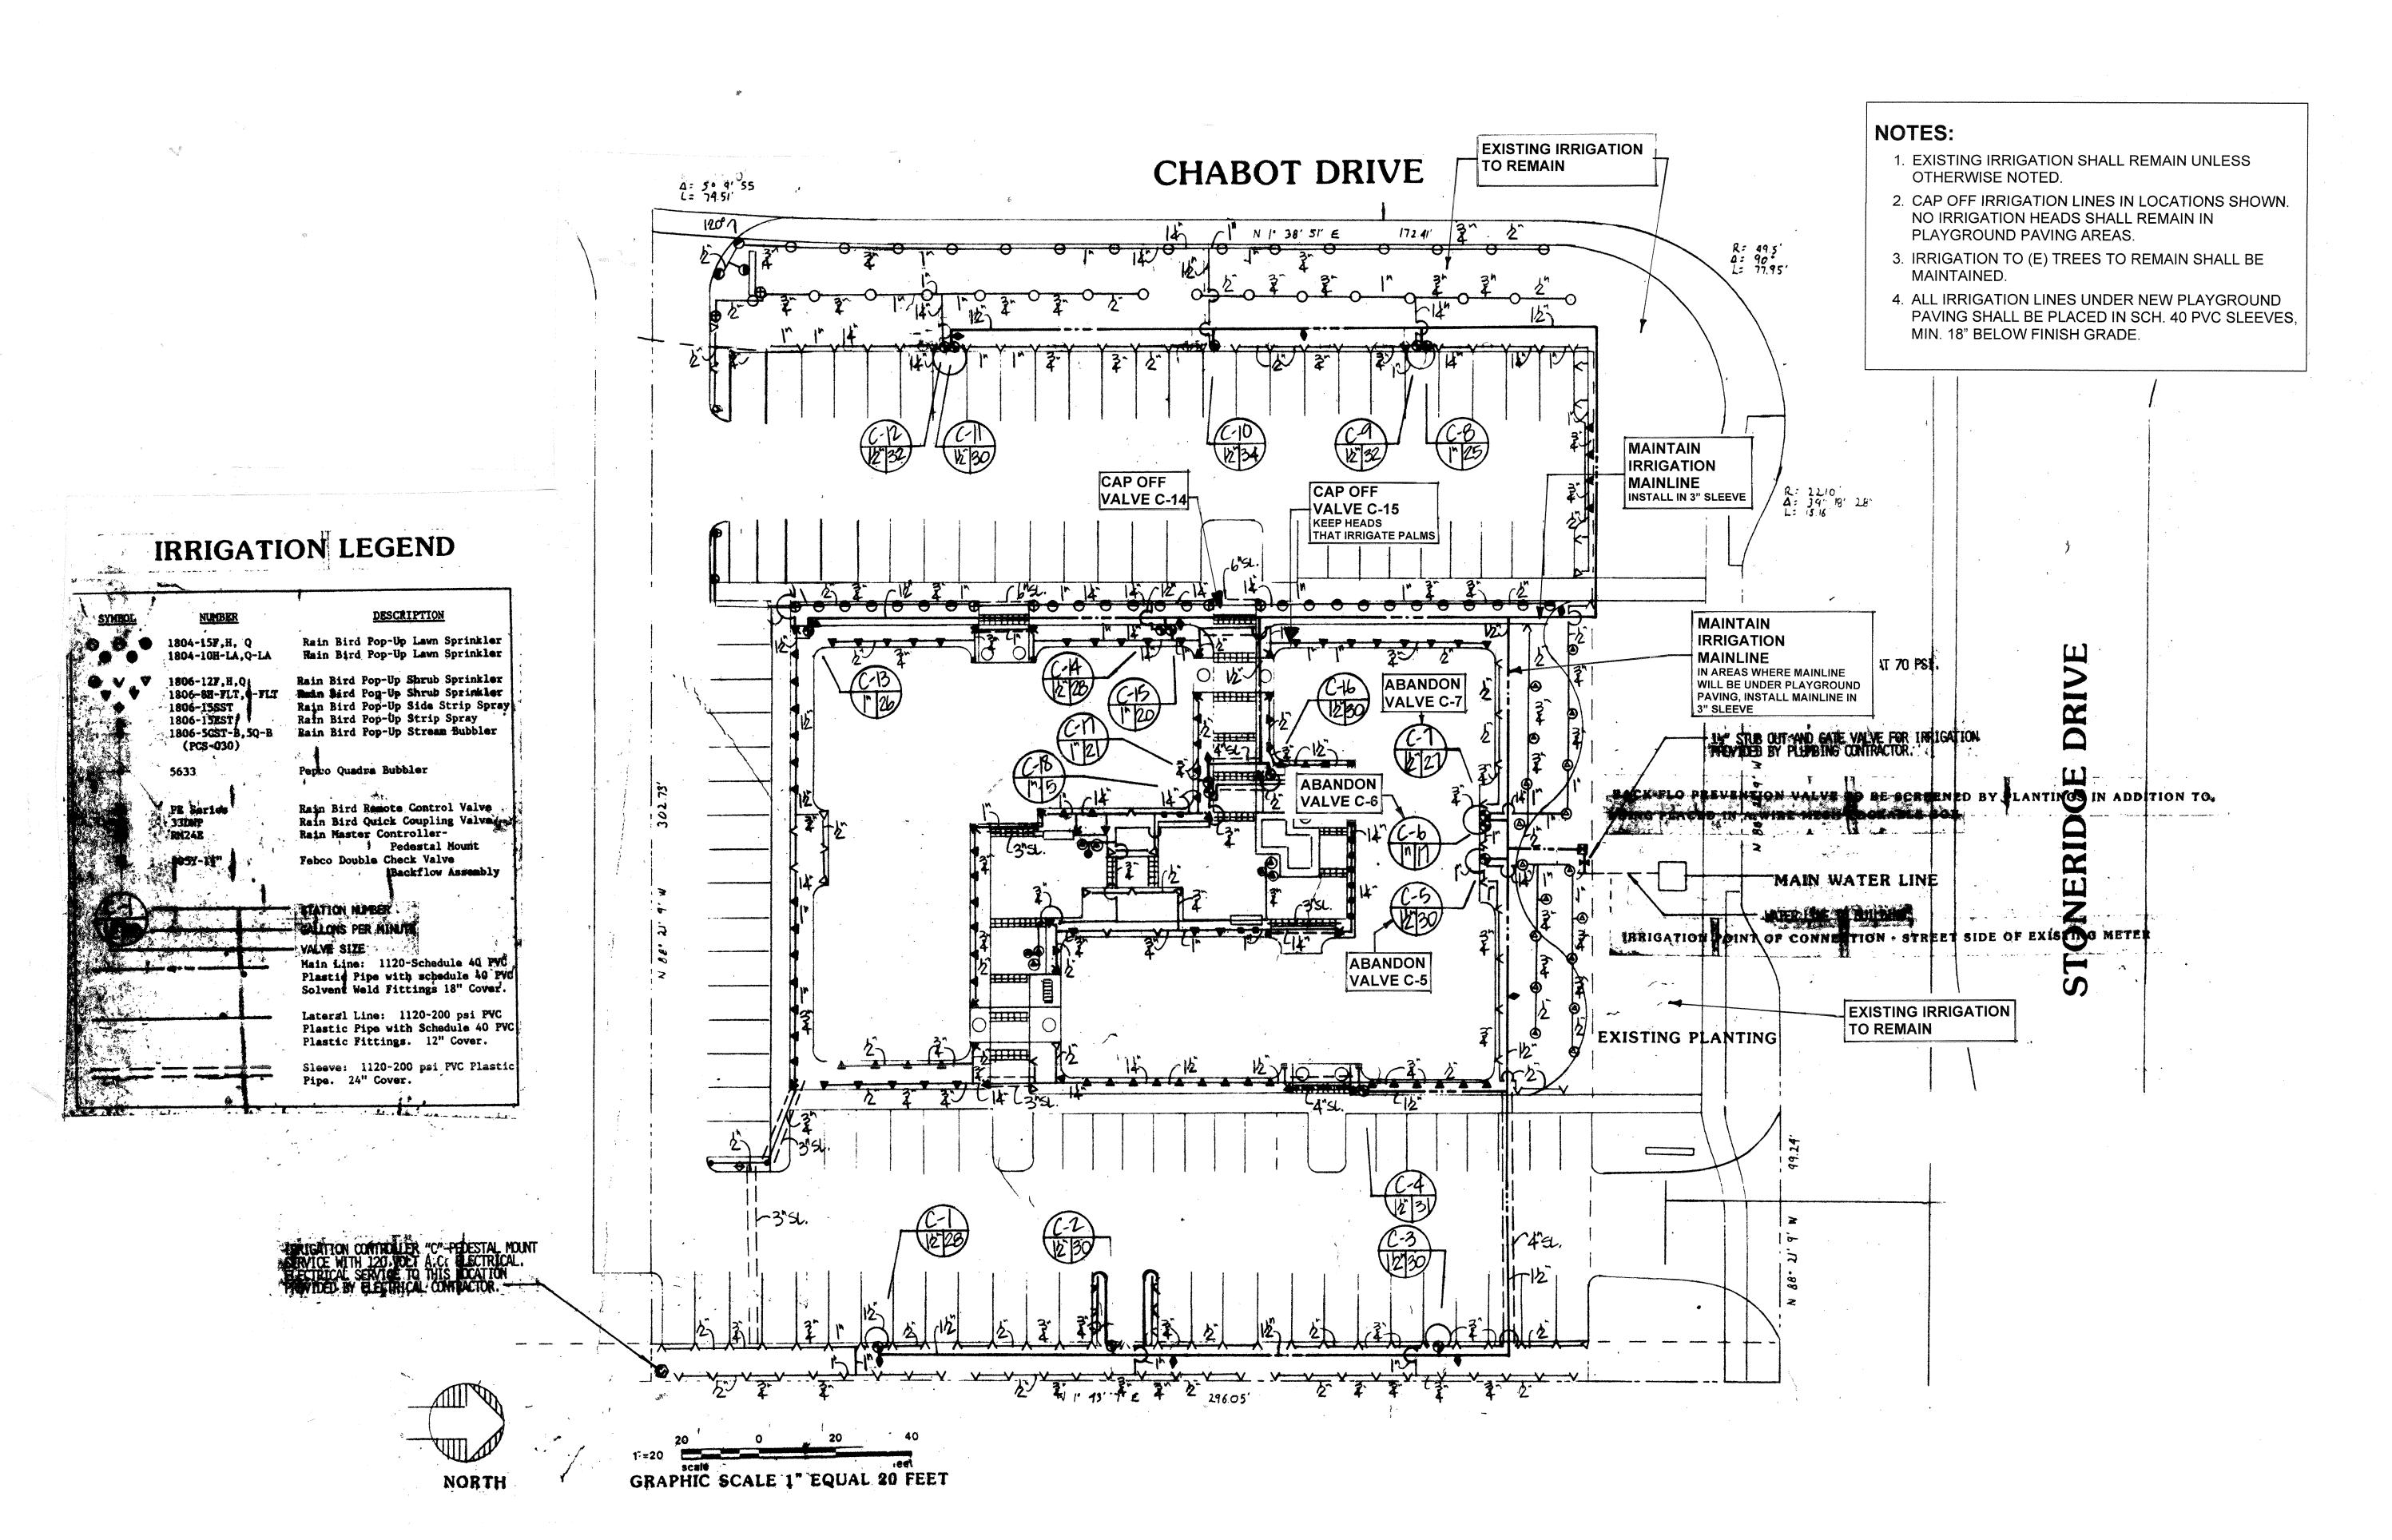

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RE MONTESSORI PRESCHOOL A PLAZA BUILDING

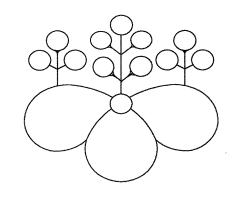EMPIF

SHEET TITLE


MODIFICATION TO

(E) IRRIGATION

SCALE 1/4" = 1' - 0" DATE 1/10/19

DRAWN SEO CHECKED

SHEET L3 OF 7 SHEET

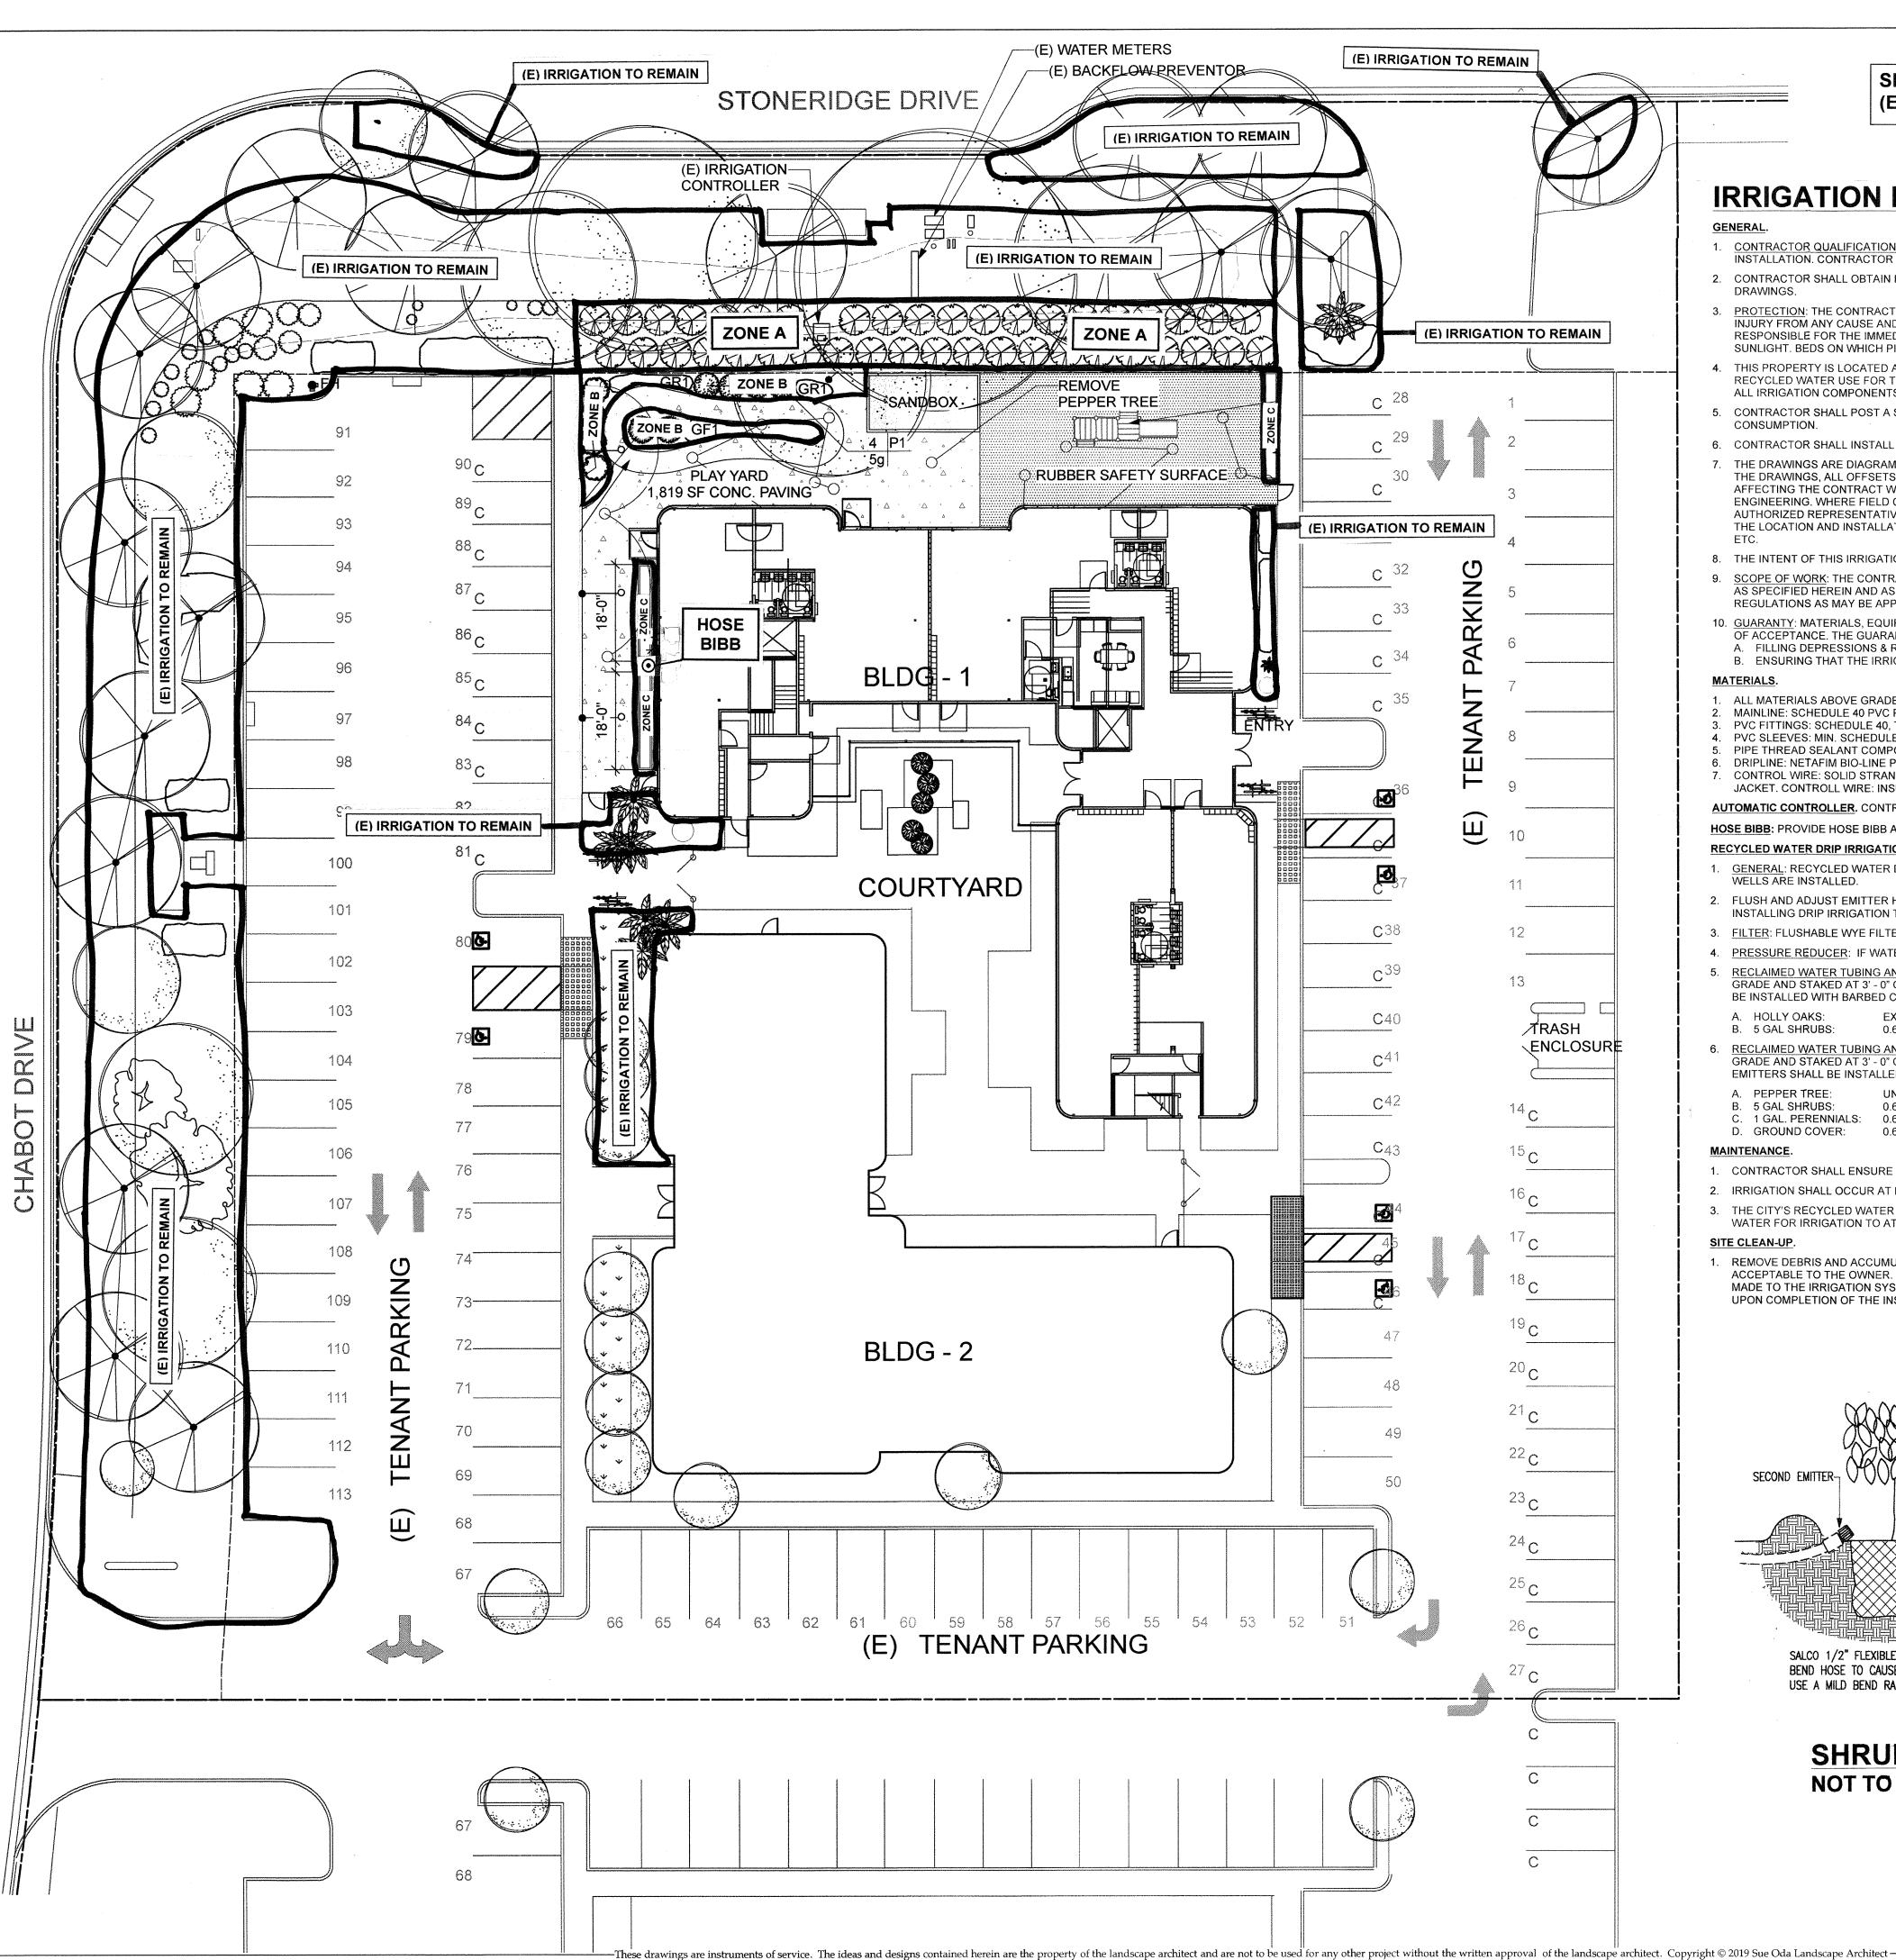

### SEE SHEET L3 FOR MODIFICATION TO (E) IRRIGATION VALVES AND LINES.

# **IRRIGATION NOTES**

- 1. CONTRACTOR QUALIFICATIONS: THIS AUTOMATIC IRRIGATION SYSTEM SHALL BE INSTALLED BY AN EXPERIENCED FIRM, REGULARLY ENGAGED IN IRRIGATION INSTALLATION. CONTRACTOR SHALL HAVE A MINIMUM OF THREE YEARS OF SUCCESSFUL EXPERIENCE WITH INSTALLATIONS.
- 2. CONTRACTOR SHALL OBTAIN PERMITS REQUIRED AND PROVIDE LABOR AND MATERIALS NECESSARY TO FULLY COMPLETE THE WORK IN ACCORDANCE WITH THE
- PROTECTION: THE CONTRACTOR SHALL LOCATE AND PROTECT NEW AND EXISTING UTILITIES PRIOR TO EXCAVATION. PROTECT ALL MATERIALS AND WORK AGAINST INJURY FROM ANY CAUSE AND SHALL PROVIDE AND MAINTAIN ALL NECESSARY SAFEGUARDS FOR THE PROTECTION OF THE PUBLIC. THE CONTRACTOR SHALL BE RESPONSIBLE FOR THE IMMEDIATE REPAIR OF ANY DAMAGE CAUSED BY HIS WORK. THIS ALSO APPLIES TO LAWN AREAS. DO NOT STORE PVC PIPE IN DIRECT SUNLIGHT. BEDS ON WHICH PIPE ARE STORED MUST EXTEND FULL LENGTH OF PIPE.
- 4. THIS PROPERTY IS LOCATED ALONG THE CITY'S RECYCLED WATER DISTRIBUTION SYSTEM. LANDSCAPE IRRIGATION IN THE PROJECT AREA SHALL CONVERT TO RECYCLED WATER USE FOR THE IRRIGATION AT THIS SITE. CONTRACTOR SHALL CONNECT NEW IRRIGATION TO EXISTING RECYCLED WATER IRRIGATION SYSTEM. ALL IRRIGATION COMPONENTS SHALL HAVE PURPLE INDICATORS TO INDICATE USE OF RECLAIMED WATER.
- 5. CONTRACTOR SHALL POST A SIGN ON THE PROPERTY INDICATING THAT RECYCLED WATER IS IN USE AND IS NOT APPROPRIATE FOR HUMAN OR ANIMAL CONSUMPTION.
- 6. CONTRACTOR SHALL INSTALL IRRIGATION SYSTEM SO THAT NO IRRIGATION COMES IN CONTACT WITH THE CHILDREN'S PLAY STRUCTURES.
- 7. THE DRAWINGS ARE DIAGRAMMATIC. EQUIPMENT SHOWN IN PAVING IS FOR CLARITY ONLY INSTALL IN PLANTING AREAS WHERE POSSIBLE. DUE TO THE SCALE OF THE DRAWINGS, ALL OFFSETS, FITTINGS, SLEEVES, ETC. WHICH MAY BE REQUIRED ARE NOT INDICATED. INVESTIGATE THE STRUCTURAL AND FINISHED CONDITIONS AFFECTING THE CONTRACT WORK INCLUDING OBSTRUCTIONS, GRADE DIFFERENCES OR AREA DIFFERENCES THAT MAY HAVE NOT BEEN CONSIDERED IN THE ENGINEERING. WHERE FIELD CHANGES EXIST, COORDINATE THE INSTALLATION WORK ACCORDINGLY BY NOTIFICATION AND SPPROVAL OF THE OWNER'S AUTHORIZED REPRESENTATIVE AS PER THE CONTRACT SPECIFICATIONS. COORDINATE IRRIGATION CONTRACT WORK WITH ALL APPLICABLE CONTRACTORS FOR THE LOCATION AND INSTALLATION OF PIPE, CONDUIT, OR SLEEVES OF PIPE, CONDUIT OR SLEEVES THROUGH OR UNDER WALLS, ROADWAYS, PAVING, STRUCTURE,
- 8. THE INTENT OF THIS IRRIGATION SYSTEM DESIGN IS TO PROVIDE THE MINIMUM AMOUNT OF WATER REQUIRED TO SUSTAIN GOOD PLANT HEALTH
- 9. SCOPE OF WORK: THE CONTRACTOR SHALL PROVIDE ALL LABOR, MATERIALS, AND EQUIPMENT FOR A COMPLETE OPERATING UNDERGROUND IRRIGATION SYSTEM AS SPECIFIED HEREIN AND AS SHOWN ON THE DRAWINGS. WORK AND MATERIALS SHALL CONFORM TO ALL CURRENT STATE AND LOCAL LAWS, RULES, CODES OR
- 10. GUARANTY: MATERIALS, EQUIPMENT, AND WORKMANSHIP FURNISHED UNDER THIS CONTRACT SHALL BE GUARANTEED FOR A PERIOD OF ONE YEAR FROM THE DATE OF ACCEPTANCE. THE GUARANTY SHALL INCLUDE BUT NOT BE LIMITED TO THE FOLLOWING:
- A. FILLING DEPRESSIONS & REPLACING PLANTS DUE TO SETTLEMENT OF IRRIGATION TRENCHES. B. ENSURING THAT THE IRRIGATION SYSTEM HAS BEEN ADJUSTED TO SUPPLY PROPER WATER COVERAGE OF AREAS DESIGNED TO RECEIVE WATER.

- 1. ALL MATERIALS ABOVE GRADE SHALL HAVE PURPLE INDICATORS. 2. MAINLINE: SCHEDULE 40 PVC PIPE.
- PVC FITTINGS: SCHEDULE 40, TYPE 1, NSF APPROVED.
- 4. PVC SLEEVES: MIN. SCHEDULE 40 PVC.
- PIPE THREAD SEALANT COMPOUND: PERMATEX 51 OR RECTOR SEAL T+2.
- DRIPLINE: NETAFIM BIO-LINE PRESSURE COMPENSATING DRIPLINE WITH ROOT BARRIER.
- CONTROL WIRE: SOLID STRAND COPPER WITH U.L. APPROVAL FOR DIRECT BURIAL IN GROUND, SIZE AWG-UF #14-1. COMMON GROUND WIRE: WHITE INSULATING JACKET. CONTROLL WIRE: INSULATING JACKET OF COLOR OTHER THAN WHITE. SPLIES: MADE WITH 3M-DBY-SEAL PACKS.

**AUTOMATIC CONTROLLER. CONTRACTOR SHALL USE EXISTING CONTROLLER. NEW IRRIGATION** 

#### HOSE BIBB: PROVIDE HOSE BIBB AT PLANTER BOX AS SHOWN.


#### RECYCLED WATER DRIP IRRIGATION.

- 1. GENERAL: RECYCLED WATER DRIP IRRIGATION TUBING AND EMITTERS SHALL BE INSTALLED ONLY AFTER PLANTING AND FINISH GRADING IS COMPLETE, WATERING
- 2. FLUSH AND ADJUST EMITTER HEADS FOR EFFICIENT PERFORMANCE. PREVENT WATER ON THE WALKS AND PAVEMENT. FLUSH SOLID WALL PVC PIPE PRIOR TO INSTALLING DRIP IRRIGATION TUBING. PROVIDE EMACULATE CONNECTIONS AT ALL TIMES TO PREVENT PARTICLES FROM CLOGGING TUBING AND EMITTERS.
- 3. <u>FILTER</u>: FLUSHABLE WYE FILTER SHALL HAVE A MINIMUM OF 200 MESH SCREEN.
- 4. PRESSURE REDUCER: IF WATER PRESSURE AFTER FILTER EXCEEDS 25 PSI, PROVIDE PRESSURE REDUCER SET TO 25 PSI.
- 5. RECLAIMED WATER TUBING AND EMITTERS OUTSIDE OF CHILDREN'S PLAY AREA: DRIP TUBING OUTSIDE OF CHILDREN'S PLAY AREA SHALL BE LAID ON THE FINISHED GRADE AND STAKED AT 3' - 0" O.C. WITH DRIP TUBING STAKES, DO NOT PINCH TUBING WITH STAKES. PROVIDE FLUSH VALVE AT END OF EACH LINE. EMITTERS SHALL BE INSTALLED WITH BARBED CONNECTORS AND PLACED ABOVE ROOT ZONE OF PLANT, BUT NOT AGAIST TRUNK OR STEM, AS FOLLOWS:
- EXISTING IRRIGATION TO THIS AREA SHALL REMAIN A. HOLLY OAKS: B. 5 GAL SHRUBS: 0.6 GPH DRIPLINE 24" SPACING
- RECLAIMED WATER TUBING AND EMITTERS INSIDE CHILDREN'S PLAY AREA: DRIP TUBING INSIDE OF CHILDREN'S PLAY AREA SHALL BE INSTALLED 4" BELOW FINISH GRADE AND STAKED AT 3' - 0" O.C. WITH DRIP TUBING STAKES, DO NOT PINCH TUBING WITH STAKES. PROVIDE FLUSH VALVE AT GRADE AT THE END OF EACH LINE. EMITTERS SHALL BE INSTALLED WITH BARBED CONNECTORS AND PLACED AT ROOT BALL OF PLANT, AS FOLLOWS:
- UNDERGROUND DRIPLINE TREE RING
- 0.6 GPH DRIPLINE, 18" SPACING B. 5 GAL SHRUBS:
- C. 1 GAL. PERENNIALS: 0.6 GPH DRIPLINE, 18" SPACING D. GROUND COVER: 0.6 GPH DRIPLINE, 12" SPACING

- 1. CONTRACTOR SHALL ENSURE ALL LANDSCAPE AND IRRIGATION MAINTENANCE PROFESSIONALS KNOW THAT RECLAIMED WATER IS BEING USED ON THE PROPERTY.
- 2. IRRIGATION SHALL OCCUR AT NIGHT WHEN CHILDREN ARE NOT PRESENT
- 3. THE CITY'S RECYCLED WATER PROGRAM REQUIRES AT LEAST ONE PERMANENT STAFF MEMBER OF A CHILDCARE BUSINESS ON A PROPERTY USING RECYCLED WATER FOR IRRIGATION TO ATTEND THE CITY'S NO COST RECYCLED WATER TRAINING WORKSHOP (2 HOURS).

## SITE CLEAN-UP.

REMOVE DEBRIS AND ACCUMULATION OF DEBRIS AS A RESULT OF IRRIGATION CONSTRUCTION FROM THE SITE AND LEAVE AREA IN A CLEAN CONDITION ACCEPTABLE TO THE OWNER. AS-BUILT DRAWINGS - DURING THE COURSE OF THE INSTALLATION, THE IRRIGATION CONTRACTOR SHALL RECORD ALL CHANGES MADE TO THE IRRIGATION SYSTEM DURING INSTALLATION. CHANGES SHALL BE CAREFULLY DRAWN IN RED LINE ON A PRINT OF THE IRRIGATION SYSTEM DRAWING. UPON COMPLETION OF THE INSTALLATION, THIS RED LINE DRAWING SHALL BE GIVEN TO THE OWNER FOR USE AS AN AS-BUILT DRAWING.

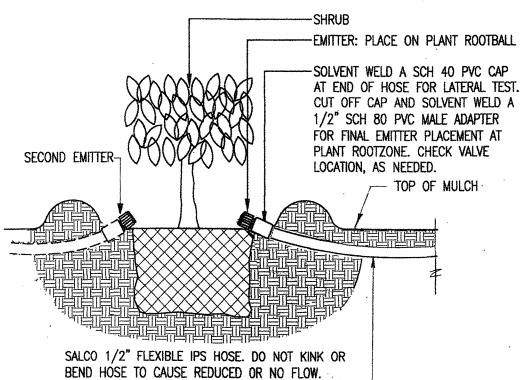

UNDERGROUND AUTOMATIC DRIP IRRIGATION W/ RECYCLED WATER

**IRRIGATION ZONE KEY** 

MODERATE WATER FLOW ZONE B: UNDERGROUND AUTOMATIC DRIP IRRIGATION W/ RECYCLED WATER

LOW WATER FLOW ZONE C: HAND WATER AT CHILDREN'S

PLANTER BOXES

SHRUB EMITTER NOT TO SCALE

USE A MILD BEND RADIUS. —

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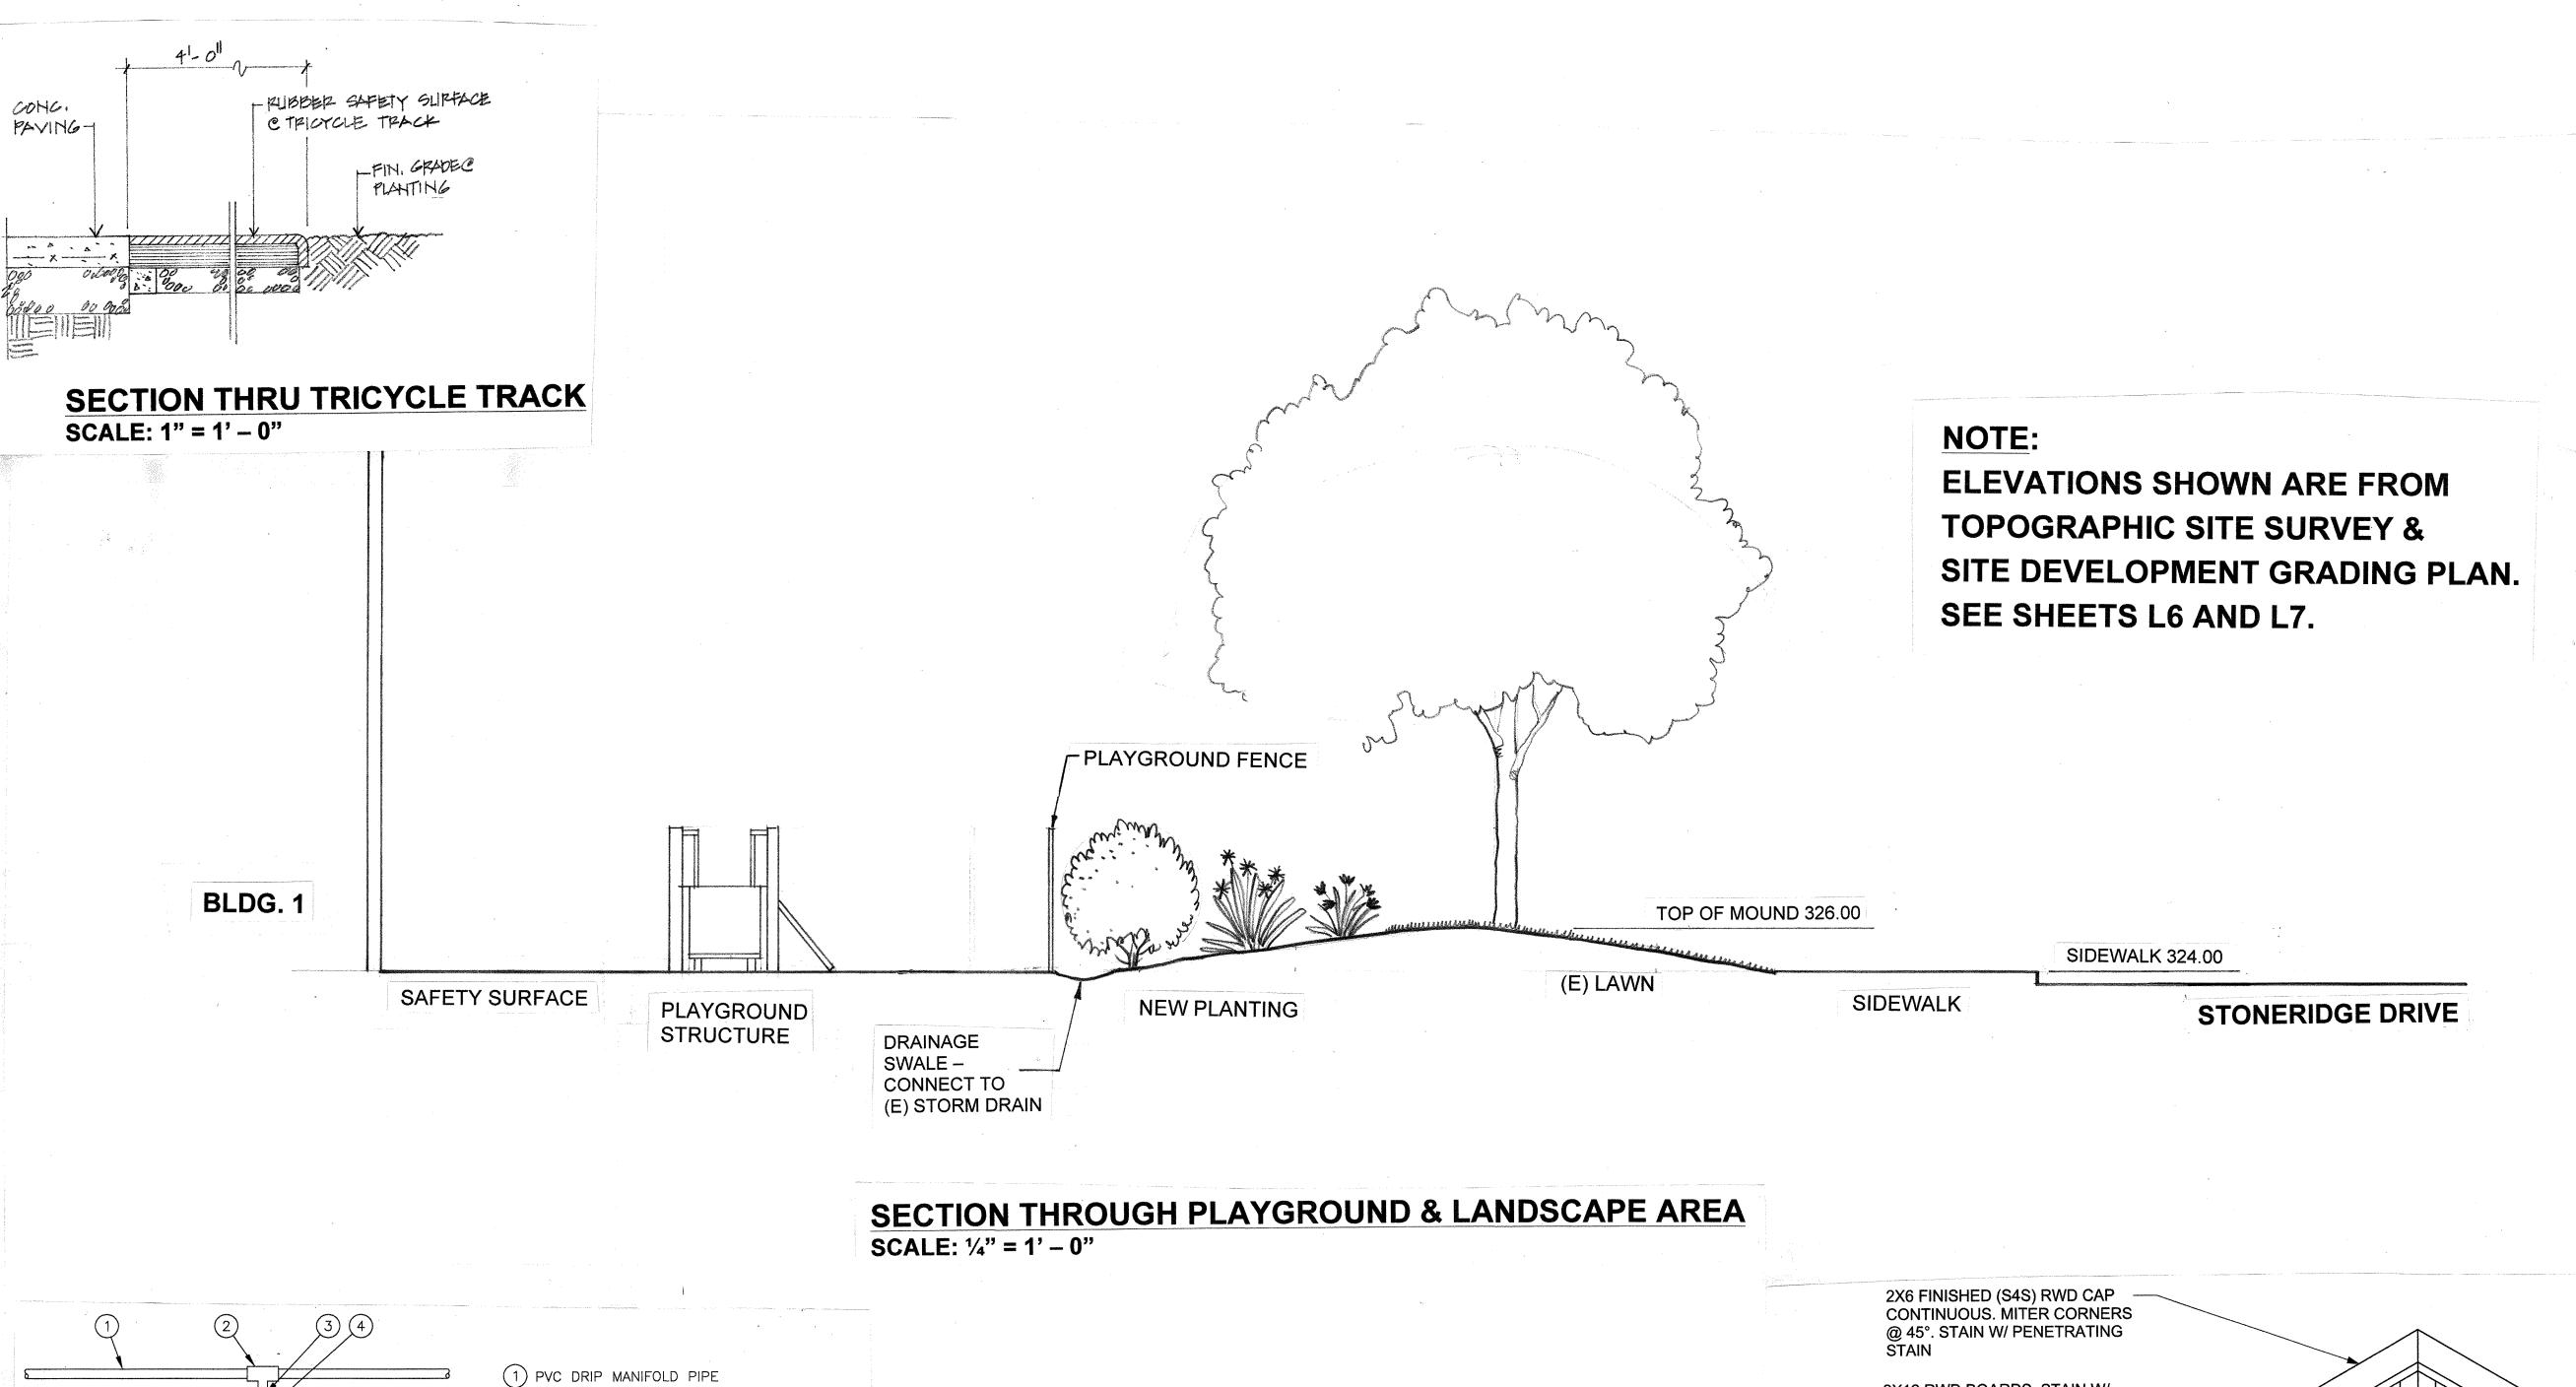
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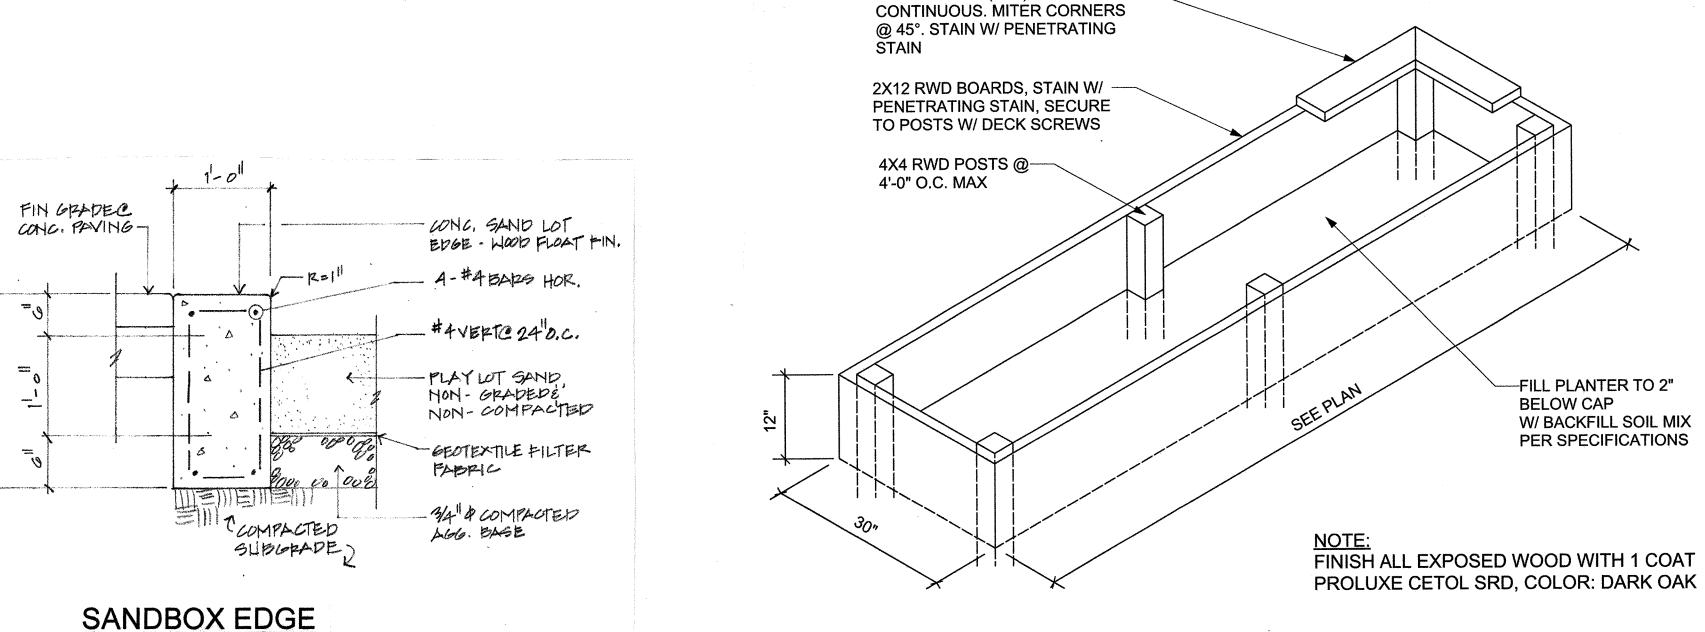
(N) IRRIGATION PLAN

1/16" = 1'-0"



SCALE: 1'' = 1' - 0''

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MONTESSORI PRESCHOOL AZA BUILDING DGE DRIVE CALIFORNIA LANDSCAPE SECTION AND DETAILS ALE 1/4" = 1' - 0"

L5 <sub>OF</sub>

-FILL PLANTER TO 2"

W/ BACKFILL SOIL MIX

PER SPECIFICATIONS

BELOW CAP

RAISED REDWOOD PLANTER (STAINED)

SCALE: 3/4" = 1'-0"

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**DRIP RING TO TREE** NOT TO SCALE

AND FIVE FEET IN CLAY.

1. DISTANCE BETWEEN LATERAL RINGS AND EMITTER SPACING TO BE BASED ON

3. AT FITTINGS WHERE THERE IS A CHANGE OF DIRECTION SUCH AS TEES OR ELBOWS, USE TIE-DOWN STAKES ON EACH LEG OF THE CHANGE OF

BIRD WEB SITE (WWW.RAINBIRD.COM) FOR SUGGESTED SPACING. 2. PLACE TIE DOWN STAKES EVERY THRÉE FEET IN SAND, FOUR FEET IN LOAM,

SOIL TYPE, AND TREE CANOPY. SEE INSTALLATION SPECIFICATIONS ON RAIN

2 PVC SCH 40 TEE OR EL

5 BARB TEE INSERT FITTING:

8 ROOT BALL

9 TIE DOWN STAKE:

RAIN BIRD XFF-TEE

6 PROJECTED CANOPY LINE OF TREE

7 ON-SURFACE DRIPLINE:
RAIN BIRD XF SERIES DRIPLINE

POTABLE: XFCV DRIPLINE


(QUANTITY AS REQUIRED,

SEE NOTES 2-3 BELOW)


RAIN BIRD TDS-050 WITH BEND

PLACE AS SHOWN (LENGTH AS REQUIRED)

3 ½" POLYETHYLENE TUBING:
RAIN BIRD XF SERIES BLANK TUBING
BARB CROSS INSERT FITTING:
RAIN BIRD XFD—CROSS

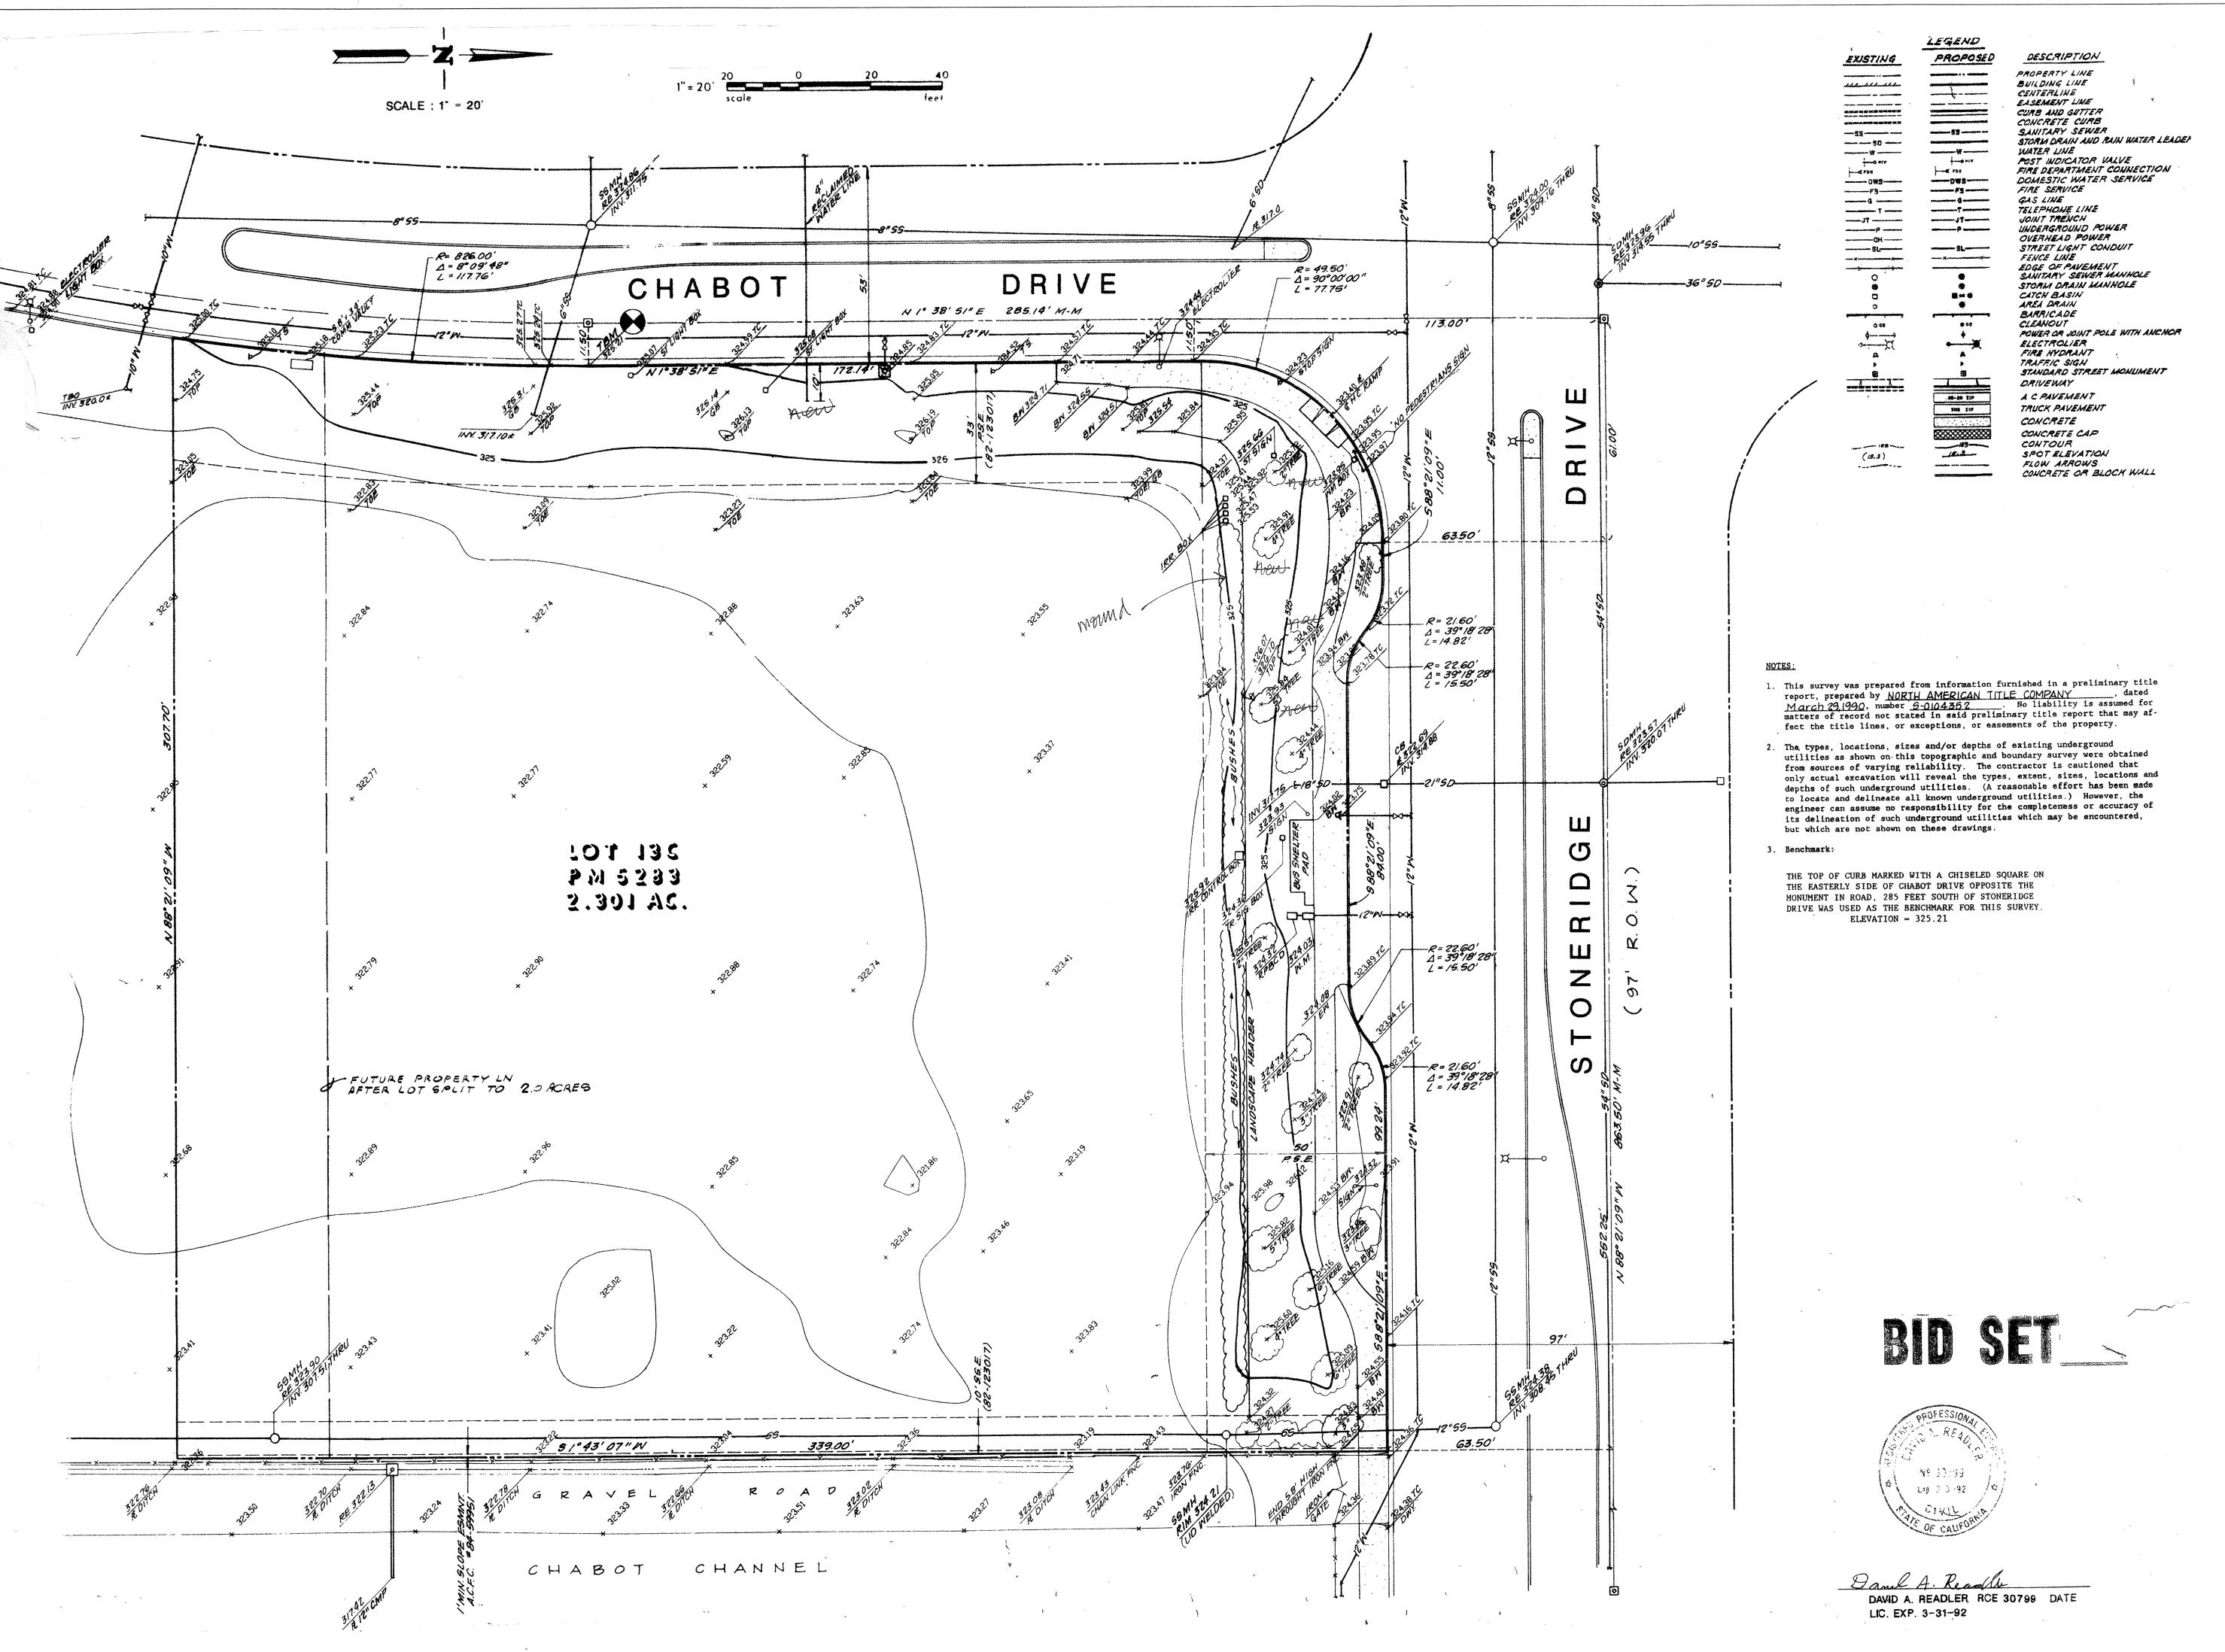

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回回

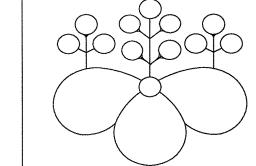SHEET TITLE

TOPOGRAPHIC SURVEY

SCALE 1/4" = 1' - 0"		1/10/19 DATE	
DRAWN	SEO	CHE	CKED
SHEET	L6	OF	7 <sub>SHEETS</sub>

